

# MATERIALS LEGEND

	EARTH		CONTINUOUS WOOD BLOCKING
	CONCRETE		WOOD BLOCKING
	COMPACTED FILL		BRICK
	GYPSUM BOARD/ PLASTER		CONCRETE BLOCK
	BATT INSULATION		STONE
	PLYWOOD		EXISTING MATERIAL

# WRC BIRCHES WINDOW REPLACEMENT

WOODWARD, IA 50276

DAS PROJECT No. 9463.00  
GENESIS PROJECT No. 2501

# SYMBOLS LEGEND

	SECTION LABEL SHEET NUMBER		COLUMN GRID LINE
	DETAIL NUMBER SHEET NUMBER		ROOM NUMBER
	OPENING NUMBER		ROOM NAME
	NEW FINISH GRADE CONTOURS		FOOTING SIZE FOOTING ELEVATION
	UNCHANGED EXISTING GRADES		BENCH MARK
	ALTERED EXISTING GRADES		ELEVATION IN SECTION
			NEW ELEVATION
			EXISTING ELEVATION

# ABBREVIATIONS

A.C.T. ACOUSTICAL CEILING TILE	E.A. EACH	INSUL. INSULATION	P.V. PLUMBING VENT	T.B. TACK BOARD
ADJ. ADJUSTABLE	E.J. EXPANSION JOINT	INT. INTERIOR	P.V.C. POLYVINYL CHLORIDE	TEL. TELEPHONE
A.F.F. ABOVE FINISHED FLOOR	E.J.F. EXPANSION JOINT FILLER	JT. JOINT	Q.T. QUARRY TILE	T.O.C. TOP OF CURB, TOP OF CONCRETE
ALUM. ALUMINUM	ELEC. ELECTRICAL	KIT. KITCHEN	R. RISER	T.O.W. TOP OF WALL
APPROX. APPROXIMATELY	ELEV. ELEVATION	K.W. KEYWALL	RAD. RADIUS	T.P.H. TOILET PAPER HOLDER
ASP. T. ASPHALT TILE	ENCL. ENCLOSURE	LAV. LAVATORY	R.C.J. ROOF CONTROL JOINT	TR. TRANSOM
BD. BOARD	EQ. EQUAL	L.B. POUND	R.C.M.U. REINFORCED CONCRETE MASONRY UNIT	T.W.F. THROUGH WALL FLASHING
BLDG. BUILDING	EQUIP. EQUIPMENT	L.M. LAVATORY MIRROR	R.D. ROOF DRAIN	TYP. TYPICAL
BLK. BLOCK	EX. EXISTING	L.V.R. LOUVER	REBAR REINFORCING BAR	U.N.O. UNLESS NOTED OTHERWISE
BRK. BRICK	EXT. EXTERIOR	L.W. LIGHT WEIGHT	REF. REFERENCE	V.A.T. VINYL ASBESTOS TILE
BN. BULL-NOSED	EXP. EXPOSED OR EXPANSION	L.V. MAGNET(IC)	REFR. REFRIGERATOR	V.B. VINYL BASE
CAB. CABINET	F.C.J. FLOOR CONTROL JOINT	MAS. MASONRY	REFR. REFRIGERATOR	V.C.T. VINYL COMPOSITION TILE
C.B. CHALKBOARD	F.D. FLOOR DRAIN	MAX. MAXIMUM	REINF. REINFORCED	VERT. VERTICAL
C.C. CENTER TO CENTER	FDN. FOUNDATION	M.B. MARKER BOARD	R.E.J. ROOF EXPANSION JOINT	VEST. VESTIBULE
CHNL. CHANNELS	F.E. FIRE EXTINGUISHER	MECH. MECHANICAL	REQ'D. REQUIRED	VTR. VENT THROUGH ROOF
C.J. CONTROL JOINT	F.E.C. FIRE EXTINGUISHER CABINET	MET. METAL	RM. ROOM	V.W.C. VINYL WALL COVERING
CL. CENTER LINE	F.E.J. FLOOR EXPANSION JOINT	MFR. MANUFACTURER	R.O. ROUGH OPENING	W. WIDTH
CLG. CEILING	FIN. FINISH	MIN. MINIMUM	R.T.S. REINFORCED TERMINATION STRIP	W/O. WITHOUT
CLO. CLOSET	FLR. FLOOR	MISC. MISCELLANEOUS	R.V. ROOF VENT	W.C. WATER CLOSET OR WATER COOLER
CL.RM. CLASSROOM	F.L.M. FULL LENGTH MIRROR	M.O. MASONRY OPENING	SCHED. SCHEDULE	W.C.J. WALL CONTROL JOINT
CMU. CONCRETE MASONRY UNIT	FLUOR. FLUORESCENT	M.O.L. MIRROR OVER LAV.	S.C. SOLID CORE	WD. WOOD
CONC. CONCRETE	F.O. FINISH OPENING	MTD. MOUNTED	S.D. SOAP DISPENSER	WDW. WINDOW
CONT. CONTINUOUS	FR. FRAME	N.I.C. NOT IN CONTRACT	SECT. SECTION	W.E.J. WALL EXPANSION JOINT
CORR. CORRIDOR	F.S. FLOOR SINK	NO. NUMBER	S.F. SQUARE FOOT OR FEET	WGT. WEIGHT
CPT. CARPET	FT. FOOT OR FEET	NOM. NOMINAL	SHR. SHOWER	W.P. WATERPROOFING
CRS. COURSES	FTG. FOOTING	N.T.S. NOT TO SCALE	SHT. SHEET	W.R. WASTE RECEPTACLE
C.T. CERAMIC TILE	GA. GAUGE	O.C. ON CENTER	SIM. SIMILAR	W.W.F. WELD WIRE FABRIC
CTR. CENTER	GALV. GALVANIZED	OFF. OFFICE	S.L. SIDELIGHT	
D. DEPTH	G.B. GRAB BAR	OPNG. OPENING	S.N.D. SANITARY NAPKIN DISPOSAL	
DBL. DOUBLE	GL. GLASS	OS. OUTSIDE	SPEC. SPECIFICATION	
DET. DETAIL	GND. GROUND	PL. PLATE	SQ. SQUARE	
D.F. DRINKING FOUNTAIN	GYP. GYPSUM	PLAM. PLASTIC LAMINATE	S.S. STAINLESS STEEL	
DIA. DIAMETER	GYP. BD. GYPSUM BOARD	PLYWD. PLYWOOD	STAT. STATIONARY	
DIM. DIMENSION	H. HEIGHT	PNL. PANEL	STD. STANDARD	
DISP. DISPENSER	H.B. HOSE BIB	PR. PAIR	STL. STEEL	
DN. DOWN	HDWE. HARDWARE	PROT. PROTECTION	S.T.M. SOAP, TOWEL DISPENSERS & MIRROR	
DO. REPEAT	H.M. HOLLOW METAL	PTN. PARTITION	STOR. STORAGE	
DR. DOOR	HORIZ. HORIZONTAL		SUSP. SUSPENDED	
DRS. DOORS	HR. HOUR	T. TREAD		
D.S. DOWNSPOUT	IAW IS. IN ACCORDANCE WITH INSIDE	T & B TOP AND BOTTOM		
DWG. DRAWING		T & G TONGUE AND GROOVE		
DWR. DRAWER				


# CONTACT INFORMATION

**OWNERS:**  
STATE OF IOWA  
DEPARTMENT OF ADMINISTRATIVE SERVICES  
109 SE 13TH STREET  
DES MOINES, IOWA 50319

**CONSTRUCTION MANAGER:**  
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DARREN MILLIKEN, PROJECT MANAGER  
2810 WAKEFIELD CIRCLE  
AMES, IA 50010  
OFFICE: 515. 291.5358

**CLIENT:**  
WOODWARD RESOURCE CENTER  
1251 334TH STREET  
WOODWARD, IA 50276

**ARCHITECT:**  
GENESIS ARCHITECTURAL DESIGN  
EDWARD MATT, AIA PROJECT ARCHITECT  
939 OFFICE PARK ROAD, SUITE 101  
WEST DES MOINES, IA 50265-2505  
OFFICE: 515.440.1681

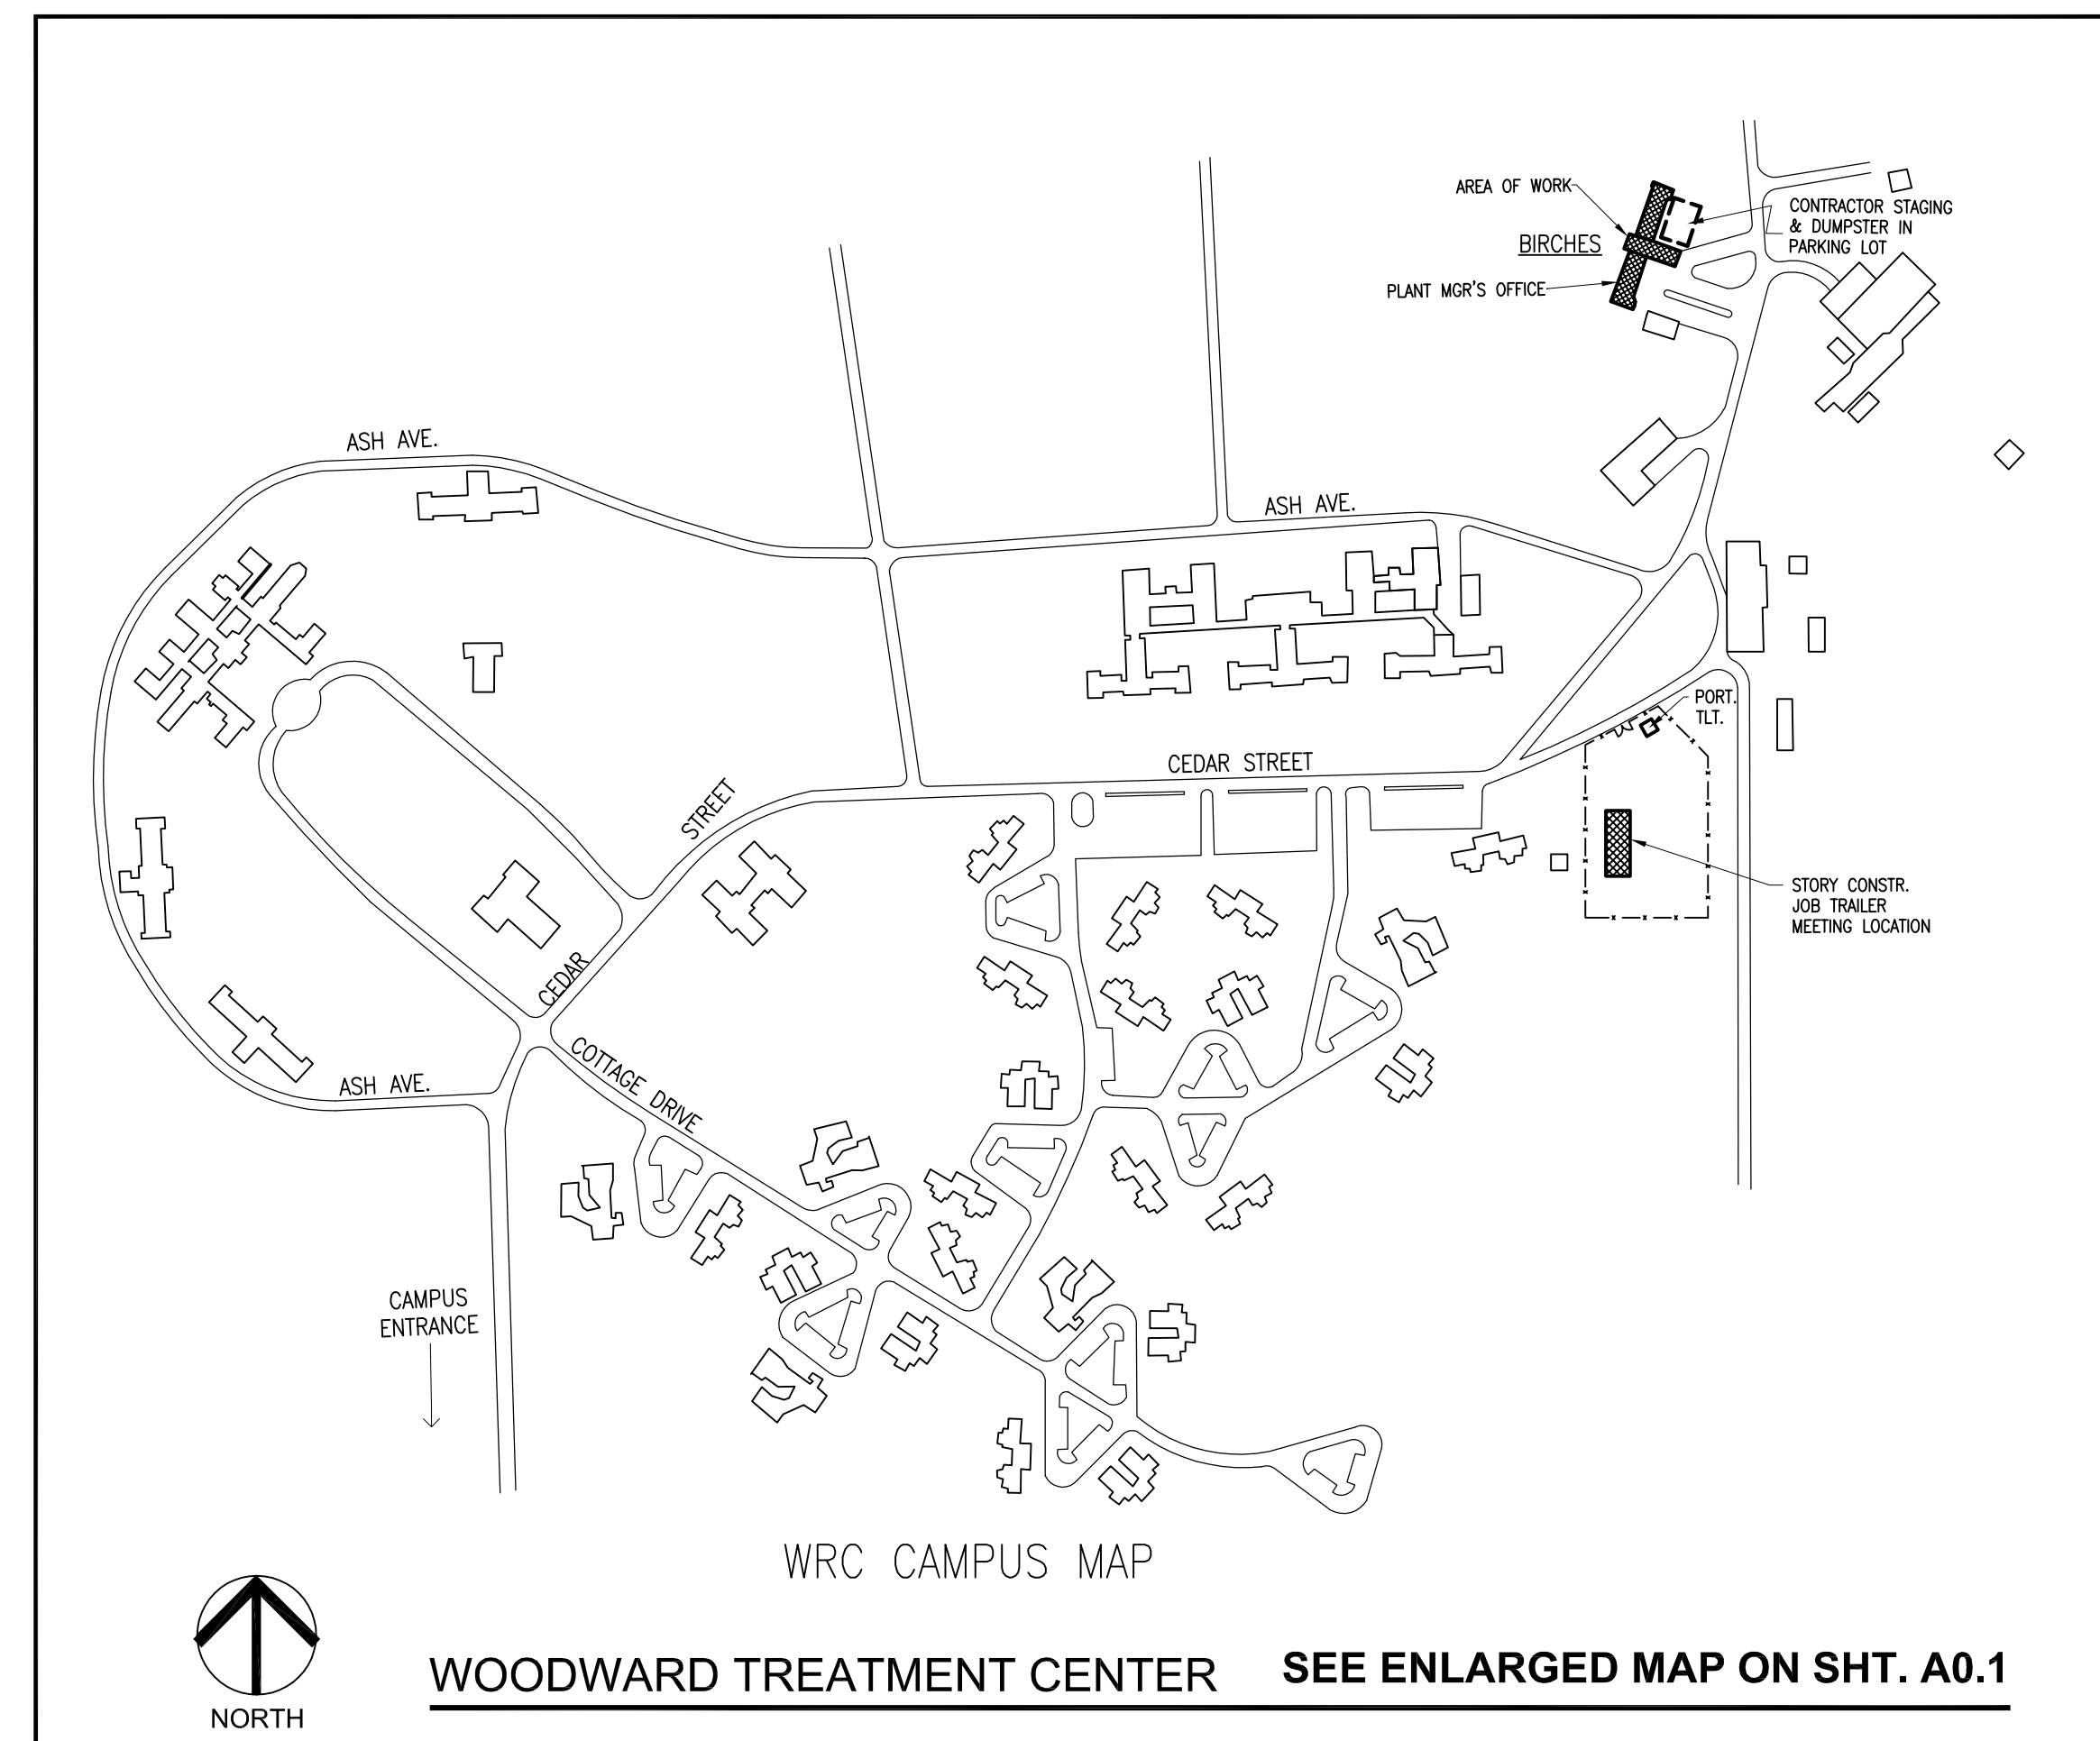

# SHEET INDEX


ARCHITECTURAL DRAWINGS	
A0.0	SHEET INDEX / SYMBOLS & ABBREVIATIONS
A0.1	SITE MAP
A1.0	BASEMENT & 1ST FLOOR PLANS
A1.1	2ND & 3RD FLOOR PLANS
A2.0	BUILDING ELEVATIONS
A3.0	WINDOW ELEVATION & SCHEDULE
A3.1	WINDOW DETAILS

I hereby certify that the portion of this technical submission described below was prepared by me or under my supervisor and responsible charge. I am a duly registered Architect under the laws of the State of Iowa.

Signature \_\_\_\_\_ 05761  
Edward L. Matt Reg. No.

Pages or Sheets covered in part or whole by this seal:  
A0.0, A0.1, A1.0, A1.1, A2.0, A3.0 & A3.1  
Date Issued: \_\_\_\_\_

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ENGINEER

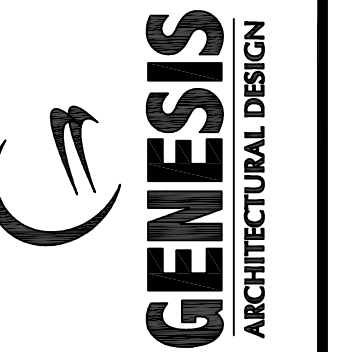FINAL ISSUED  
DRAWINGS

PROJECT TITLE

WRC BIRCHES  
WINDOW REPLACEMENT  
WOODWARD, IA 50276

SHEET CONTENTS

COVER: CONTACTS,  
LEGENDS, MAP AND  
ABBREVIATIONS

REVISIONS

NOTE	DATE

DAS PROJECT NO.  
9463.00

GENESIS PROJECT NO.  
2501

ISSUE DATE  
06-19-2025

SHEET NUMBER

A0.0

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ENGINEER

FINAL ISSUED DRAWINGS

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**WRC BIRCHES WINDOW REPLACEMENT**  
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SHEET CONTENTS  
 SITE MAP

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NOTE	DATE

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**06-19-2025**

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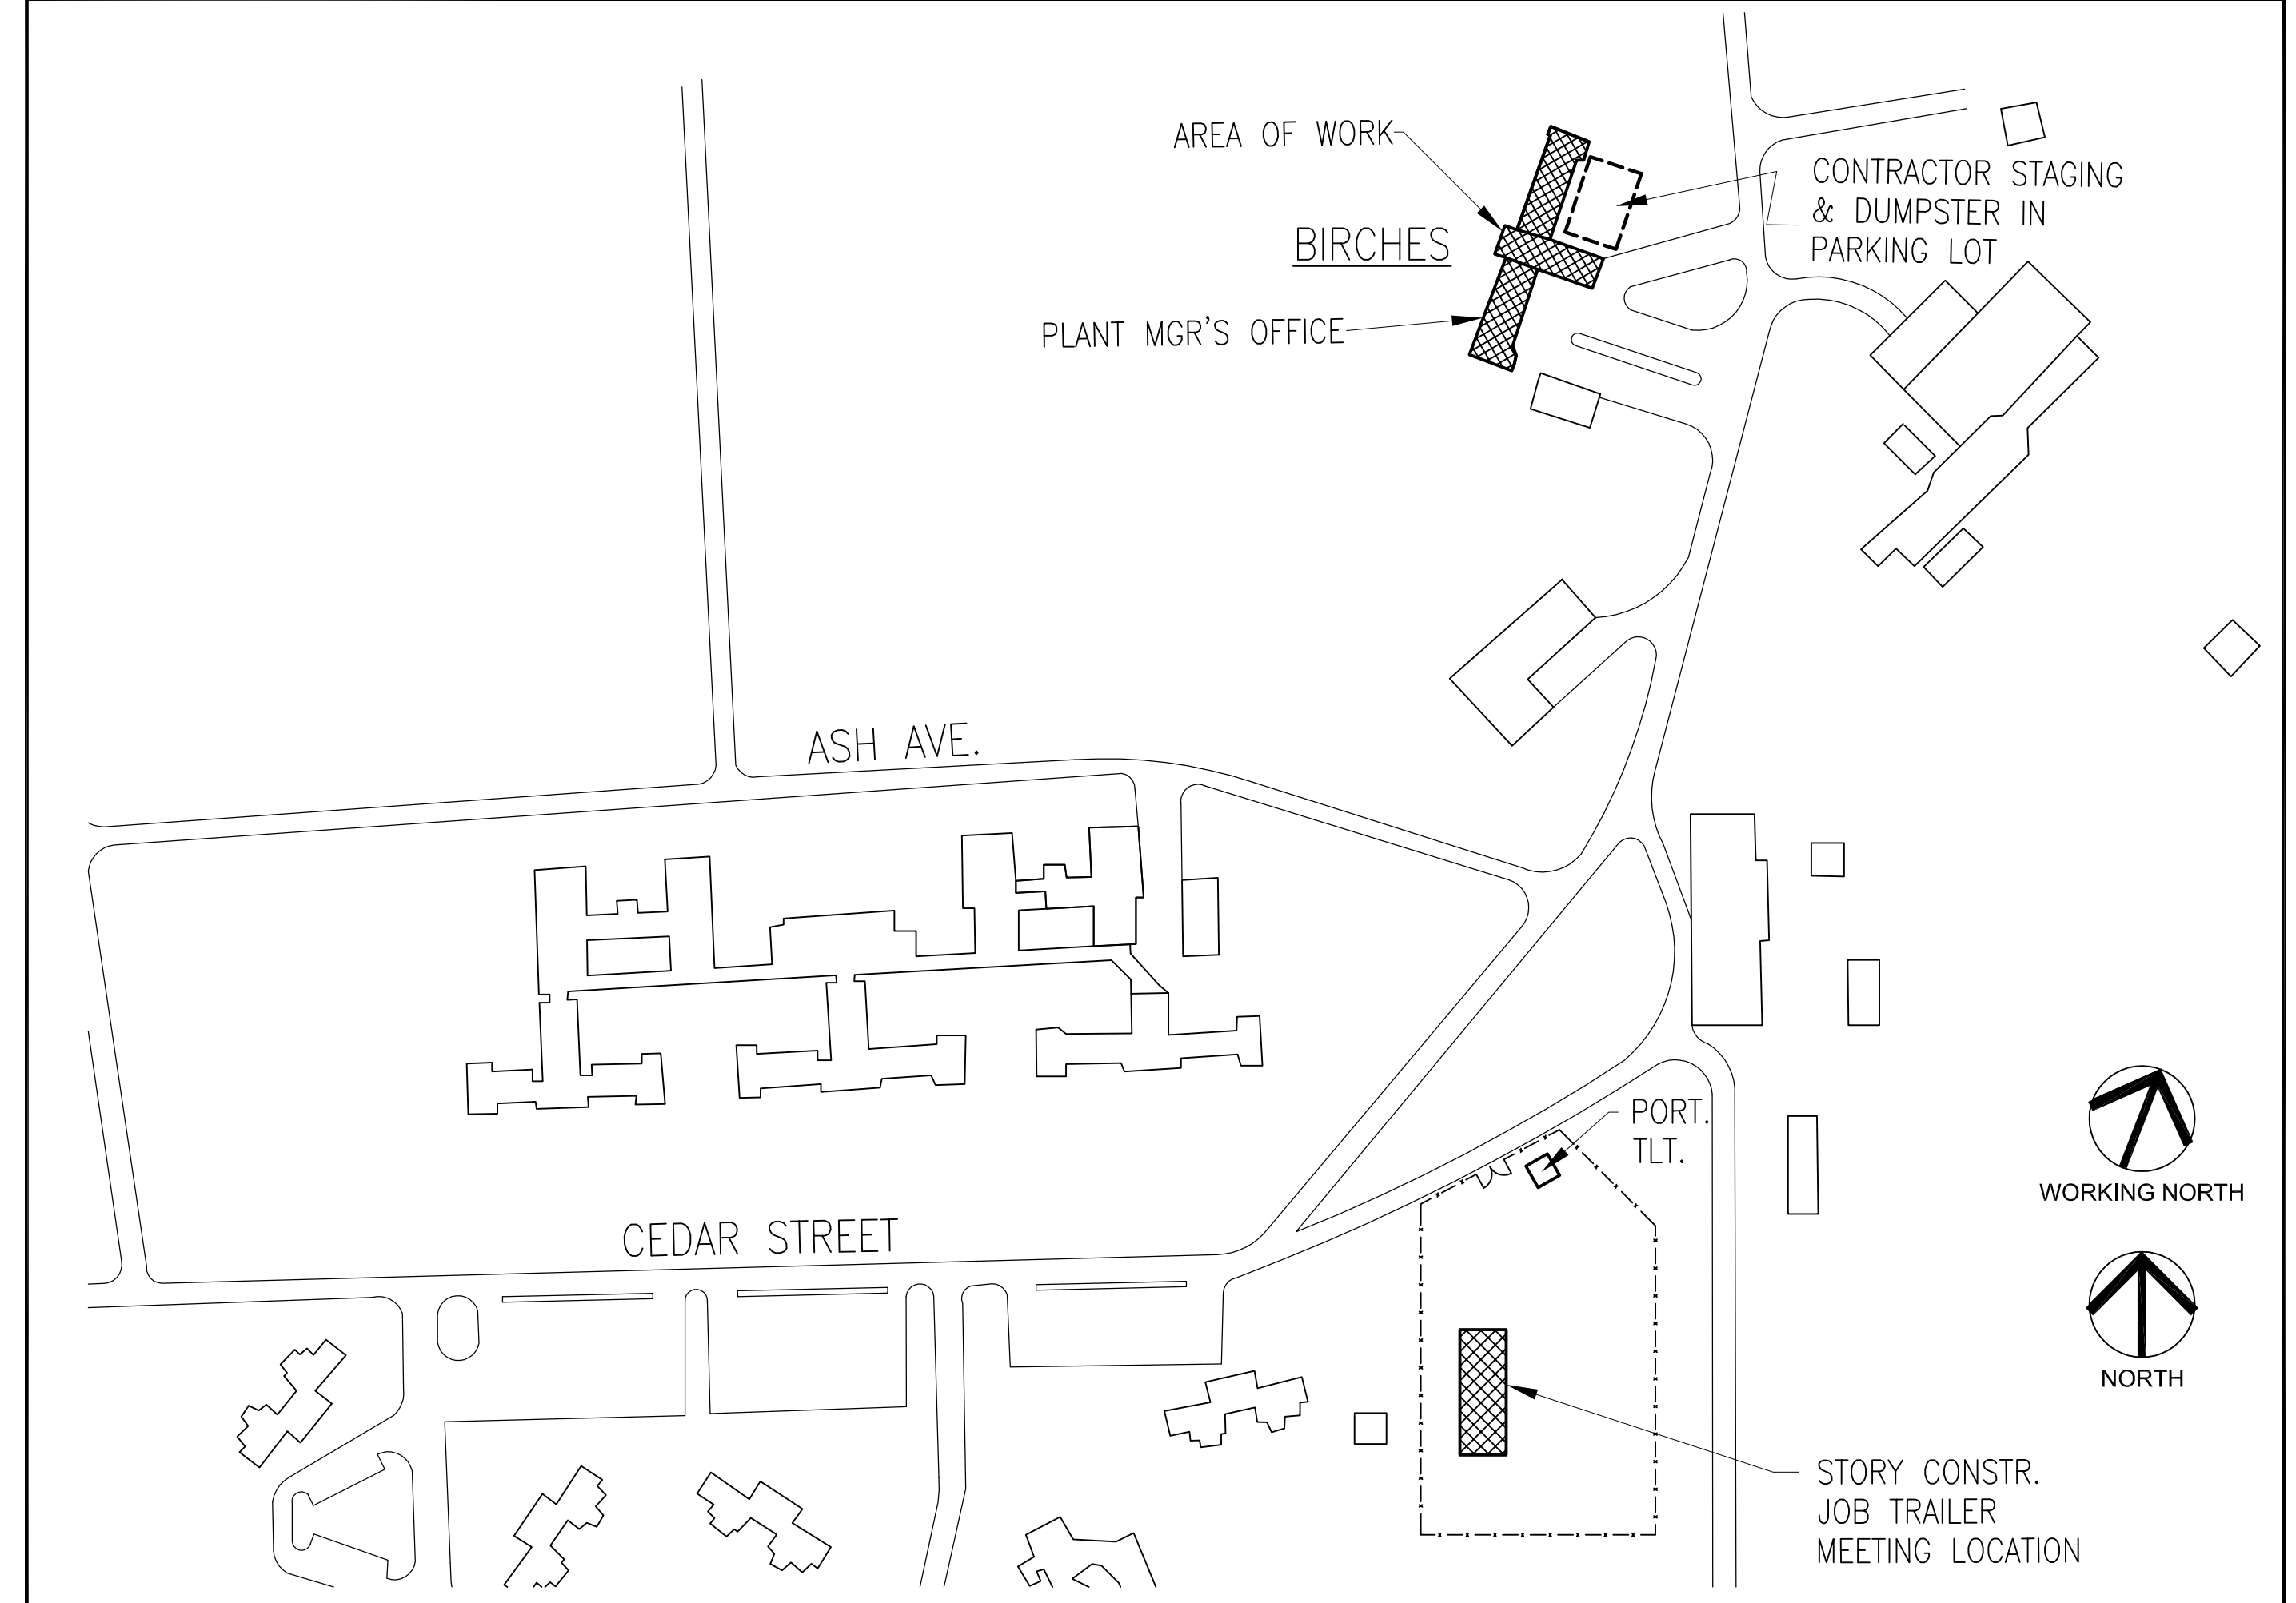
**SITE NOTES:**

1. CONTRACTOR'S PERSONNEL TO FOLLOW ALL RULES FOR CONSTRUCTION WORKERS & ATTEND CONTRACTOR'S ORIENTATION. SEE SPECIFICATION FOR REQUIREMENTS.
2. CONTRACTOR TO COORDINATE PROPOSED DAILY WORK SCHEDULE WITH WRC STAFF AND CONSTRUCTION MANAGER. IDENTIFY THE AREA OF WORK FOR EACH DAY AND PLANNED SEQUENCE FOR ALL SECTIONS.
3. ALL WORK AREAS ARE TO BE CLEANED UP AT THE END OF EACH DAY.
4. SEE SPECIFICATION FOR WORK HOURS. COORDINATE ANY PROPOSED EXTENDED WORK HOURS INCLUDING WEEKENDS.
5. PROTECT SIDEWALKS AND LAWN FROM EQUIPMENT AND LIFT DAMAGE. OWNER WILL REPAIR LAWN UNTIL RE-ESTABLISHED. CONTRACTOR IS RESPONSIBLE FOR ANY OTHER ADJACENT DAMAGED AREAS.
6. RESTROOMS ARE AVAILABLE IN BIRCHES BLDG & AT CONSTRUCTION MANAGER'S SITE.
7. ABATEMENT CONTRACTOR IS TO PROVIDE A SECURE HAZMAT DUMPSTER. NON-HAZARDOUS WASTE FROM WINDOW CONTRACTOR CAN BE PLACED IN A DUMPSTER THAT WILL BE PROVIDED BY THE OWNER AND SHARED WITH A SEPARATE ONGOING PROJECT.




AERIAL MAP



ENLARGED WRC MAP SHOWING SCOPE OF WORK





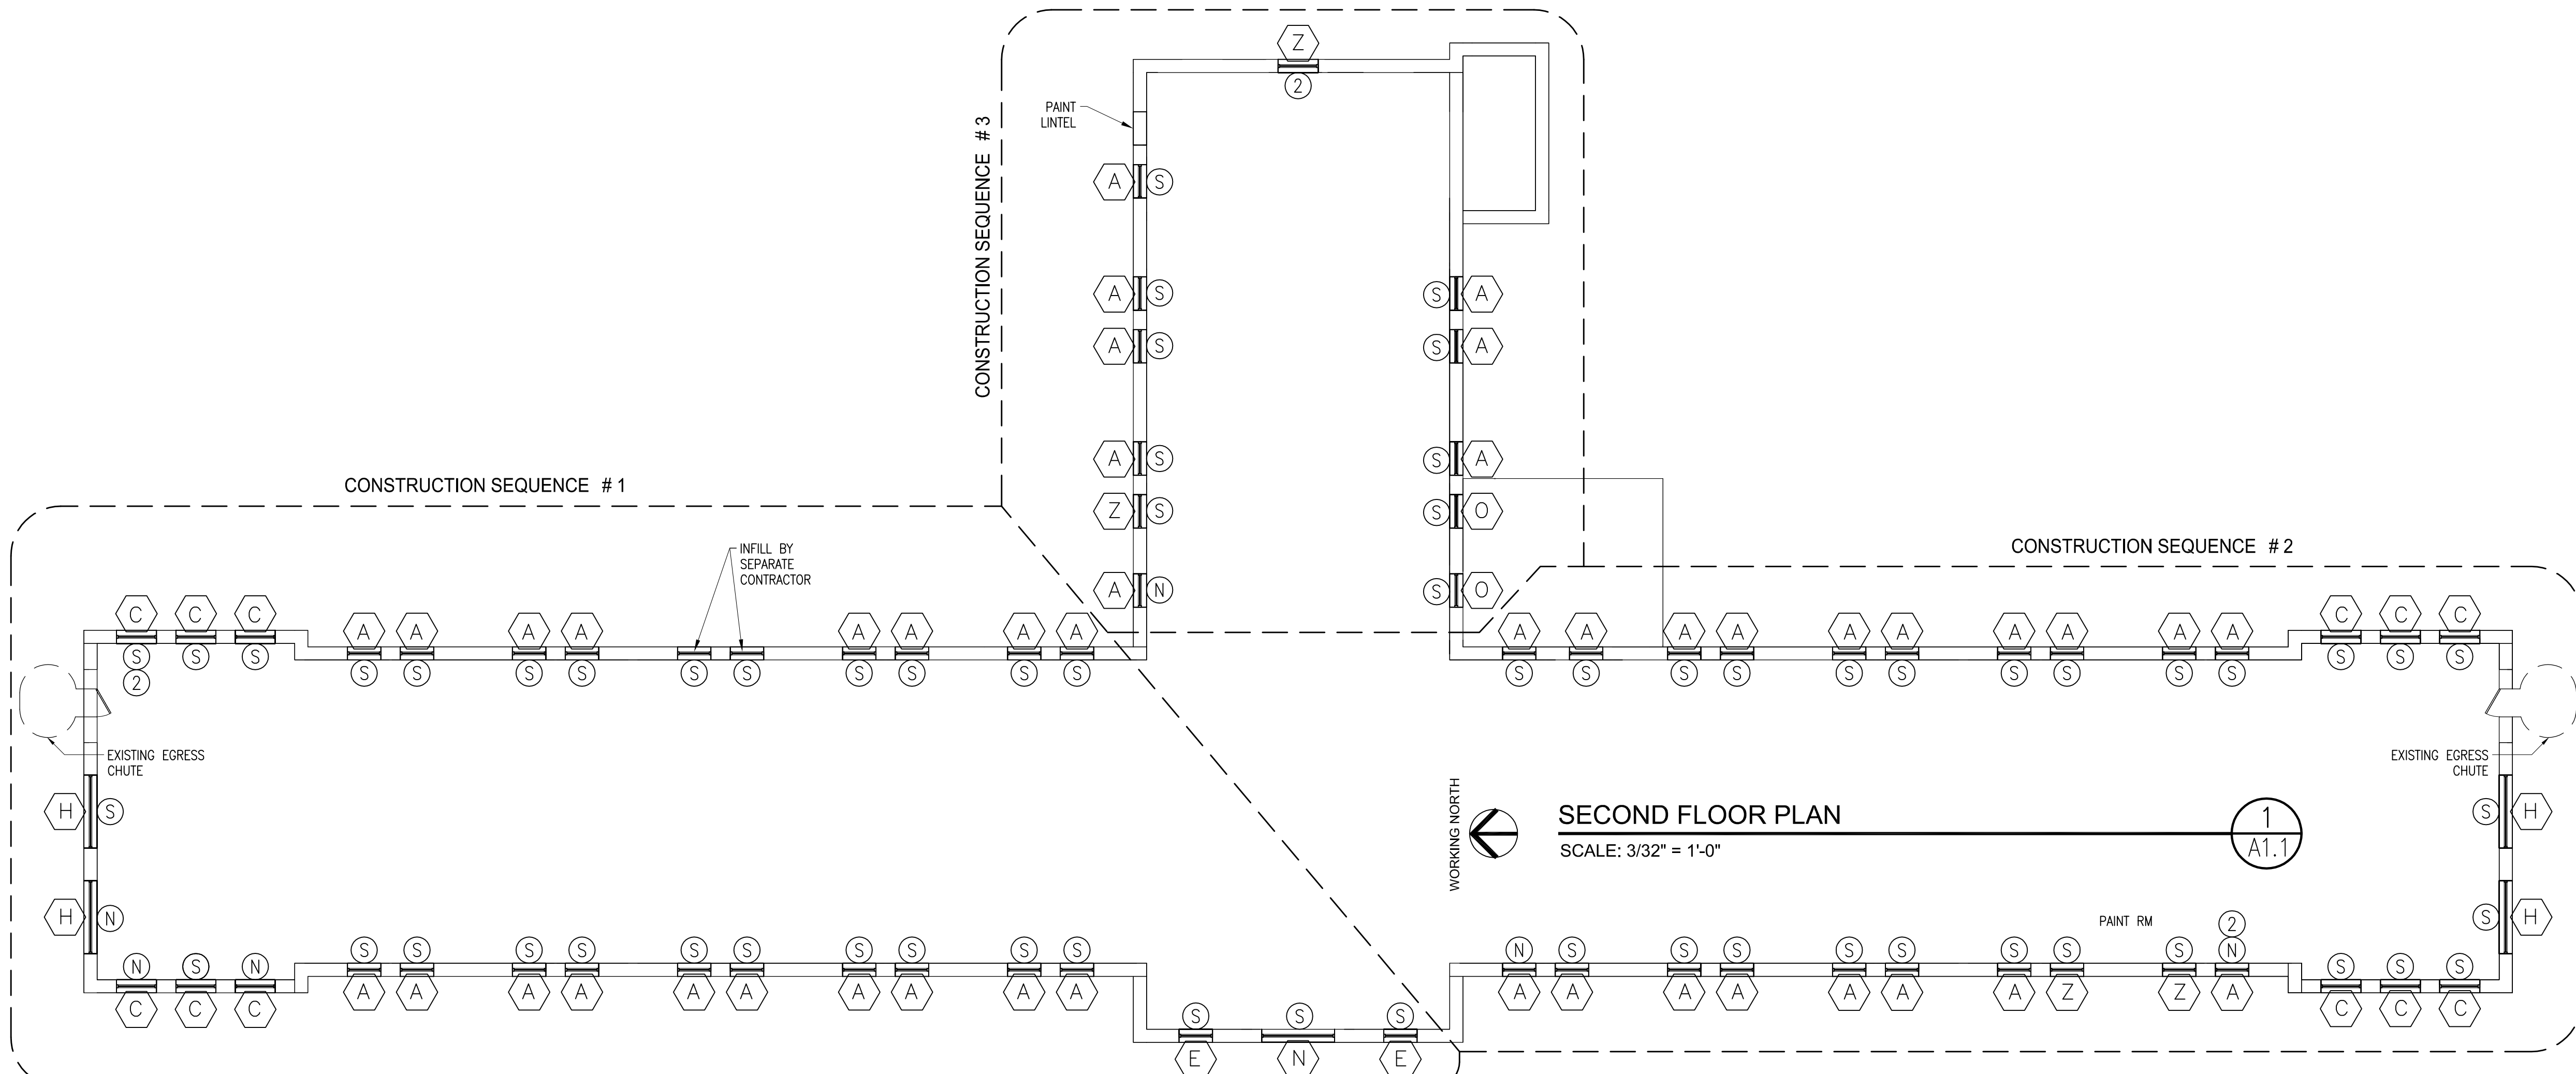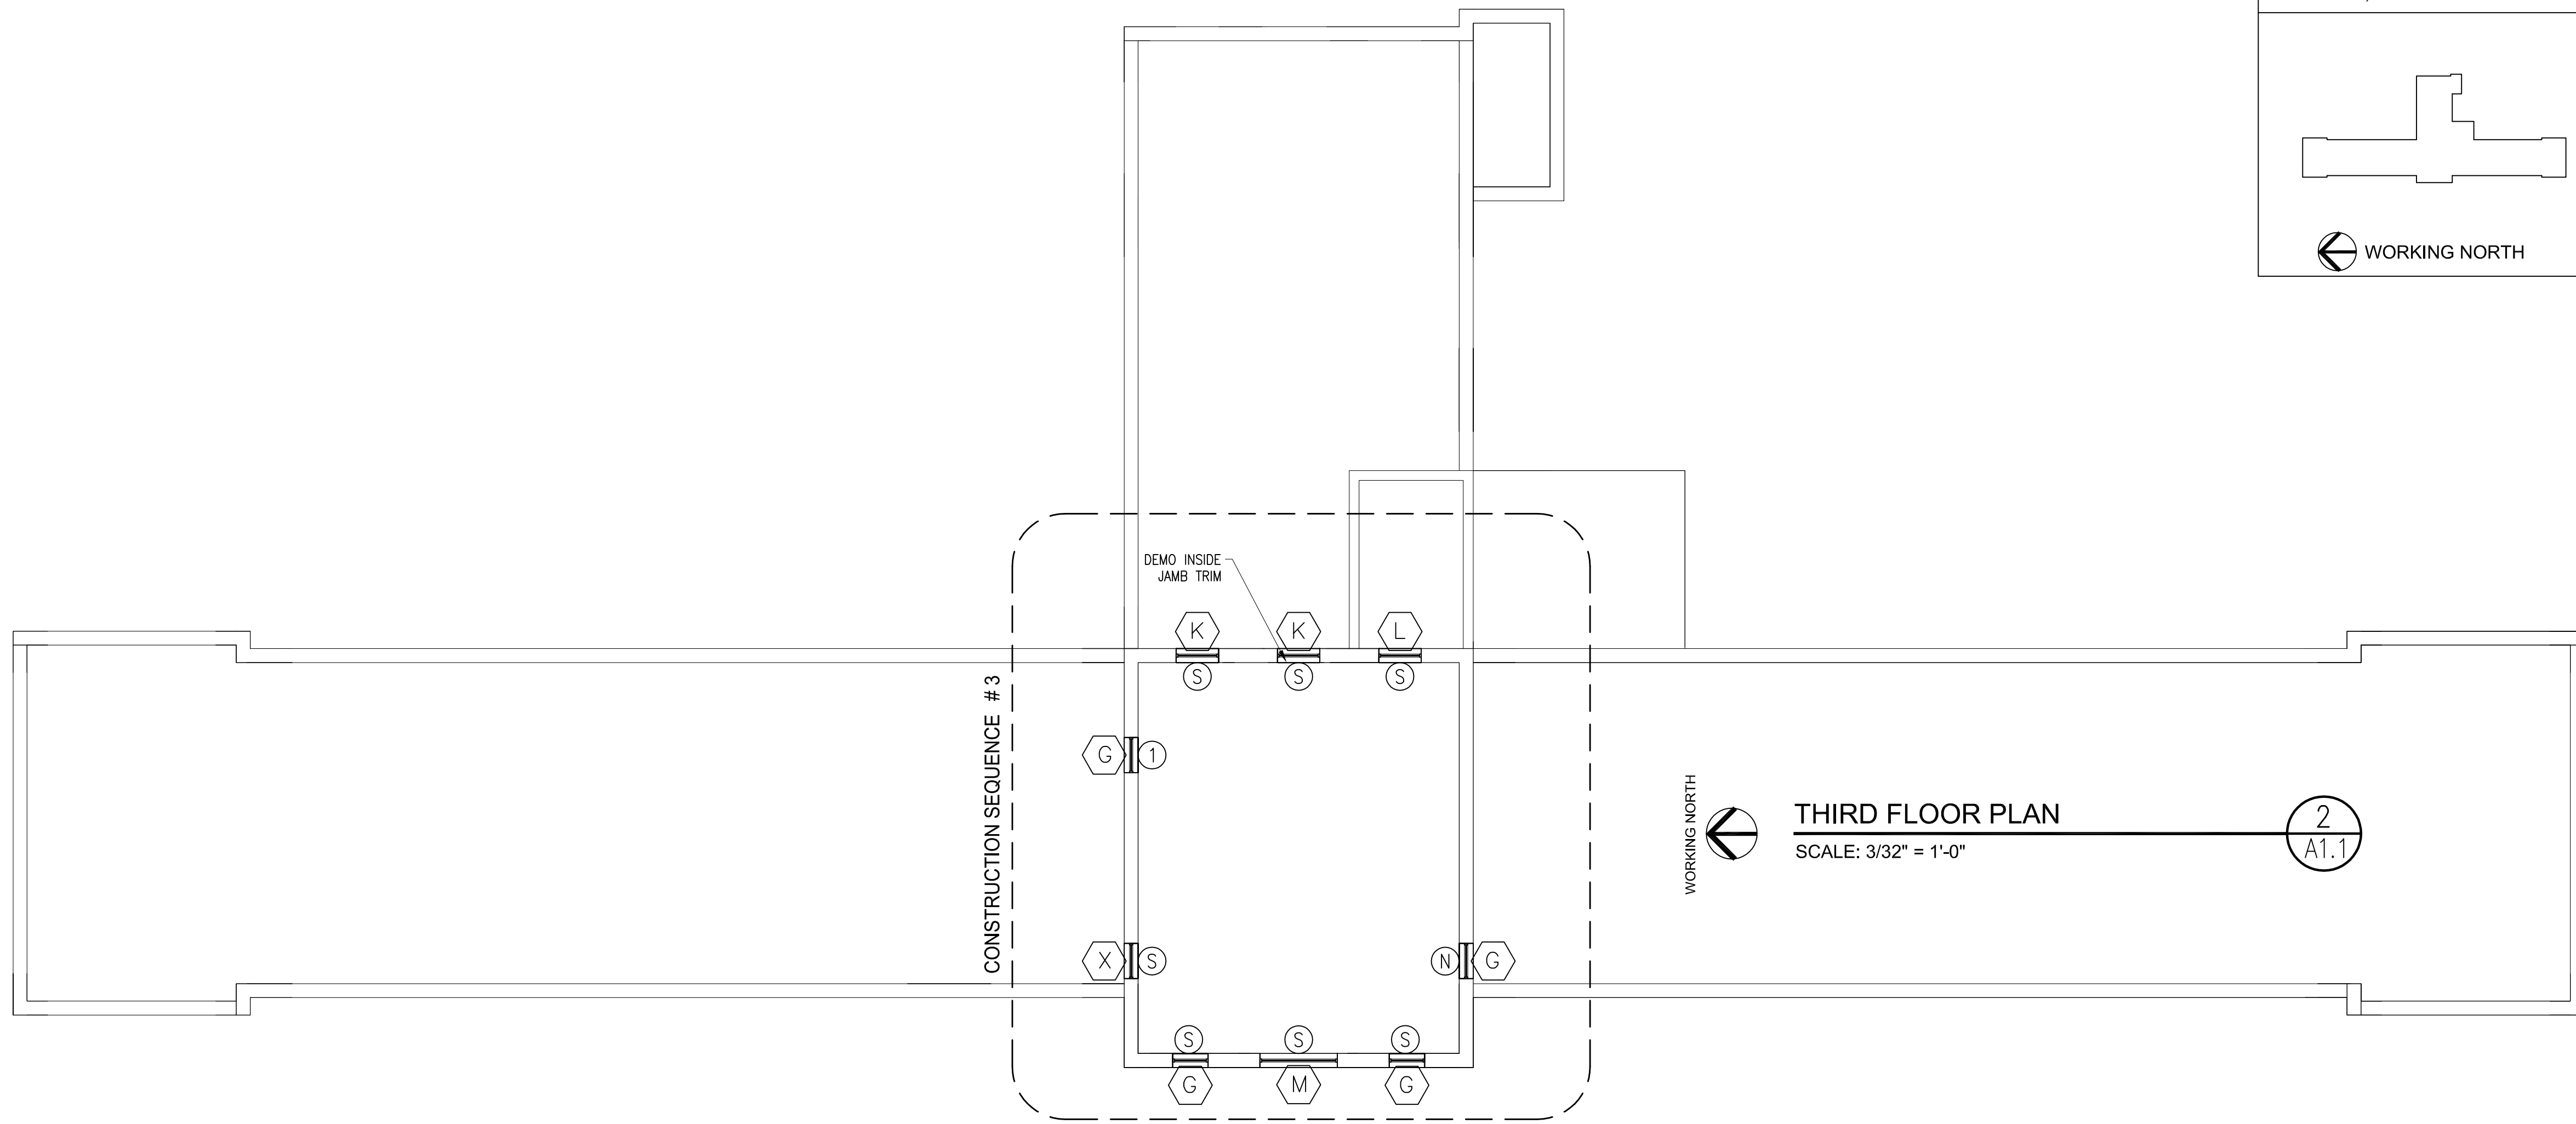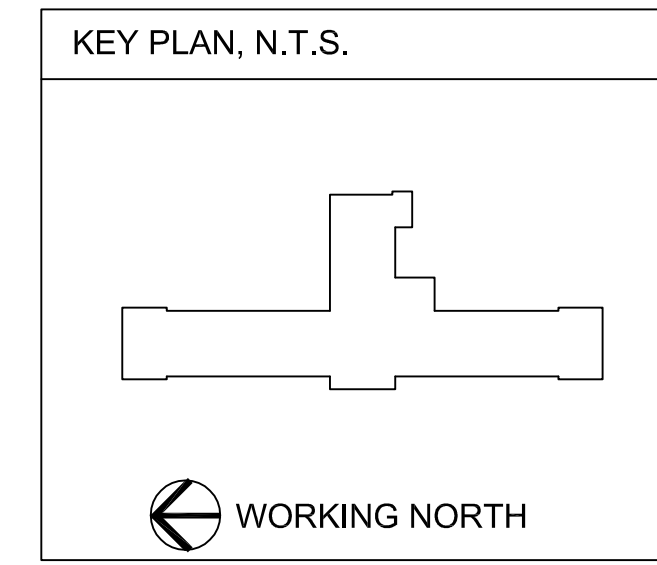

- GENERAL NOTES:**
- ALL WORK IS TO CONSTRUCTED IN COMPLIANCE WITH STATE BUILDING CODES. ALL CONSTRUCTION SHALL BE IN ACCORDANCE WITH INDUSTRY STANDARD PRACTICES.
  - ALL PERMITS AND FEES REQUIRED TO COMPLETE THE WORK SHALL BE INCLUDED IN THE CONTRACTOR'S BID.
  - CONTRACTOR IS RESPONSIBLE TO FIELD VERIFY ALL DIMENSIONS, MEASUREMENTS, QUANTITIES AND SITE CONDITIONS. REPORT ANY DISCREPANCIES TO ARCHITECT PRIOR TO PROCEEDING WITH WORK.
  - WORK AREAS ARE TO BE CLEANED UP AT THE END OF EACH DAY. JOB SITE SHALL BE KEPT CLEAN AT ALL TIMES.
  - PROTECT ADJACENT BUILDING ELEMENTS FROM DAMAGE DURING WORK. REPAIR ANY DAMAGE TO ADJACENT AREAS.
  - ALL CONSTRUCTION DEBRIS AND WASTE SHALL BE DISPOSED OF OFFSITE IN FULL COMPLIANCE WITH CURRENT ENVIRONMENTAL REGULATIONS.
  - SEE CONSTRUCTION NOTES FOR EXISTING WINDOW DEMOLITION AND TEMPORARY INFILLS.
  - SEE CONSTRUCTION KEYNOTES FOR SPECIFIC CONSTRUCTION.

- COLORS AND FINISHES:**
- EXTERIOR ALUMINUM WINDOW CLADDING FINISH: WHITE ANODIZED
  - INTERIOR & WOOD WINDOW & TRIM FINISH: PAINTED WHITE
  - EXTERIOR BRICK LINTELS: PAINTED WHITE
  - EXTERIOR SEALANT: WHITE
  - INTERIOR SEALANT: WHITE
  - INTERIOR HOLES IN CLAY TILE OR CMU: PATCH W/ STANDARD GRAY MORTAR

- CONSTRUCTION NOTES:**
- ALL STEEL WINDOWS HAVE ASBESTOS CONTAINING GLAZING AROUND EACH LITE. THE STEEL WINDOWS & PERIMETER SEALANT WILL BE REMOVED PRIOR TO CONSTRUCTION UNDER BID PACKAGE BP 01 FOR ABATEMENT.
  - ALL WOOD WINDOWS HAVE LEAD CONTAINING PAINT AND ASBESTOS CONTAINING SEALANT AROUND THE PERIMETER OF THE WINDOWS. THE WOOD WINDOWS AND PERIMETER SEALANT WILL BE REMOVED PRIOR TO CONSTRUCTION UNDER BID PACKAGE BP 01 FOR ABATEMENT.
  - THE ABATEMENT CONTRACTOR WILL BE RESPONSIBLE TO REMOVE ALL EXISTING WINDOWS & INTERIOR STORM WINDOWS & FRAMES & PROVIDE TEMPORARY PLYWOOD INFILLS AT ALL DEMOLISHED WINDOW LOCATIONS UNTIL NEW WINDOW UNITS ARE INSTALLED. PROVIDE 2X4 PERIMETER FRAMING AND 1/2" THICK EXTERIOR PLYWOOD FOR INFILLS. SET THE OUTSIDE FACE OF THE PLYWOOD 4" BACK FROM THE FACE OF THE BRICK. THE WINDOW CONTRACTOR WILL REMOVE THE PLYWOOD AND FRAMING AS PART OF THEIR CONTRACT PRIOR TO INSTALLING THE NEW WINDOWS. SALVAGE ALL INFILL MATERIALS FOR REUSE.
  - SEQUENCING WILL BE DONE BY EACH WING, I.E. NORTH, SOUTH, AND EAST WINGS FULL HEIGHT. PLYWOOD INFILL MATERIALS ARE TO BE SALVAGED AND REUSED ON EACH CONSECUTIVE WING.
  - ALL NEW WINDOWS WILL BE ALUMINUM CLAD WOOD FIXED UNITS WITH MULLIONS. SEE SPECIFICATION REQUIREMENTS IN SECTION 08 5200.
  - EXISTING INTERIOR PLASTER & PAINT FINISHES HAVE LEAD CONTAINING PAINTS. WINDOW CONTRACTOR & PAINTER ARE TO BE LEAD PAINT CERTIFIED TO REPAIR DISTURBED INTERIOR FINISHES. SEE SPECIFICATION FOR ABATEMENT OF LEAD PAINT IN WORK AREA.
  - PAINT INTERIOR OF NEW WINDOWS 2 COATS OF PAINT IF NOT FURNISHED PRE-PAINTED.
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  - INSULATE ALL SHIM SPACE CAVITIES AT PERIMETER OF WINDOWS WITH SPRAY FOAM INSULATION.
  - PROVIDE CONT. SEALANT BETWEEN WINDOWS AND JAMB EXTENSION TRIM, AND ALSO BETWEEN EXTERIOR TRIM AND EXISTING BLOCK/TILE JAMBS.
  - ABATEMENT CONTRACTOR TO ABATE LEAD PAINT. WINDOW CONTRACTOR TO PREP, PRIME AND PAINT ALL BRICK LINTELS.
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  - OWNER (FACILITY) WILL REMOVE ALL A.C. UNITS, LOUVERS, & MISC. MECH. & ELECTRICAL ITEMS PRIOR TO CONSTRUCTION. COORDINATE WITH FACILITY FOR SEQUENCING SCHEDULE.

- KEYNOTES**
- REMOVE EXTERIOR PLYWOOD.
  - REMOVE INTERIOR PLYWOOD.
  - INTERIOR STORM SCREEN TO BE REMOVED & DISPOSED.
  - NO INTERIOR STORM SCREEN.

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ENGINEER

FINAL ISSUED DRAWINGS

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SHEET CONTENTS  
 2ND & 3RD FLOOR PLANS

REVISIONS	
NOTE	DATE



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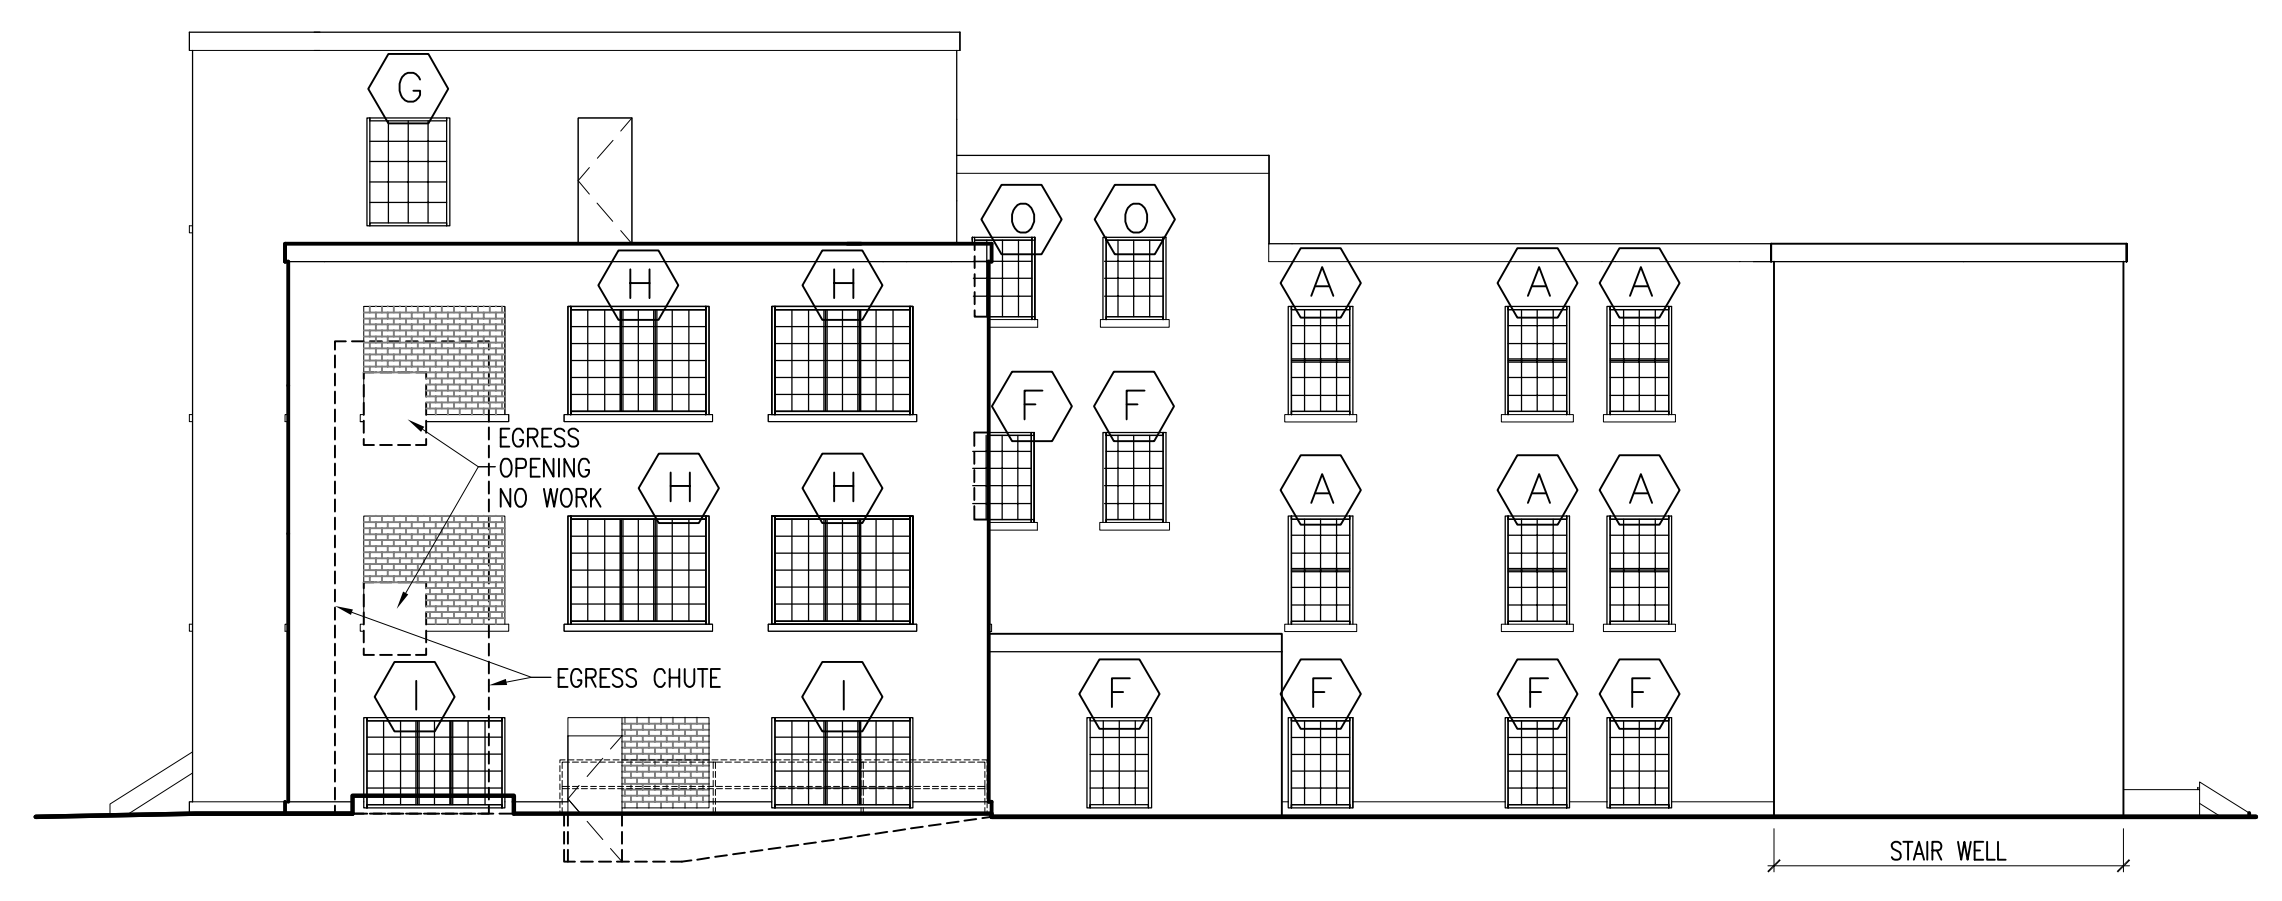
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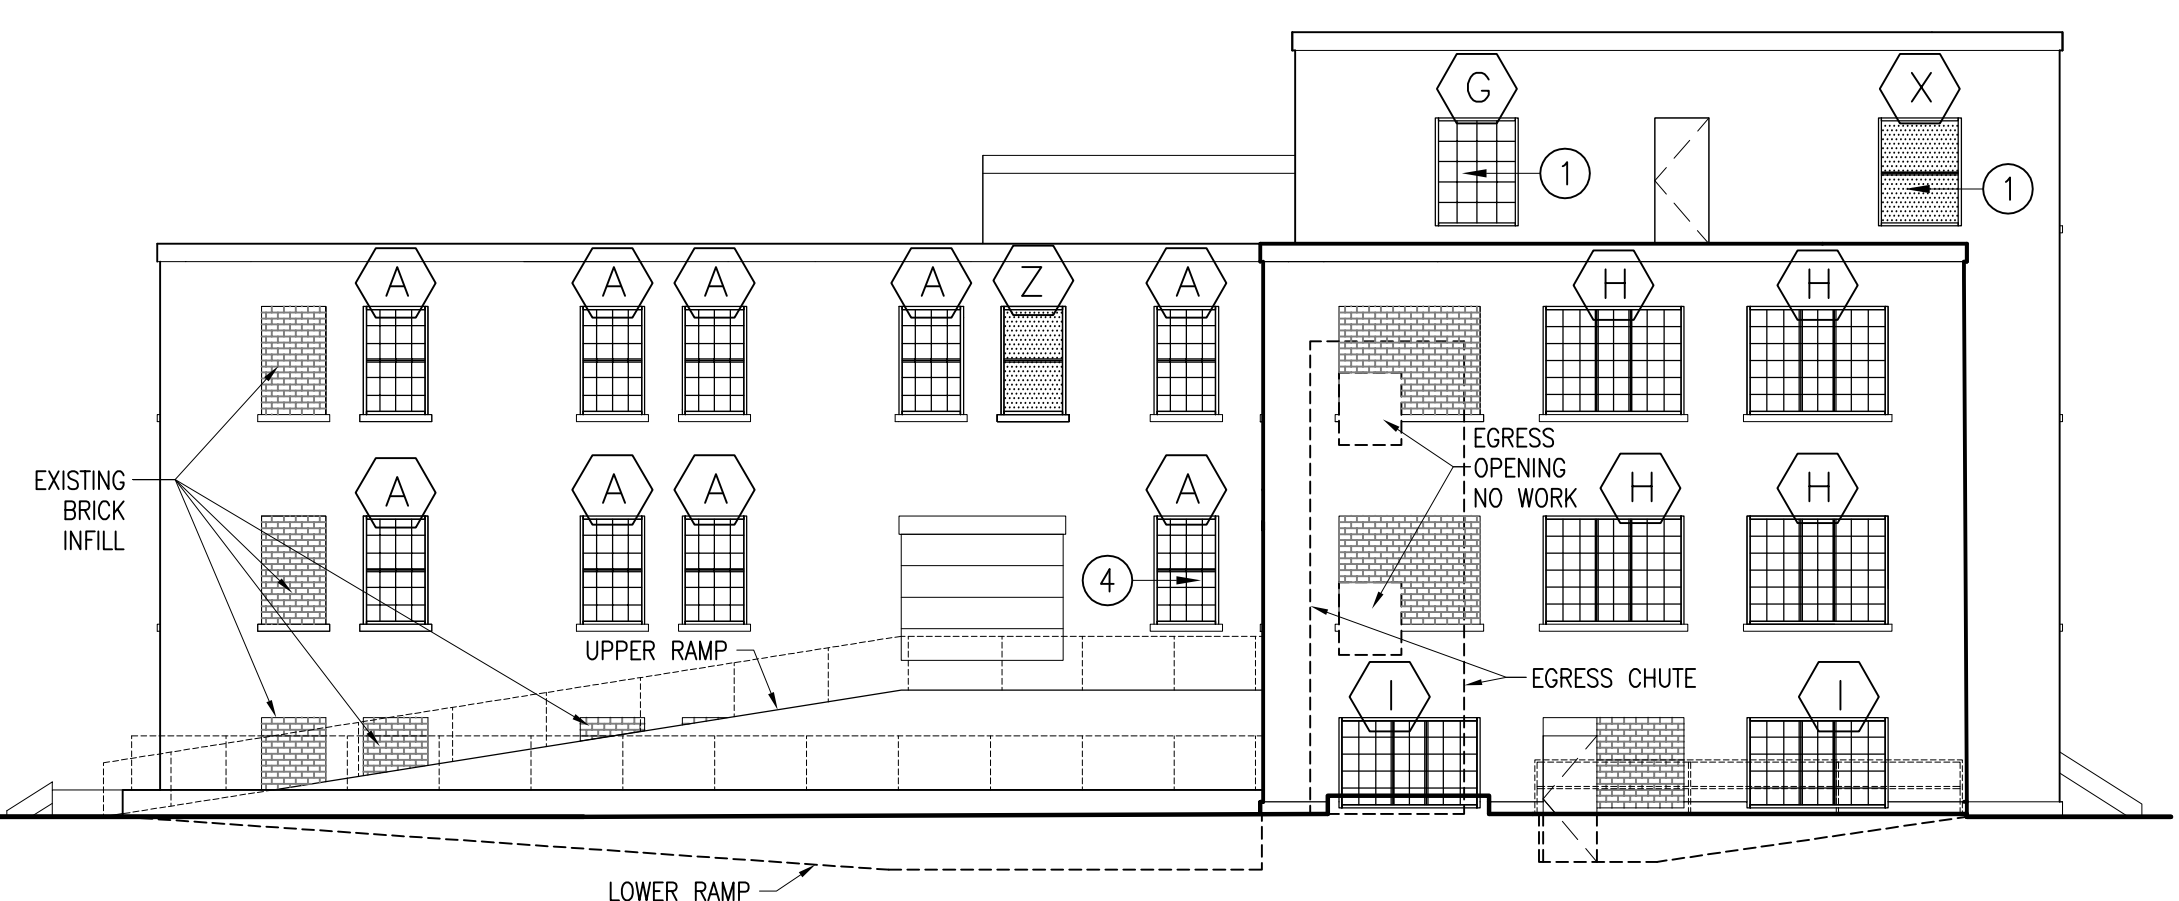
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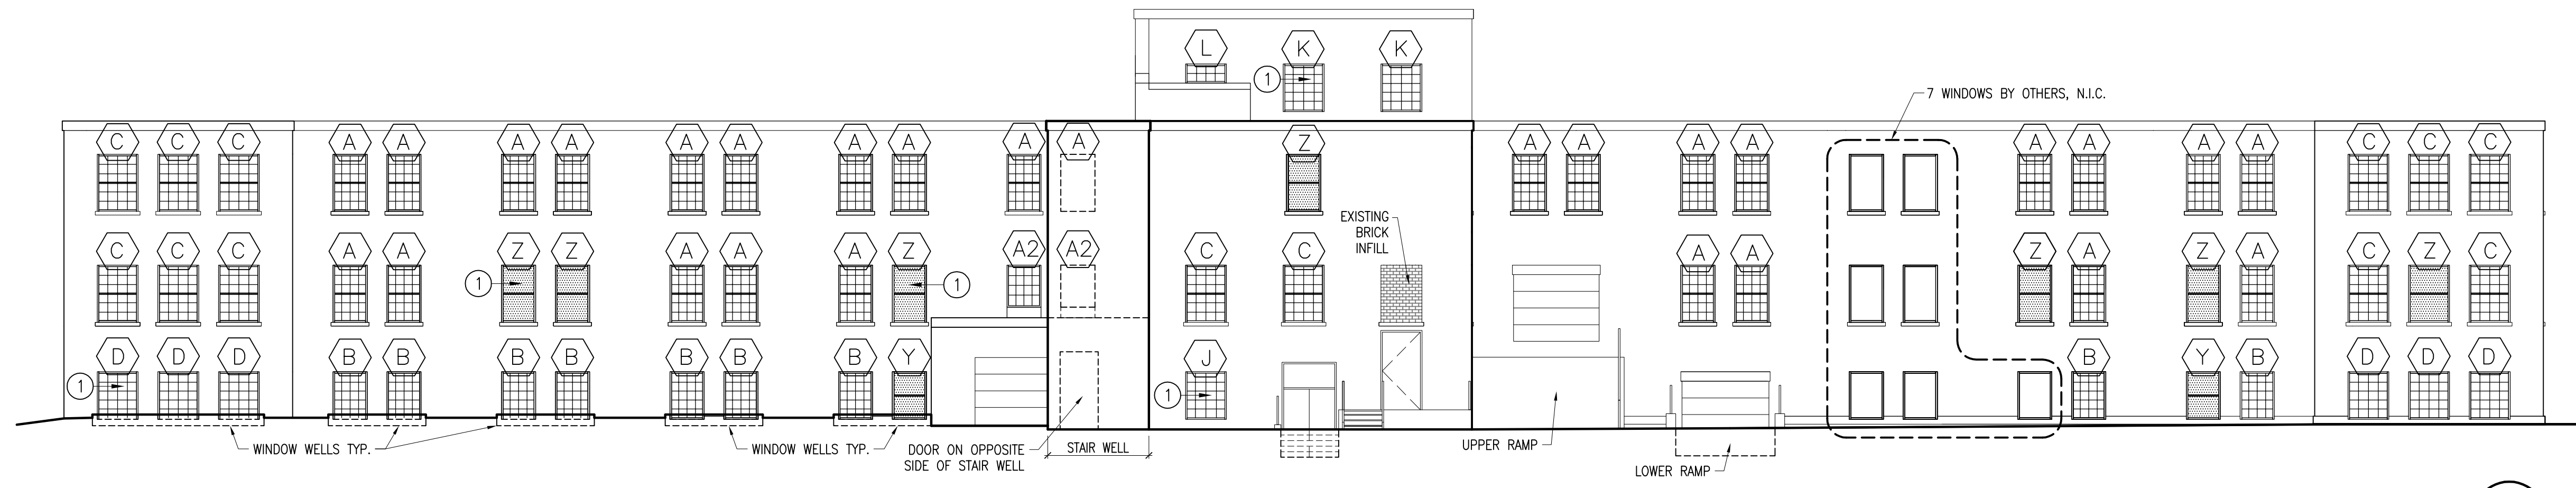
**PARTIAL EAST ELEVATION 5**  
 SCALE: 3/32" = 1'-0"  
 A2.0




**SOUTH ELEVATION 4**  
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 A2.0



**NORTH ELEVATION 3**  
 SCALE: 3/32" = 1'-0"  
 A2.0

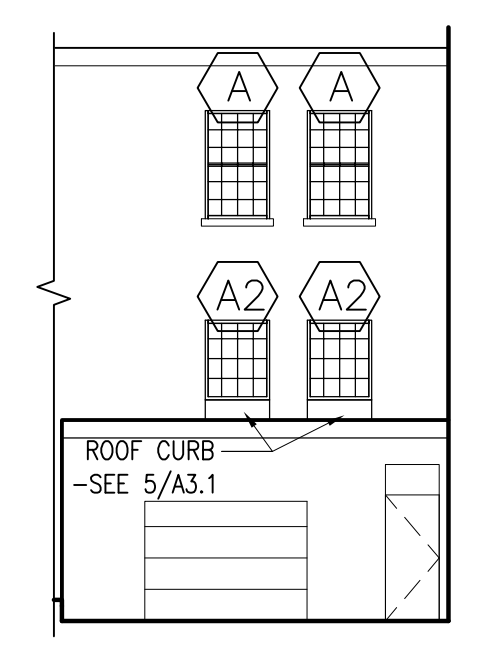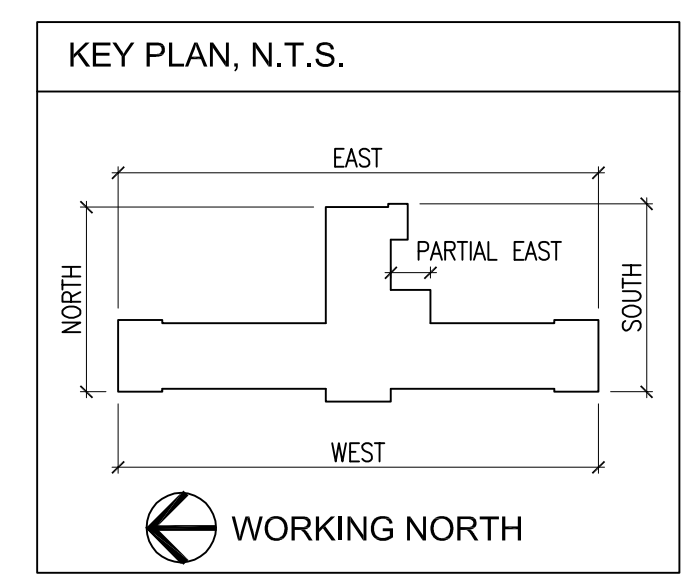

**EAST ELEVATION 2**  
 SCALE: 3/32" = 1'-0"  
 A2.0

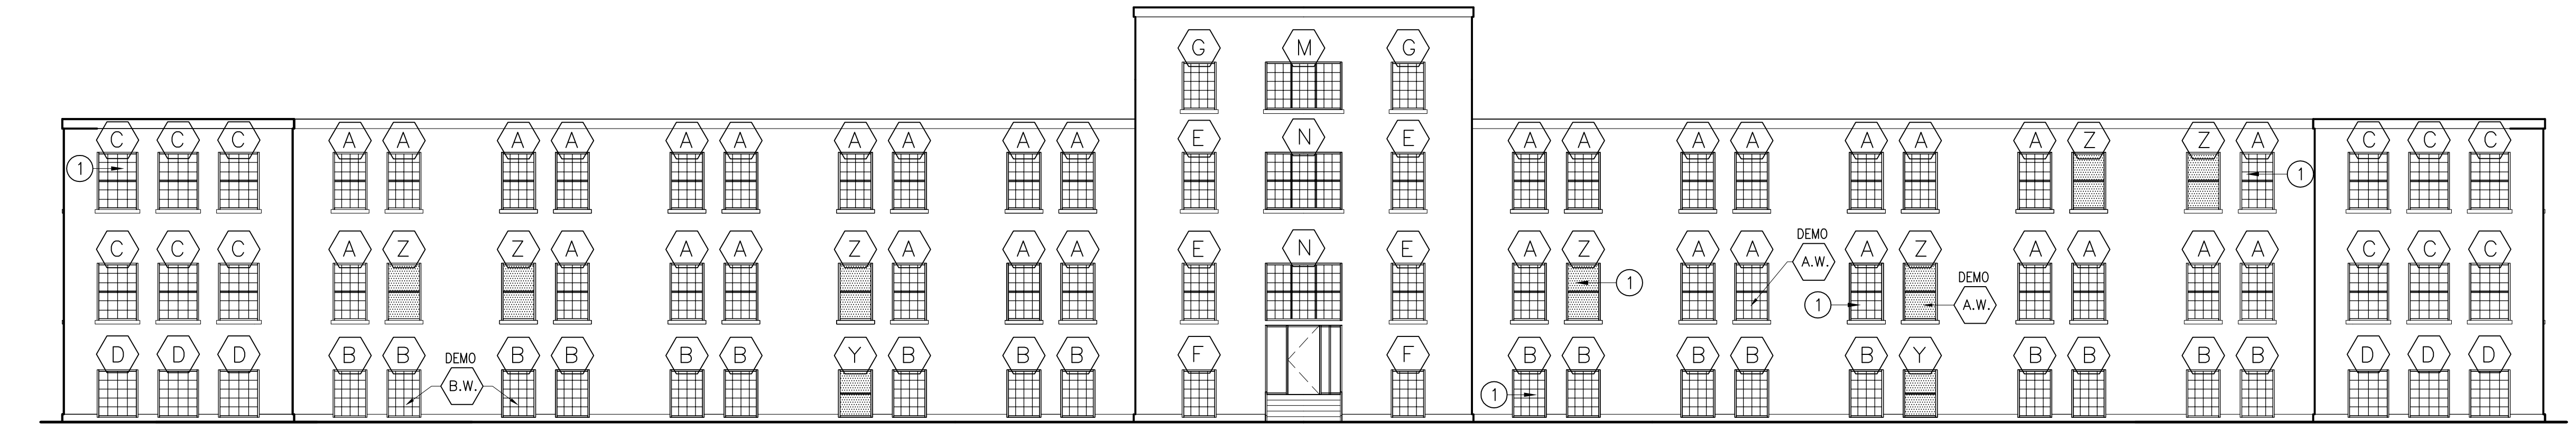

**WEST ELEVATION 1**  
 SCALE: 3/32" = 1'-0"  
 A2.0

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- B. ALL PERMITS AND FEES REQUIRED TO COMPLETE THE WORK SHALL BE INCLUDED IN THE CONTRACTOR'S BID.
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- D. WORK AREAS ARE TO BE CLEANED UP AT THE END OF EACH DAY. JOB SITE SHALL BE KEPT CLEAN AT ALL TIMES.
- E. PROTECT ADJACENT BUILDING ELEMENTS FROM DAMAGE DURING WORK. REPAIR ANY DAMAGE TO ADJACENT AREAS.
- F. ALL CONSTRUCTION DEBRIS AND WASTE SHALL BE DISPOSED OF OFFSITE IN FULL COMPLIANCE WITH CURRENT ENVIRONMENTAL REGULATIONS.
- G. SEE CONSTRUCTION NOTES FOR EXISTING WINDOW DEMOLITION AND TEMPORARY INFILLS.
- H. SEE CONSTRUCTION KEYNOTES FOR SPECIFIC CONSTRUCTION.

**COLORS AND FINISHES:**

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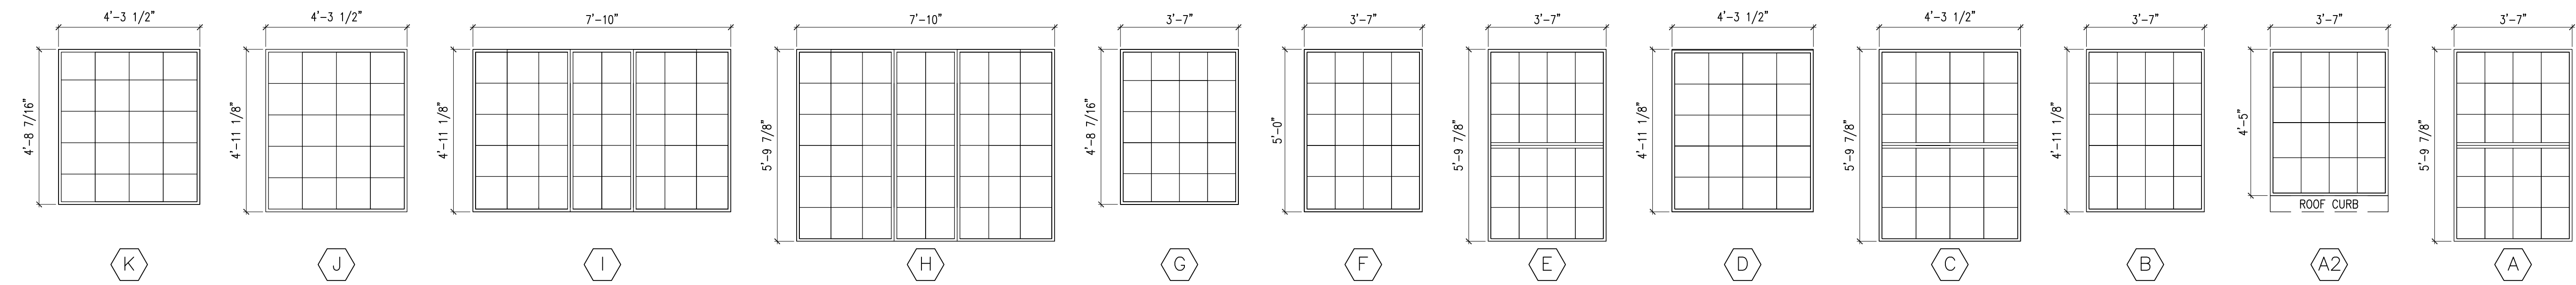
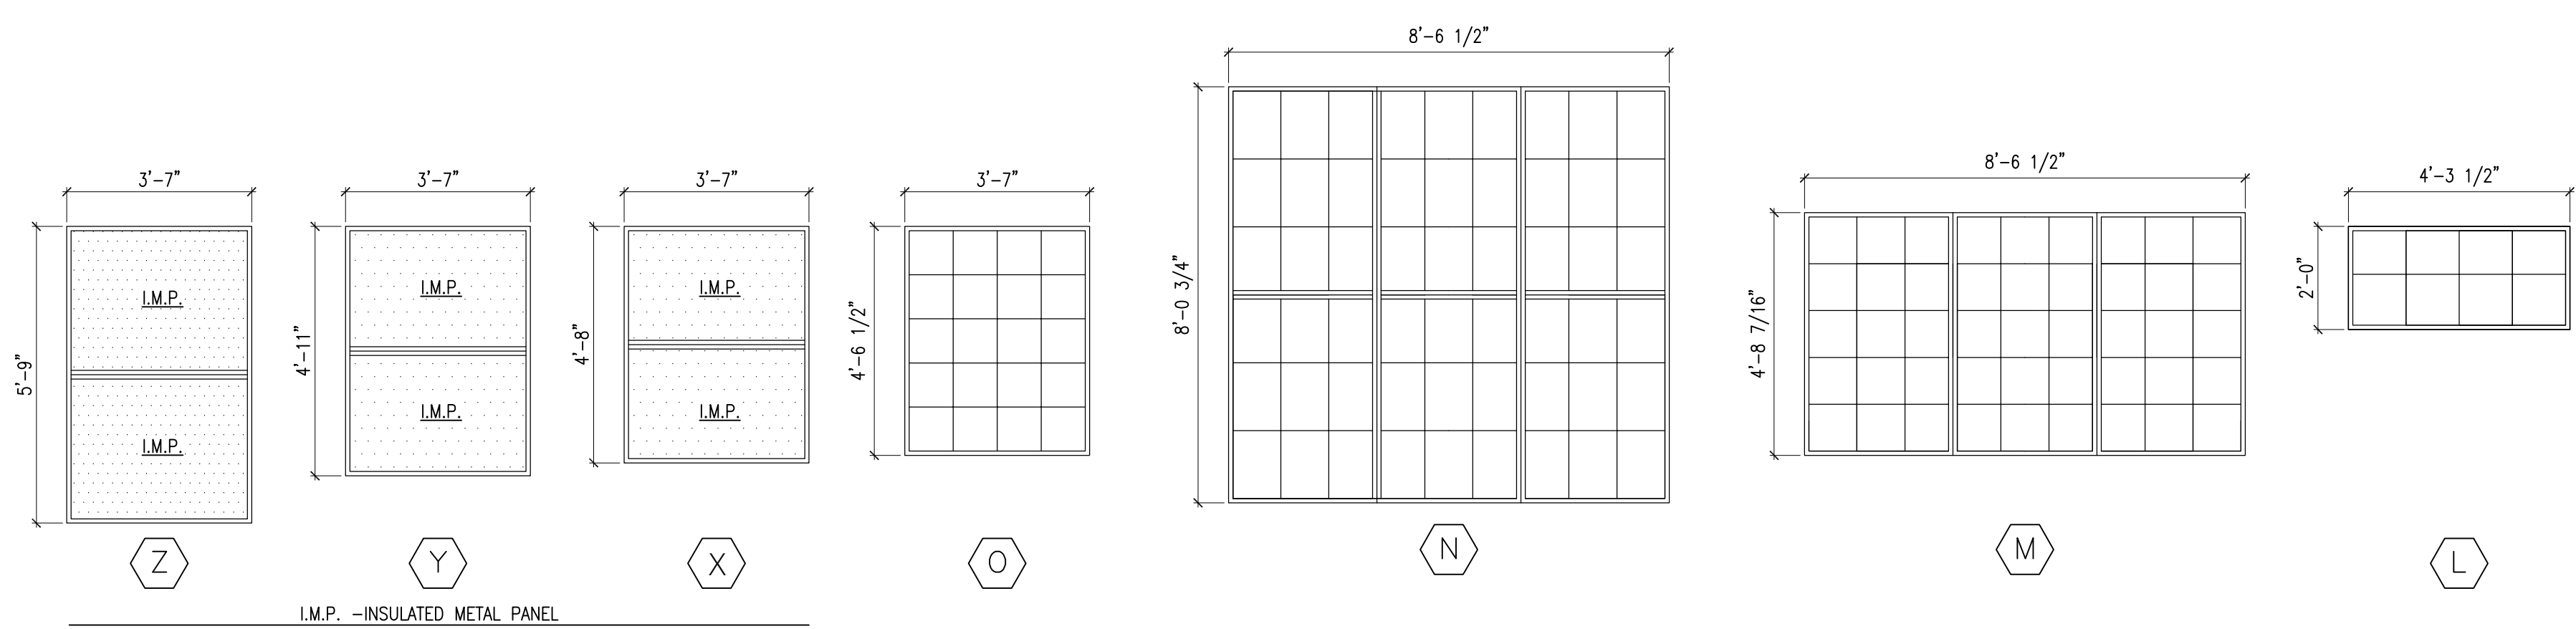
**CONSTRUCTION NOTES:**

1. ALL STEEL WINDOWS HAVE ASBESTOS CONTAINING GLAZING AROUND EACH LITE. THE STEEL WINDOWS & PERIMETER SEALANT WILL BE REMOVED PRIOR TO CONSTRUCTION UNDER BID PACKAGE BP 01 FOR ABATEMENT.
2. ALL WOOD WINDOWS HAVE LEAD CONTAINING PAINT AND ASBESTOS CONTAINING SEALANT AROUND THE PERIMETER OF THE WINDOWS. THE WOOD WINDOWS AND PERIMETER SEALANT WILL BE REMOVED PRIOR TO CONSTRUCTION UNDER BID PACKAGE BP 01 FOR ABATEMENT.
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4. SEQUENCING WILL BE DONE BY EACH WING, I.E. NORTH, SOUTH, AND EAST WINGS FULL HEIGHT. PLYWOOD INFILL MATERIALS ARE TO BE SALVAGED AND REUSED ON EACH CONSECUTIVE WING.
5. ALL NEW WINDOWS WILL BE ALUMINUM CLAD WOOD FIXED UNITS WITH MULLIONS. SEE SPECIFICATION REQUIREMENTS IN SECTION 08 5200.
6. EXISTING INTERIOR PLASTER & PAINT FINISHES HAVE LEAD CONTAINING PAINTS. WINDOW CONTRACTOR & PAINTER ARE TO BE LEAD PAINT CERTIFIED TO REPAIR DISTURBED INTERIOR FINISHES. SEE SPECIFICATION FOR ABATEMENT OF LEAD PAINT IN WORK AREA.
7. PAINT INTERIOR OF NEW WINDOWS 2 COATS OF PAINT IF NOT FURNISHED PRE-PAINTED.
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9. INSULATE ALL SHIM SPACE CAVITIES AT PERIMETER OF WINDOWS WITH SPRAY FOAM INSULATION.
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11. ABATEMENT CONTRACTOR TO ABATE LEAD PAINT. WINDOW CONTRACTOR TO PREP, PRIME AND PAINT ALL BRICK LINTELS.
12. ABATEMENT CONTRACTOR TO ABATE LEAD PAINT ON LINTELS. WINDOW CONTRACTOR TO PREP, PRIME & PAINT ALL PARTIALLY EXPOSED LINTELS AT ALL EXISTING BRICK INFILLS.
13. OWNER (FACILITY) WILL REMOVE ALL A.C. UNITS, LOUVERS, & MISC. MECH. & ELECTRICAL ITEMS PRIOR TO CONSTRUCTION. COORDINATE WITH FACILITY FOR SEQUENCING SCHEDULE.

**KEYNOTES**

- ① REMOVE EXTERIOR PLYWOOD.
- ② REMOVE INTERIOR PLYWOOD.
- ③ INTERIOR STORM SCREEN TO BE REMOVED & DISPOSED.
- ④ NO INTERIOR STORM SCREEN.


WINDOW SCHEDULE												
NO.	SIZE	OPENING TYPE		FRAME ELEVATION	GLAZING			WALL TYPE		LINTEL	QUANTITY	REMARKS
		MASONRY OPENING	ALUM. CLAD WD.		INSULATING GLASS	TEMPERED GLASS	IMPRES PANEL	EXISTING MASONRY				
A	SEE ELEVATION 2/A3.0	•	•	2/A3.0	•	•	•	•	•	EX.	75	
A2	SEE ELEVATION 2/A3.0	•	•	2/A3.0	•	•	•	•	•	EX.	2	
B	SEE ELEVATION 2/A3.0	•	•	2/A3.0	•	•	•	•	•	EX.	27	
C	SEE ELEVATION 2/A3.0	•	•	2/A3.0	•	•	•	•	•	EX.	25	
D	SEE ELEVATION 2/A3.0	•	•	2/A3.0	•	•	•	•	•	EX.	12	
E	SEE ELEVATION 2/A3.0	•	•	2/A3.0	•	•	•	•	•	EX.	4	
F	SEE ELEVATION 2/A3.0	•	•	2/A3.0	•	•	•	•	•	EX.	8	
G	SEE ELEVATION 2/A3.0	•	•	2/A3.0	•	•	•	•	•	EX.	4	
H	SEE ELEVATION 2/A3.0	•	•	2/A3.0	•	•	•	•	•	EX.	8	
I	SEE ELEVATION 2/A3.0	•	•	2/A3.0	•	•	•	•	•	EX.	4	
J	SEE ELEVATION 2/A3.0	•	•	2/A3.0	•	•	•	•	•	EX.	1	
K	SEE ELEVATION 2/A3.0	•	•	2/A3.0	•	•	•	•	•	EX.	2	
L	SEE ELEVATION 2/A3.0	•	•	2/A3.0	•	•	•	•	•	EX.	1	
M	SEE ELEVATION 2/A3.0	•	•	2/A3.0	•	•	•	•	•	EX.	1	
N	SEE ELEVATION 2/A3.0	•	•	2/A3.0	•	•	•	•	•	EX.	2	
O	SEE ELEVATION 2/A3.0	•	•	2/A3.0	•	•	•	•	•	EX.	2	
X	SEE ELEVATION 2/A3.0	•	•	2/A3.0	•	•	•	•	•	EX.	1	
Y	SEE ELEVATION 2/A3.0	•	•	2/A3.0	•	•	•	•	•	EX.	4	
Z	SEE ELEVATION 2/A3.0	•	•	2/A3.0	•	•	•	•	•	EX.	15	
198 TOTAL												



**NEW WINDOW ELEVATIONS (CONTRACTOR TO FIELD VERIFY ALL EXISTING ROUGH OPENINGS & NEW WINDOW DIMENSIONS)**

SCALE: 3/8" = 1'-0"

2  
A3.0

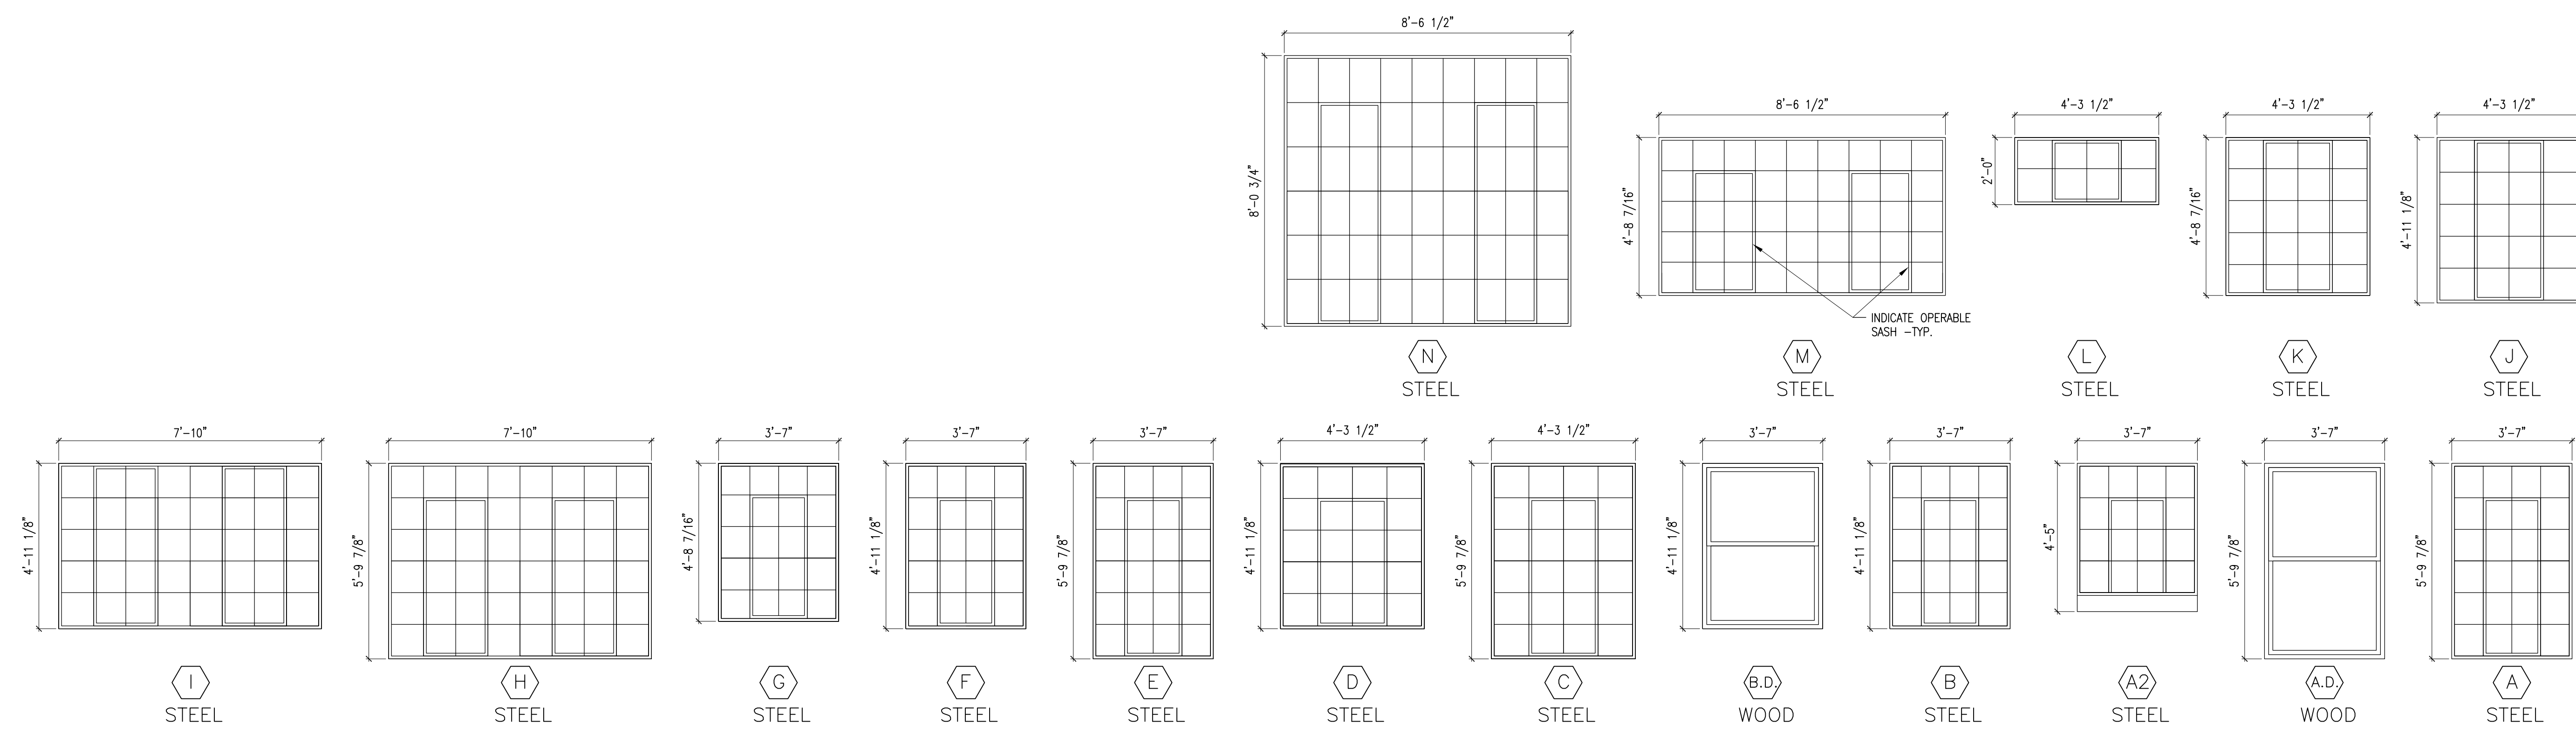

**EXISTING WINDOW ELEVATIONS - (TO BE DEMOLISHED) CONTRACTOR TO FIELD VERIFY ALL EXISTING ROUGH OPENINGS & EXISTING WINDOW DIMENSIONS**

SCALE: 3/8" = 1'-0"

1  
A3.0

ARCHITECT  
939 OFFICE PARK ROAD  
SUITE 101  
WEST DES MOINES, IA 50265  
TEL: 515-440-1681  
FAX: 515-440-1687



ENGINEER

FINAL ISSUED DRAWINGS

PROJECT TITLE  
**WRC BIRCHES WINDOW REPLACEMENT**  
WOODWARD, IA 50276

SHEET CONTENTS  
WINDOW ELEVATIONS & SCHEDULE

REVISIONS	
NOTE	DATE

DAS PROJECT NO.  
**9463.00**

GENESIS PROJECT NO.  
**2501**

ISSUE DATE  
**06-19-2025**

SHEET NUMBER

**A3.0**  
6 OF: 7



ENGINEER

FINAL ISSUED DRAWINGS

PROJECT TITLE  
**WRC BIRCHES WINDOW REPLACEMENT**  
 WOODWARD, IA 50276

SHEET CONTENTS  
 WINDOW DETAILS


REVISIONS	
NOTE	DATE

DAS PROJECT NO.  
**9463.00**


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**2501**

ISSUE DATE  
**06-19-2025**


SHEET NUMBER  
**A3.1**  
 7 OF 7

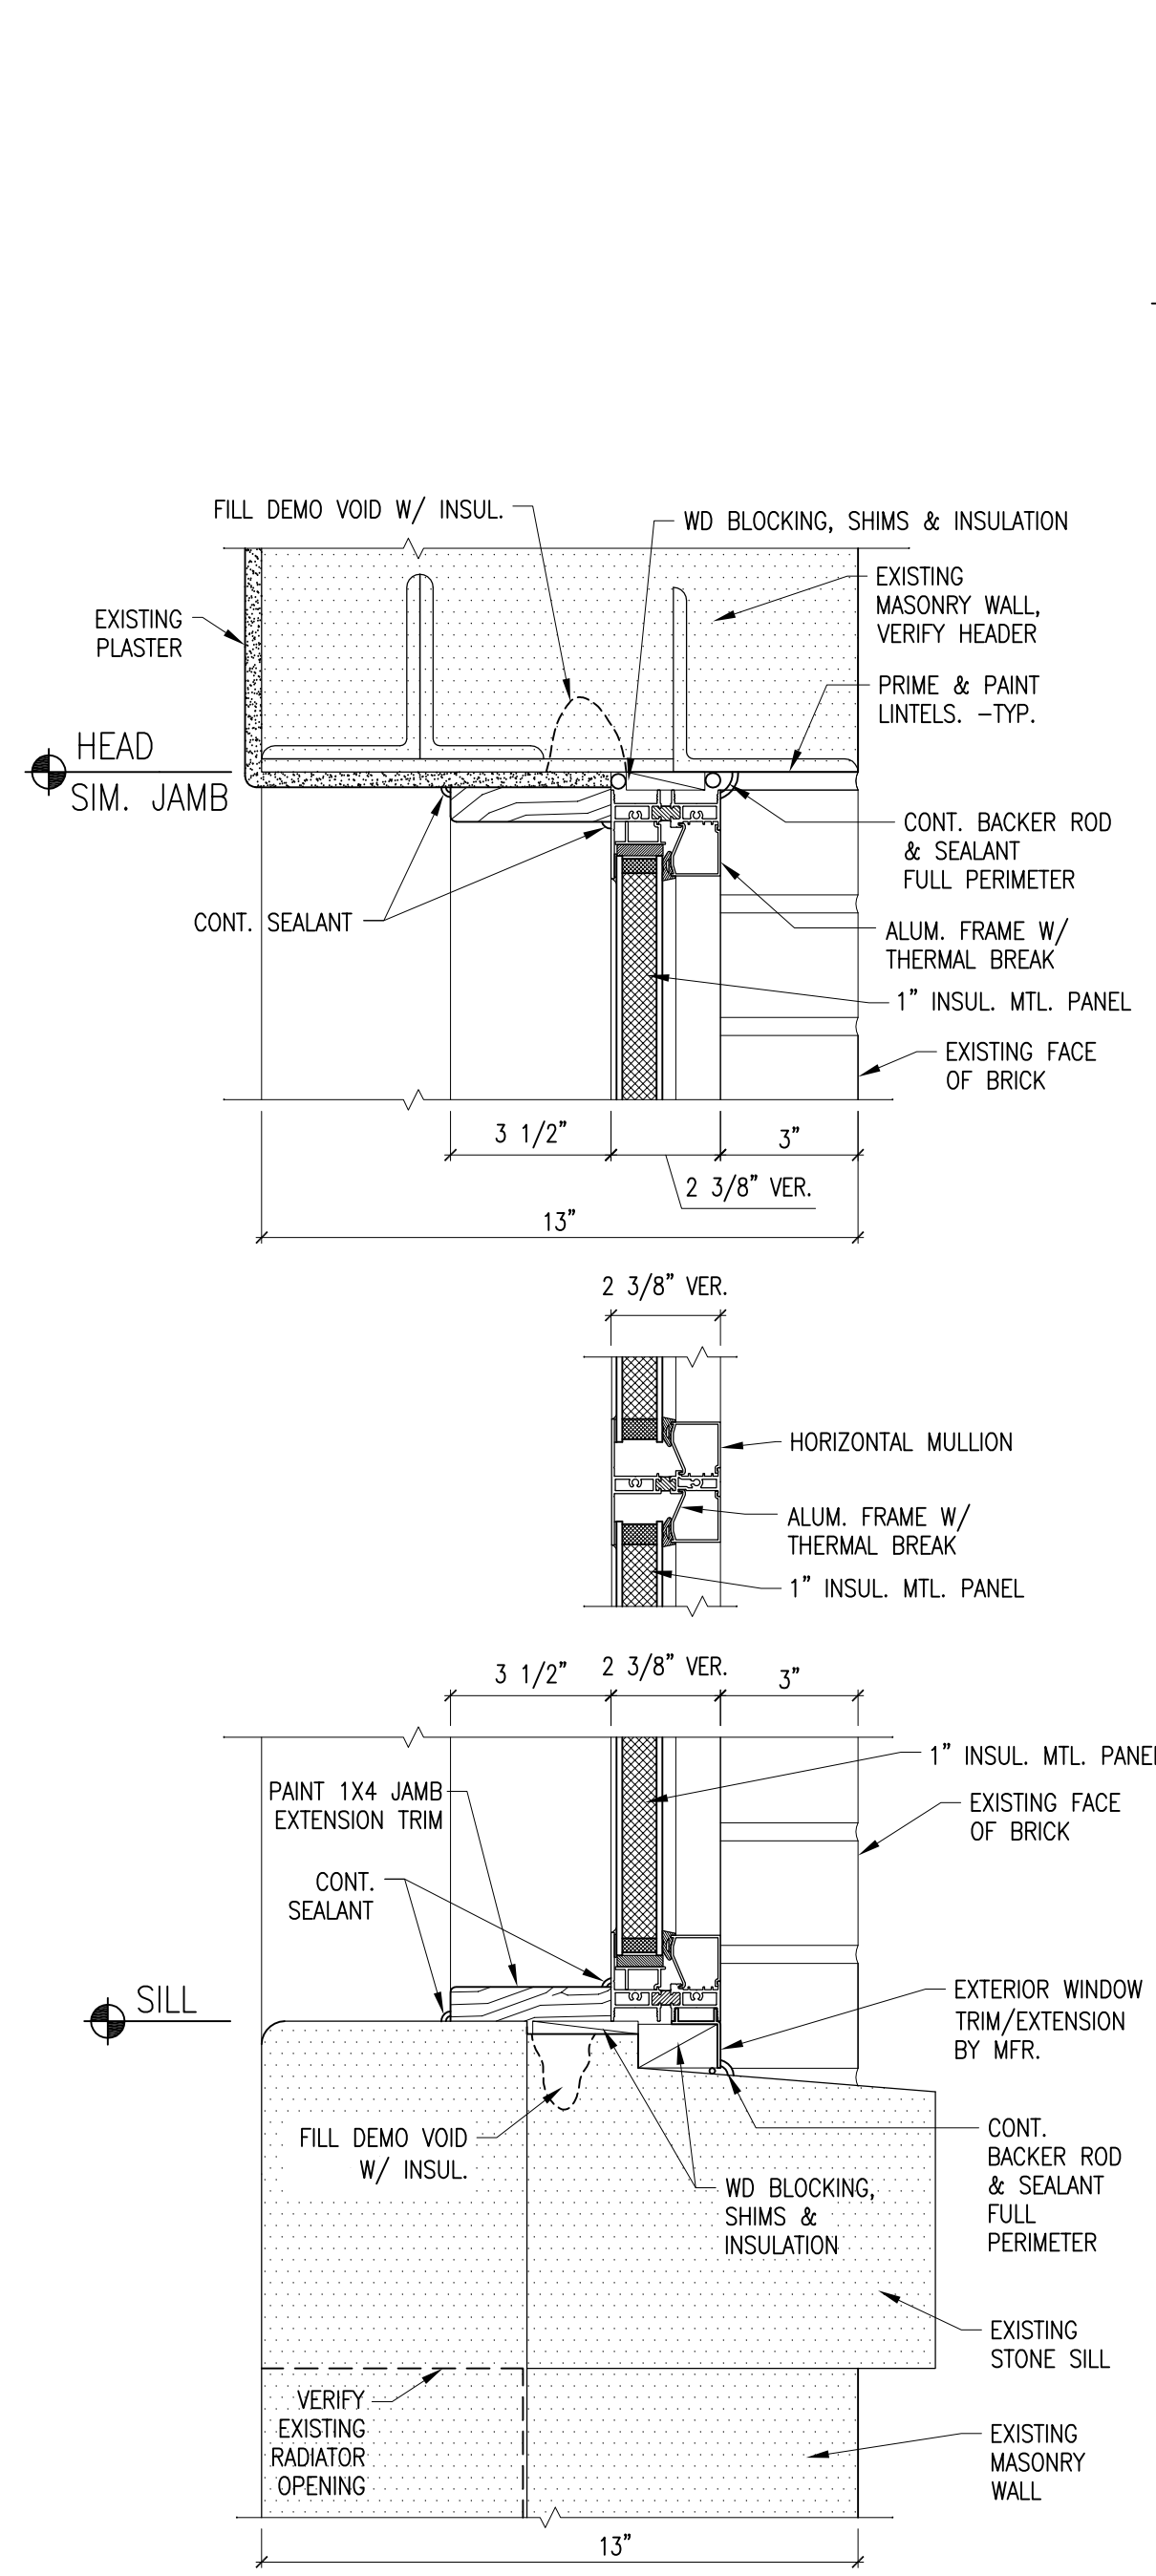


**MAPES PANEL WINDOW DETAIL** (6)  
 SCALE: 3" = 1'-0"

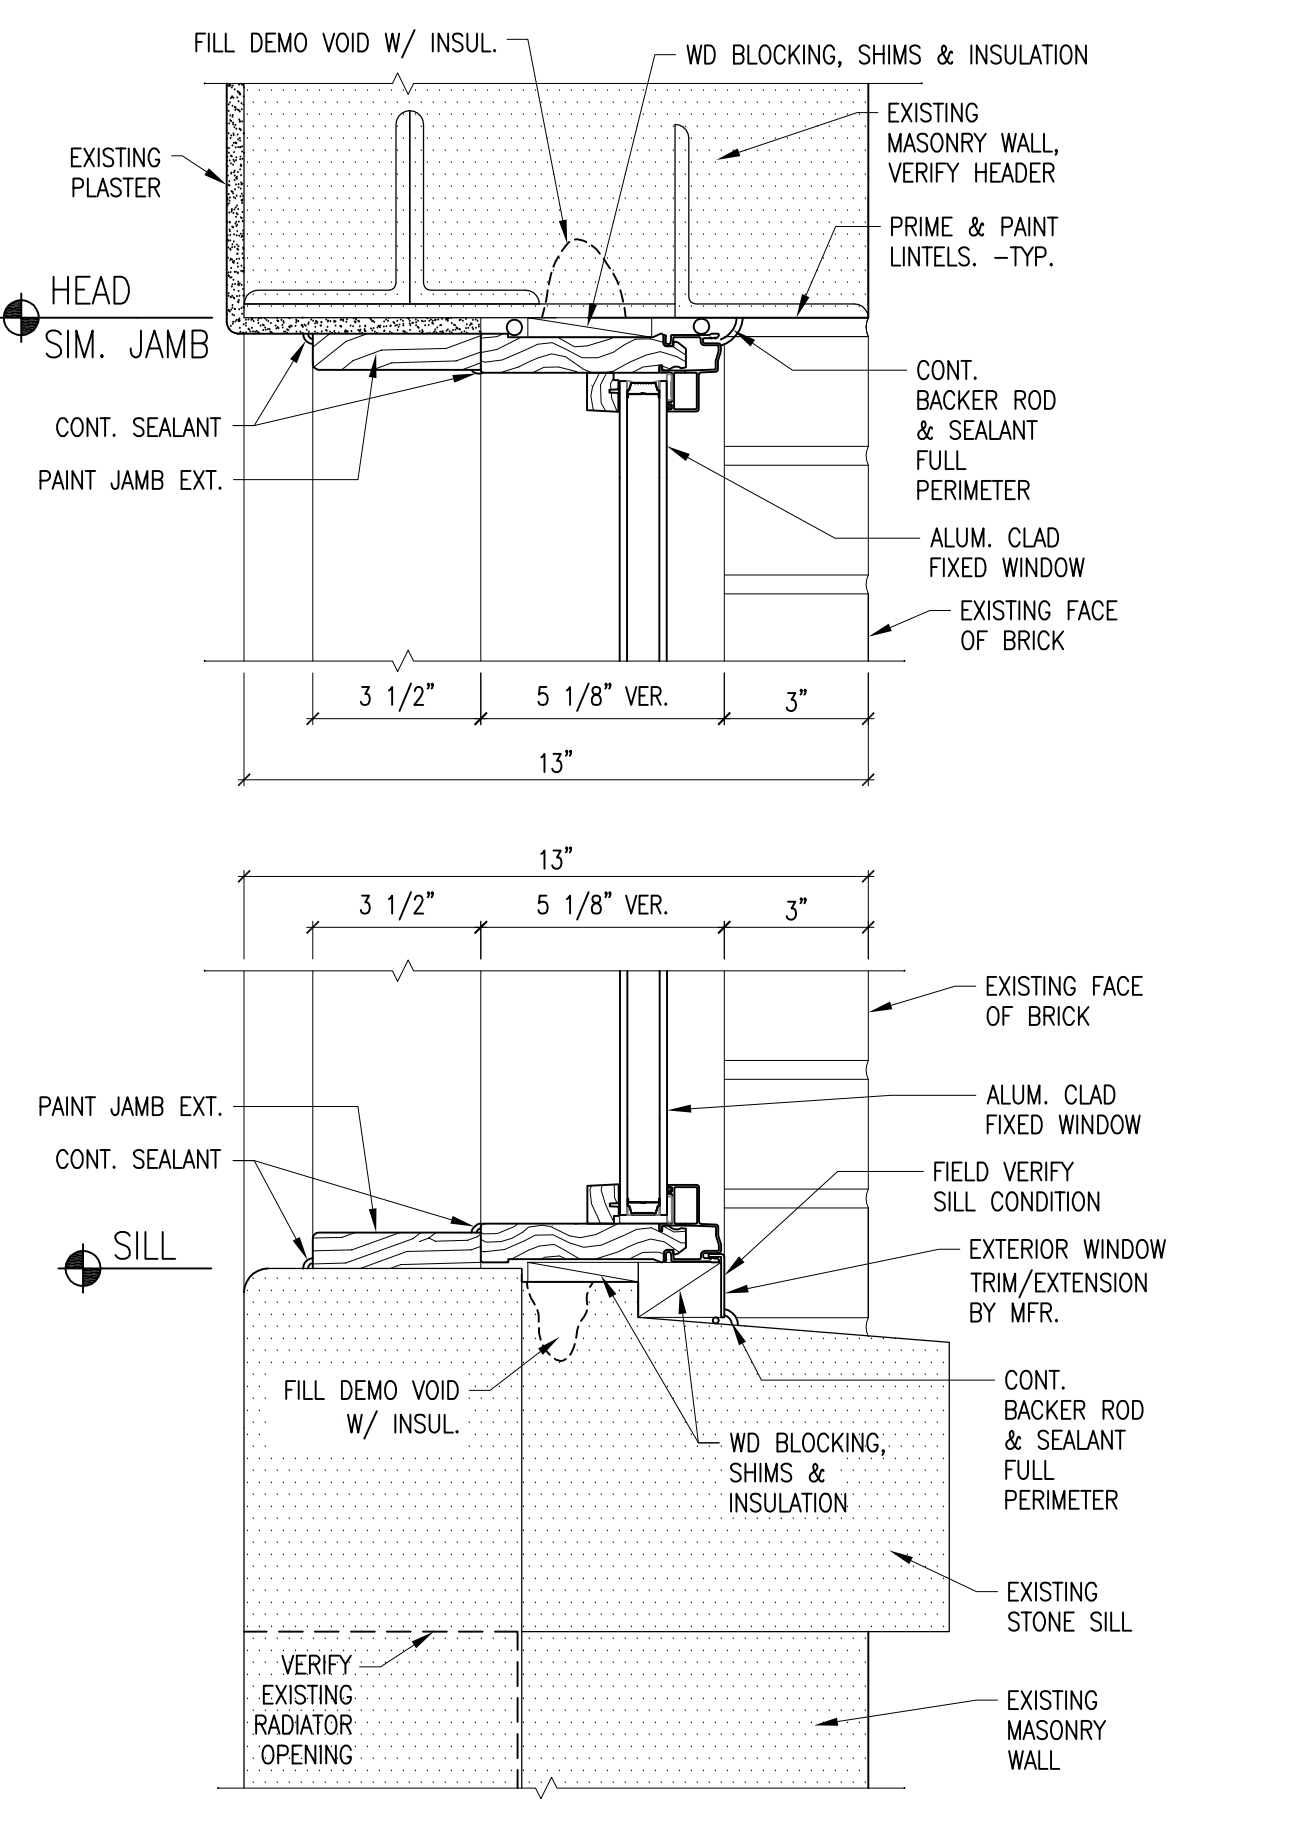


**1ST & 2ND FL. WINDOW DETAIL** (4)  
 SCALE: 3" = 1'-0"

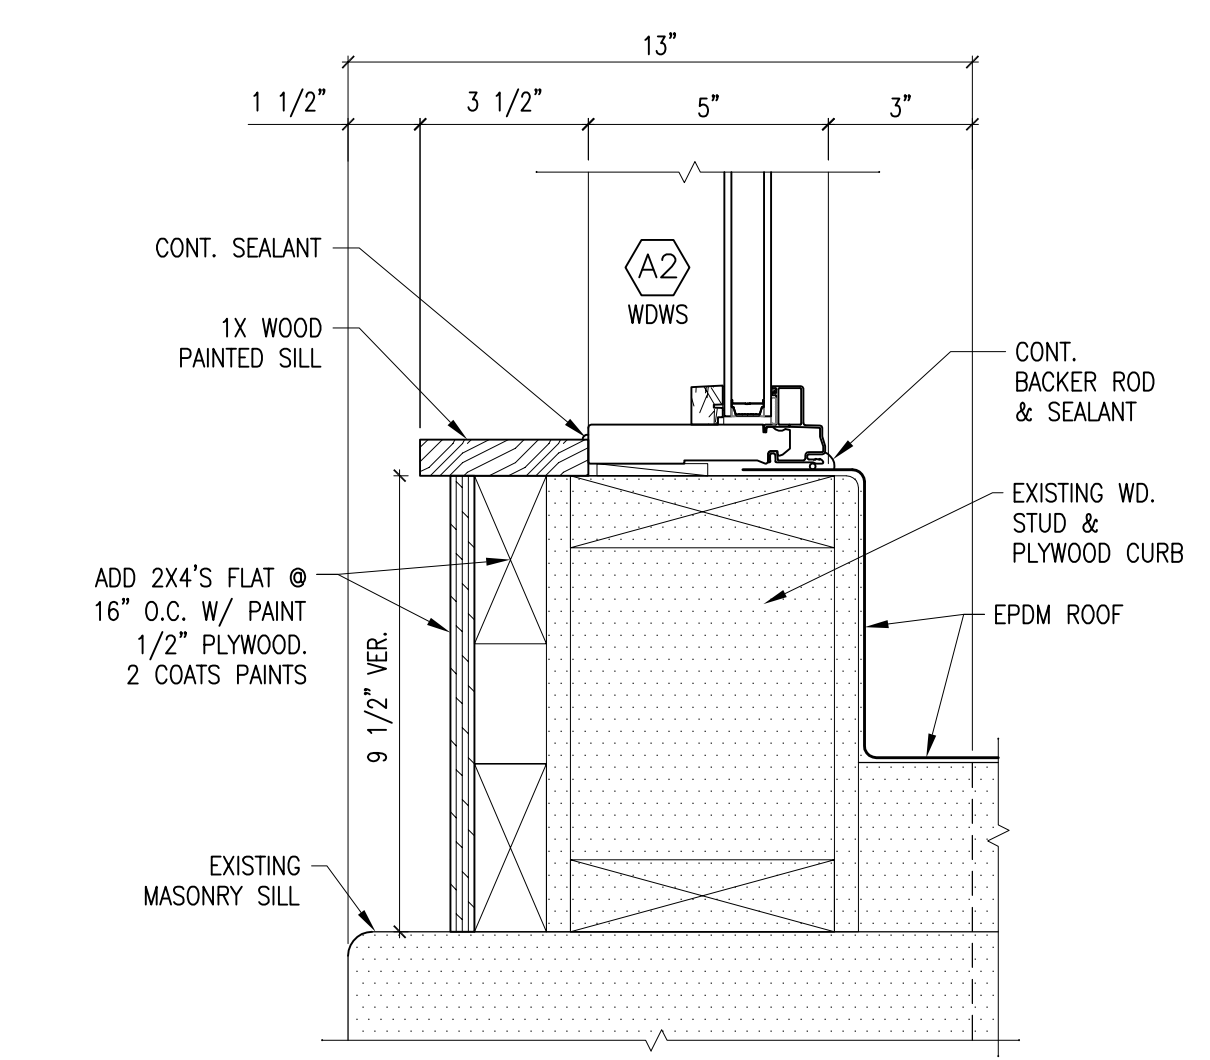


**ROOF CURB SILL WINDOW DETAILS** (5)  
 SCALE: 3" = 1'-0"

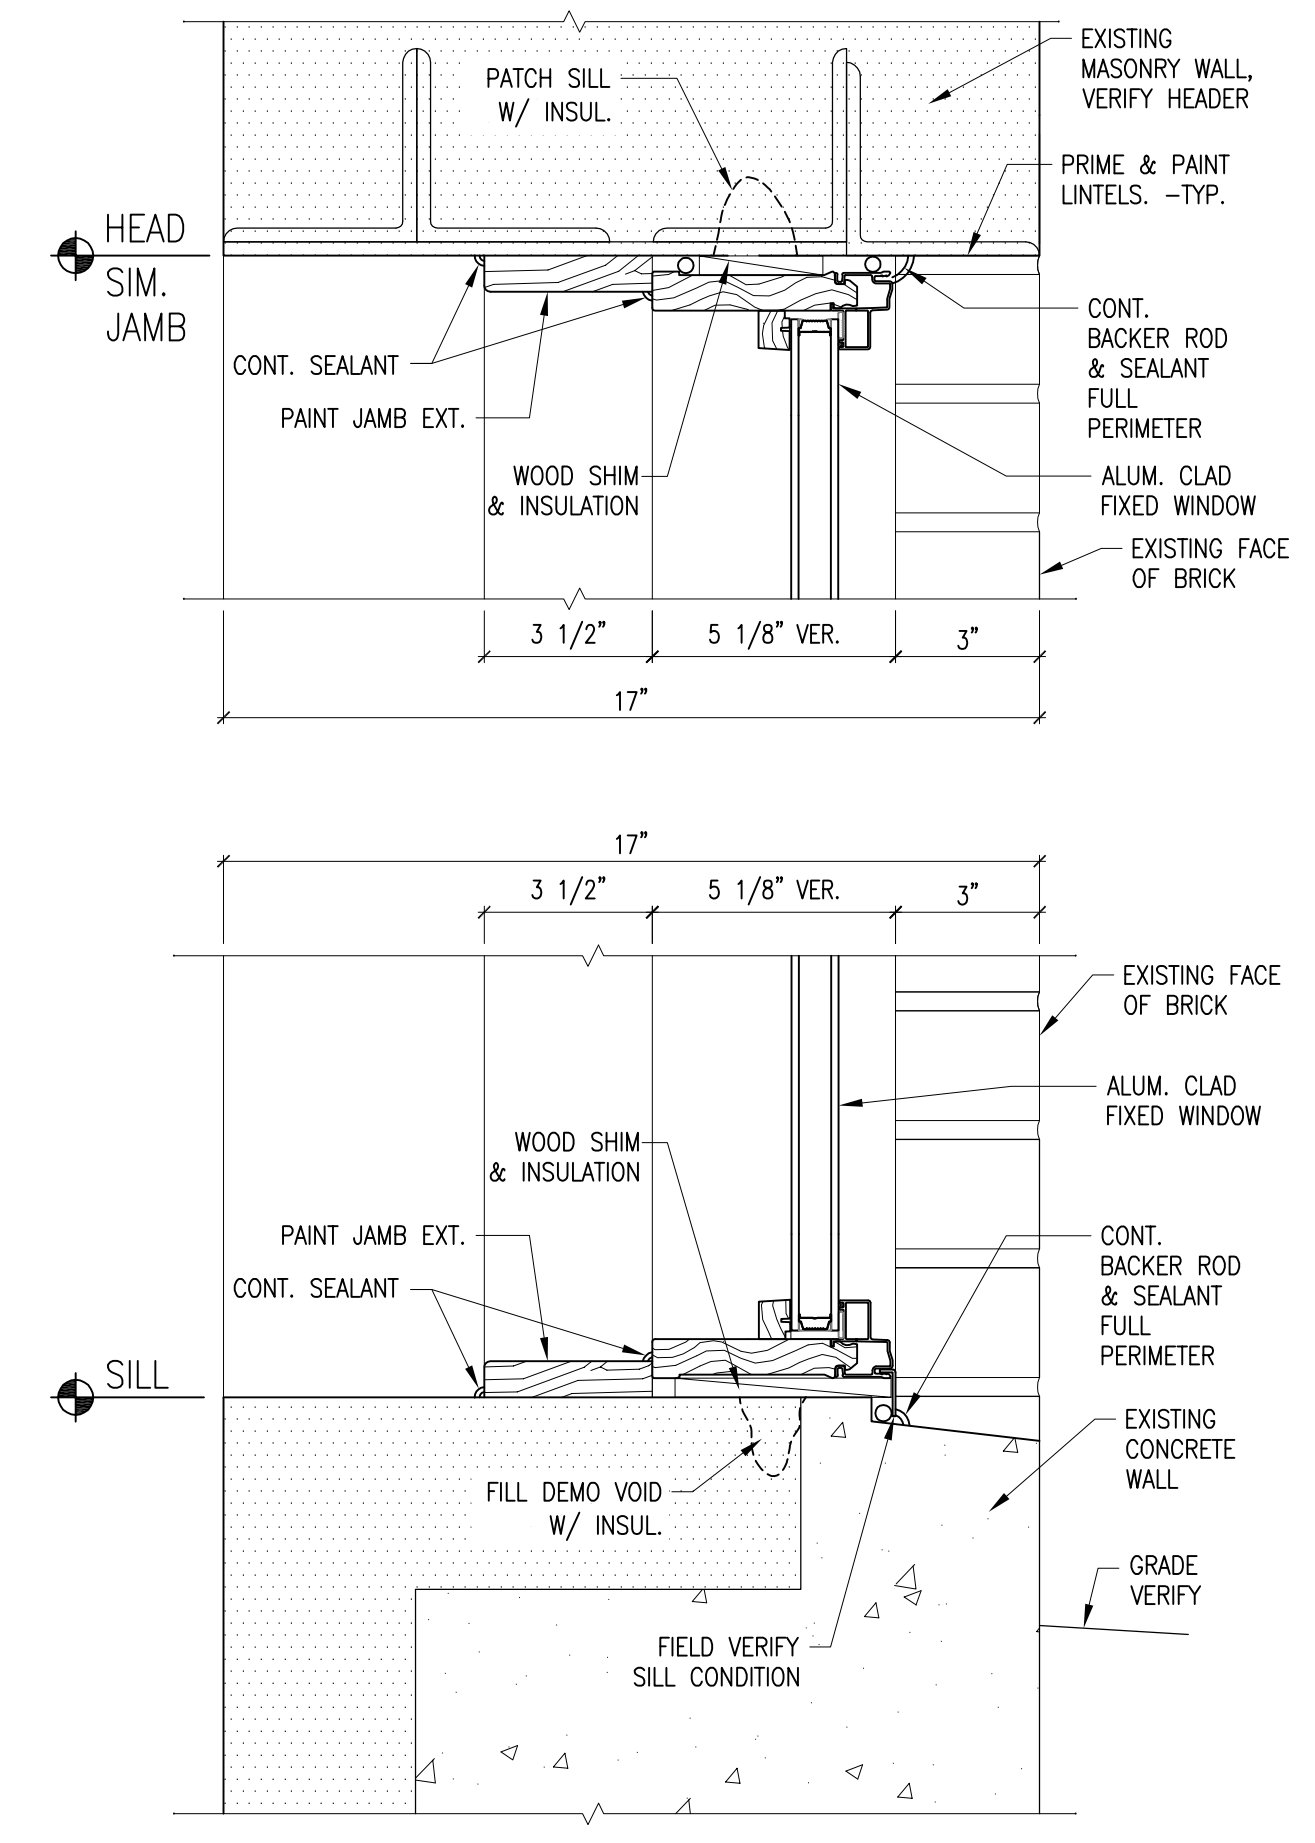

**BSMT FL. SILL WINDOW DETAILS** (3)  
 SCALE: 3" = 1'-0"

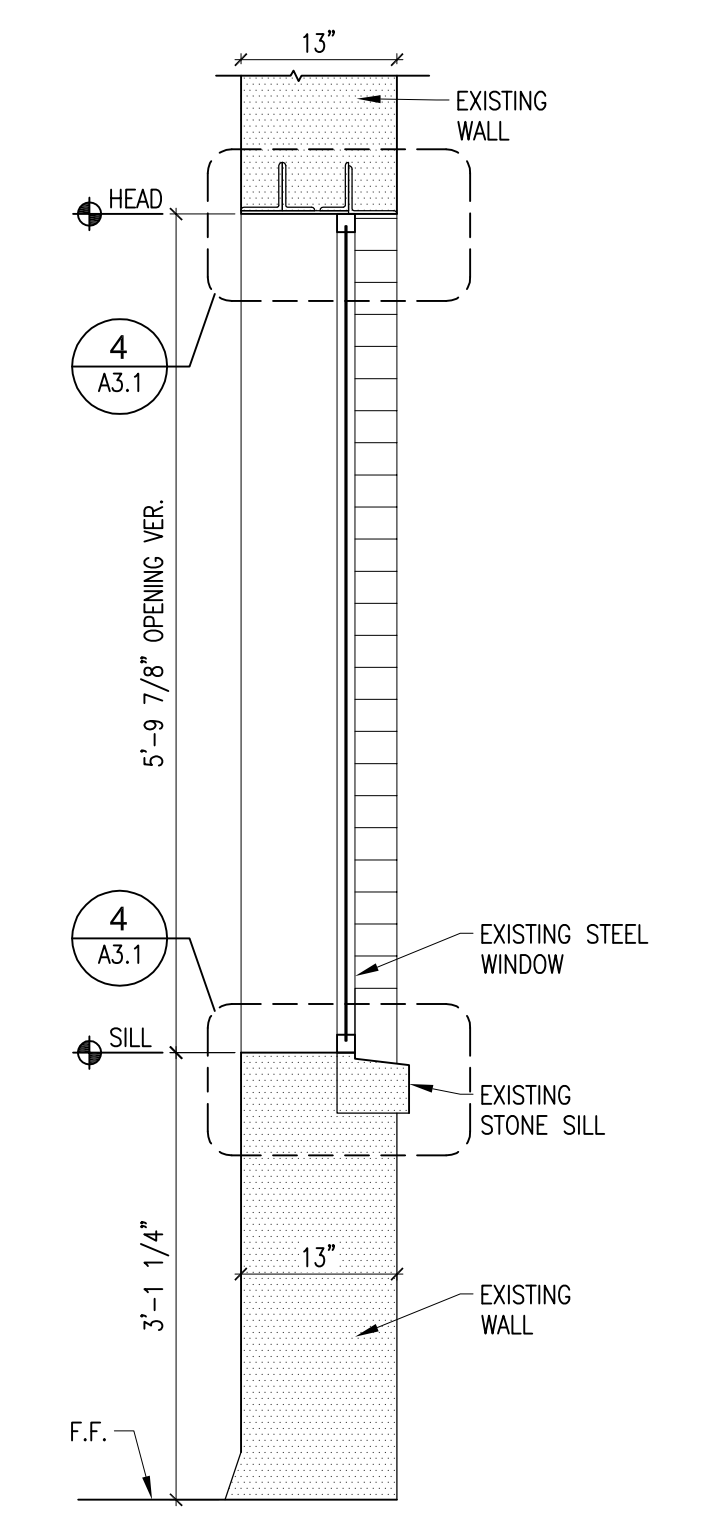

**EXISTING 1ST & 2ND FL. SECTION** (2)  
 SCALE: 3/4" = 1'-0"

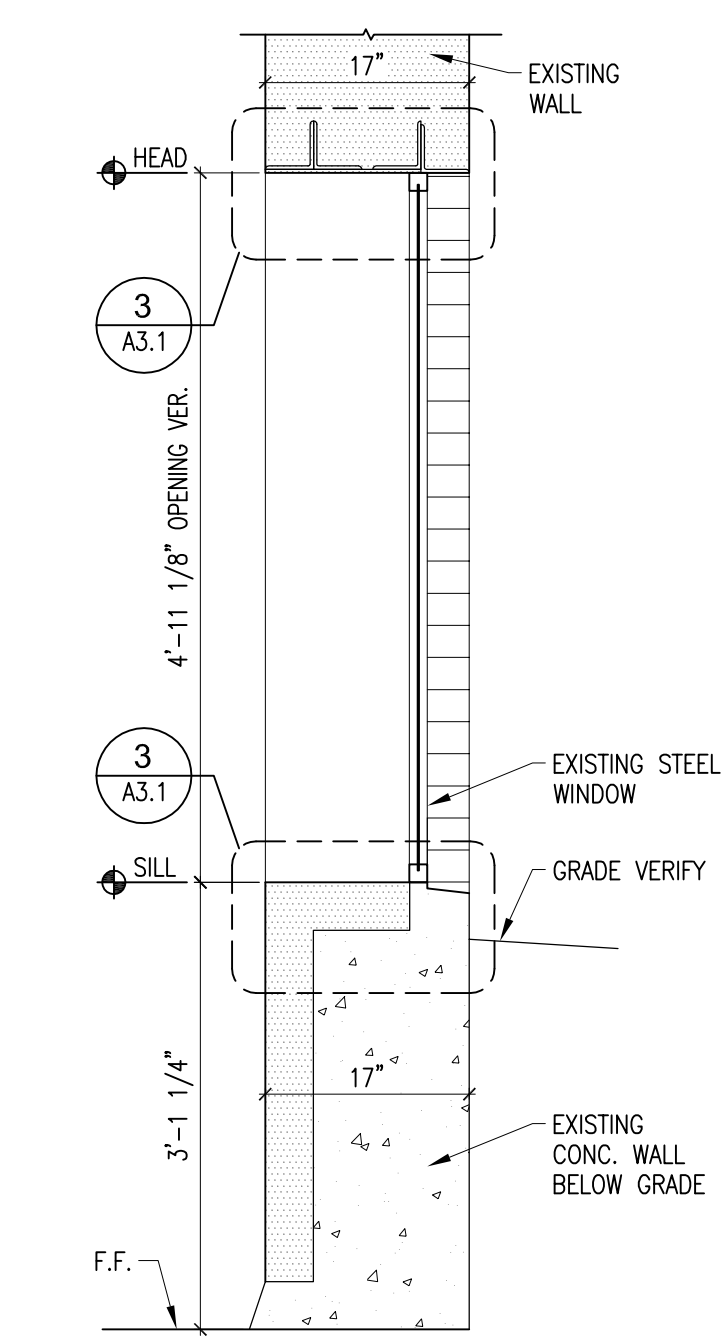

**EXISTING BSMT SECTION** (1)  
 SCALE: 3/4" = 1'-0"