ABBREVIATIONS

EQ **EQUAL** EXIST/EX **EXISTING** MIN MINIMUM MAX **MAXIMUM** O.C. ON CENTER **PREFIN PREFINISHED** REQMTS REQUIREMENTS S.S. STAINLESS STEEL

TYP

VER

DOC 1JD DPP BASEMENT WATER INFILTRATION MITIGATION

745 MAIN ST DUBUQUE, IOWA 52001

DAS PROJECT NO. 9390.00 **GENESIS PROJECT NO. 2406**

LOCATION MAP

TYPICAL

VERIFY

N.T.S.



SHEET INDEX

ARCHITECTURAL

A0.0 COVER A0.1 SITE MAP

PARTIAL BASEMENT PLAN

ALLEY & PARTIAL FIRST FLOOR PLAN A1.1

A1.2 PARTIAL SECOND FLOOR PLAN

ALLEY PHOTO ELEVATION A1.3

SECTION AND DETAILS

PLUMBING & ELECTRICAL

PARTIAL BASEMENT PLUMBING DEMO PLAN ALLEY PLUMBING UTILITY DEMO PLAN PARTIAL BASEMENT PLUMBING PLAN

P1.1 ALLEY PLUMBING UTILITY PLAN

PARTIAL BASEMENT ELECTRICAL DEMO PLAN PARTIAL BASEMENT ELECTRICAL DEMO PLAN

E1.0 PARTIAL BASEMENT ELECTRICAL PLAN

E1.1 ALLEY ELECTRICAL UTILITY PLAN

CONTACT LIST

OWNER:

STATE OF IOWA, DEPARTMENT OF ADMINISTRATIVE SERVICES 109 SE 13TH STREET DES MOINES, IOWA 50319

CLIENT:

DOC, FIRST DISTRICT 745 MAIN STREET DUBUQUE, IA 52001

CONSTRUCTION MANAGER:

DCI GROUP 220 SE 6TH STREET - SUITE 200 DES MOINES. IA 50309

PROJECT MANAGER: JARRAD BOEVER


MOBILE: 515-480-8280

ARCHITECT:

GENESIS ARCHITECTURAL DESIGN 939 OFFICE PARK ROAD WEST DES MOINES, IOWA 50265 EDWARD L. MATT. AIA OFFICE: 515-440-1681

DURANTEM MEP CONSULTING 3737 WOODLAND AVE. SUITE 420 WEST DES MOINES, IA 50266 CASEY ADAMS, P.E.

OFFICE: 515-452-8341

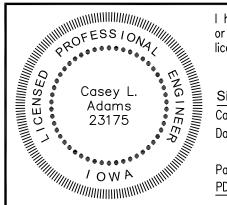

I hereby certify that this engineering document was prepared by me or under my direct personal supervision and that I am a duly licensed Professional Engineer under the laws of the State of lowa

Signature

Casey L. Adams Date Issued: Nov. 14, 2024 Rea No. 23175

Pages or sheets covered by this seal:

PD1.0, PD1.1, P1.0, P1.1, ED1.0, ED1.1, E1.0 & E1.1



hereby certify that the portion of this technical submission described below was prepared by me or under my supervisor and responsible charge. I am a duly registered Architect under the laws of the State of Iowa.

SO Holall-Signature

05761

Edward L. Matt

Pages or Sheets covered in part or whole by this seal: A0.0, A0.1, A1.0, A1.1, A1.2, A1.3 & A2.0.

Date Issued: MARCH 5, 2025



DOC 1JD BASEMENT WATER INFILTRATION MITIGATION 745 MAIN ST DUBUQUE, IOWA 52001 DPP

COVER

DAS NO. 9390.00

PROJECT NO. 2406

ISSUE DATE 03/05/2025

SHEET NUMBER A0.0

FILTRATION MITIGATION **BASEMENT WATE**

DPP

DAS NO. 9390.00

PROJECT NO. 2406

ISSUE DATE 03/05/2025

SHEET NUMBER A0.1


SITE NOTE:

- 1. CONTRACTOR PROVIDE WASTE DUMPSTER OR MAKE DAILY OFFSITE HAULS.
- 2. COORDINATE WITH BUILDING OWNER AND CITY FOR SIDEWALK, PARKING, AND ALLEY CLOSURE. CONTRACTOR TO PROVIDE TEMPORARY SITE BARRIERS & PAY CITY FEES FOR ALL CLOSURES & PERMITS.
- 3. CONTRACTOR TO COORDINATE DIRECT WITH THE CITY OF DUBUQUE FOR ALL UTILITY LOCATES, SERVICE INTERRUPTIONS, AND RECONNECTIONS.
- 4. COORDINATE WITH BUILDING OWNER FOR ACCESS TO ELECTRICAL AND WATER.
- 5. OWNER'S CM WILL PROVIDE PORTABLE TOILET.



PROPOSED DUMPSTER LOCATION IN STREET PARKING STALLS OR IN ALLEY.

PROJECT WORK AREA. COORDINATE WITH CITY & CM FOR PARTIAL ALLEY CLOSURE.

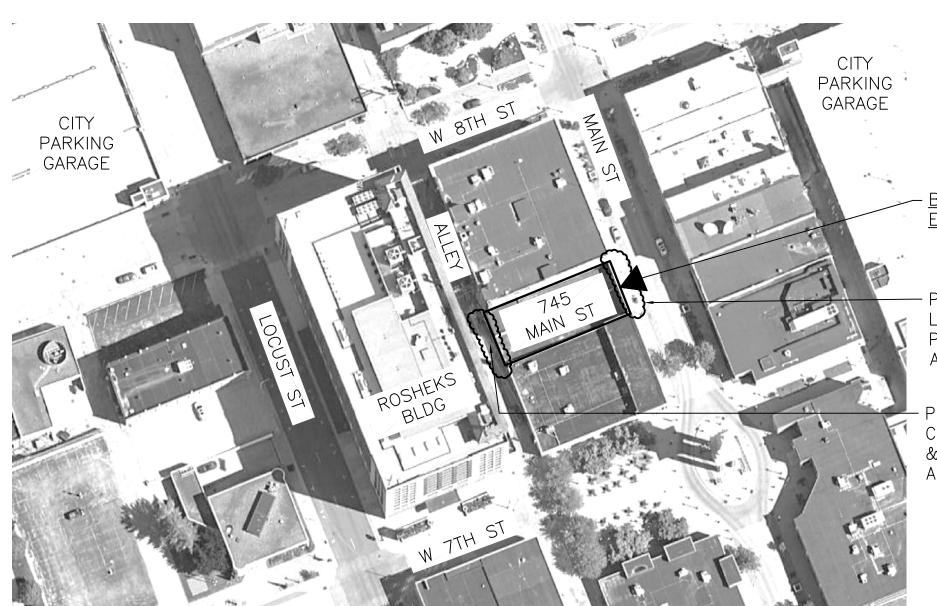





DOC 1JD
BASEMENT WATER INFILTRATION MITIGATION
745 MAIN ST
DUBUQUE, IOWA 52001

PARTIAL ASEMENT PLAN

DPP


DAS NO.


9390.00

PROJECT NO. 2406


03/05/2025


SHEET NUMBER
A1.0

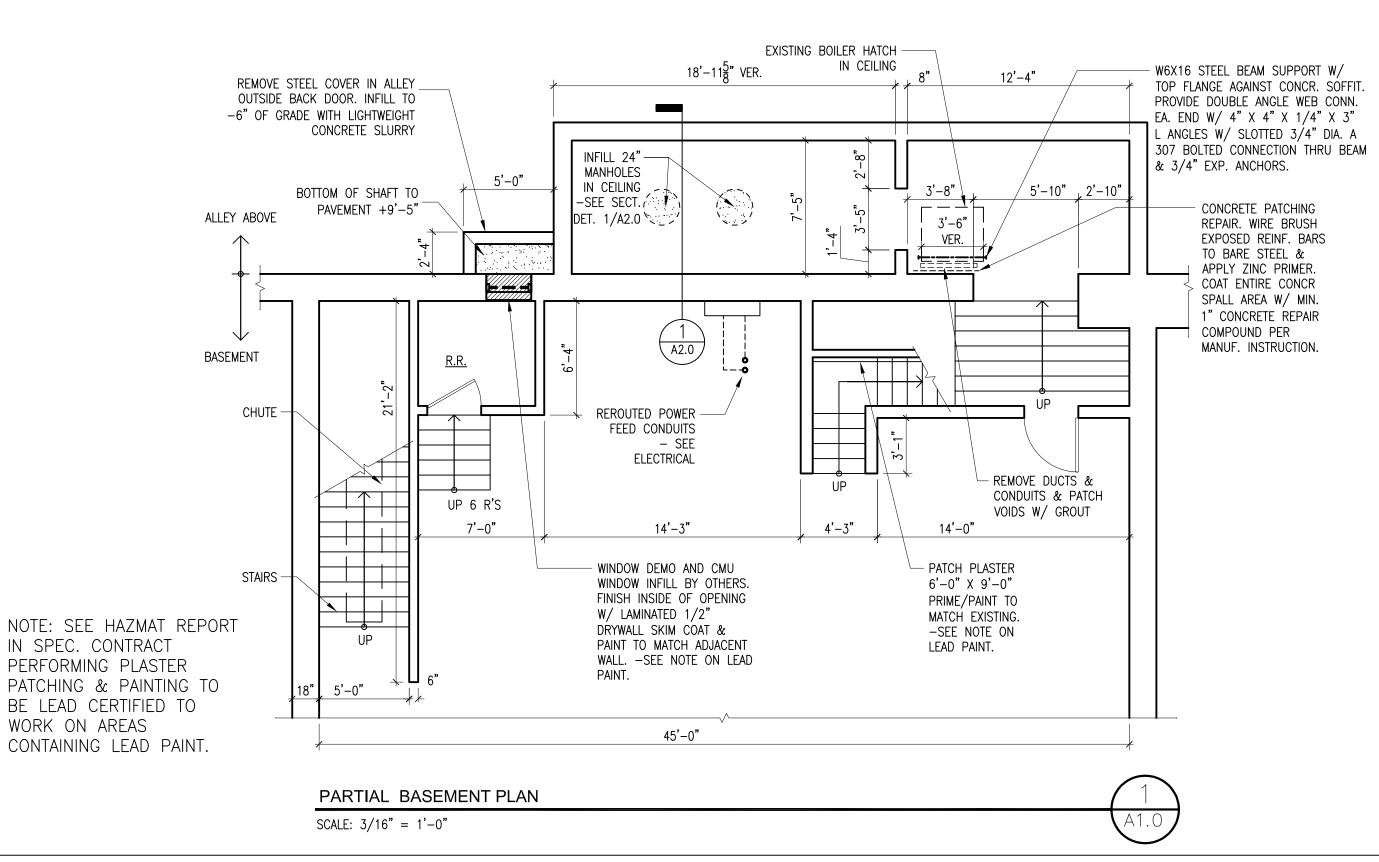

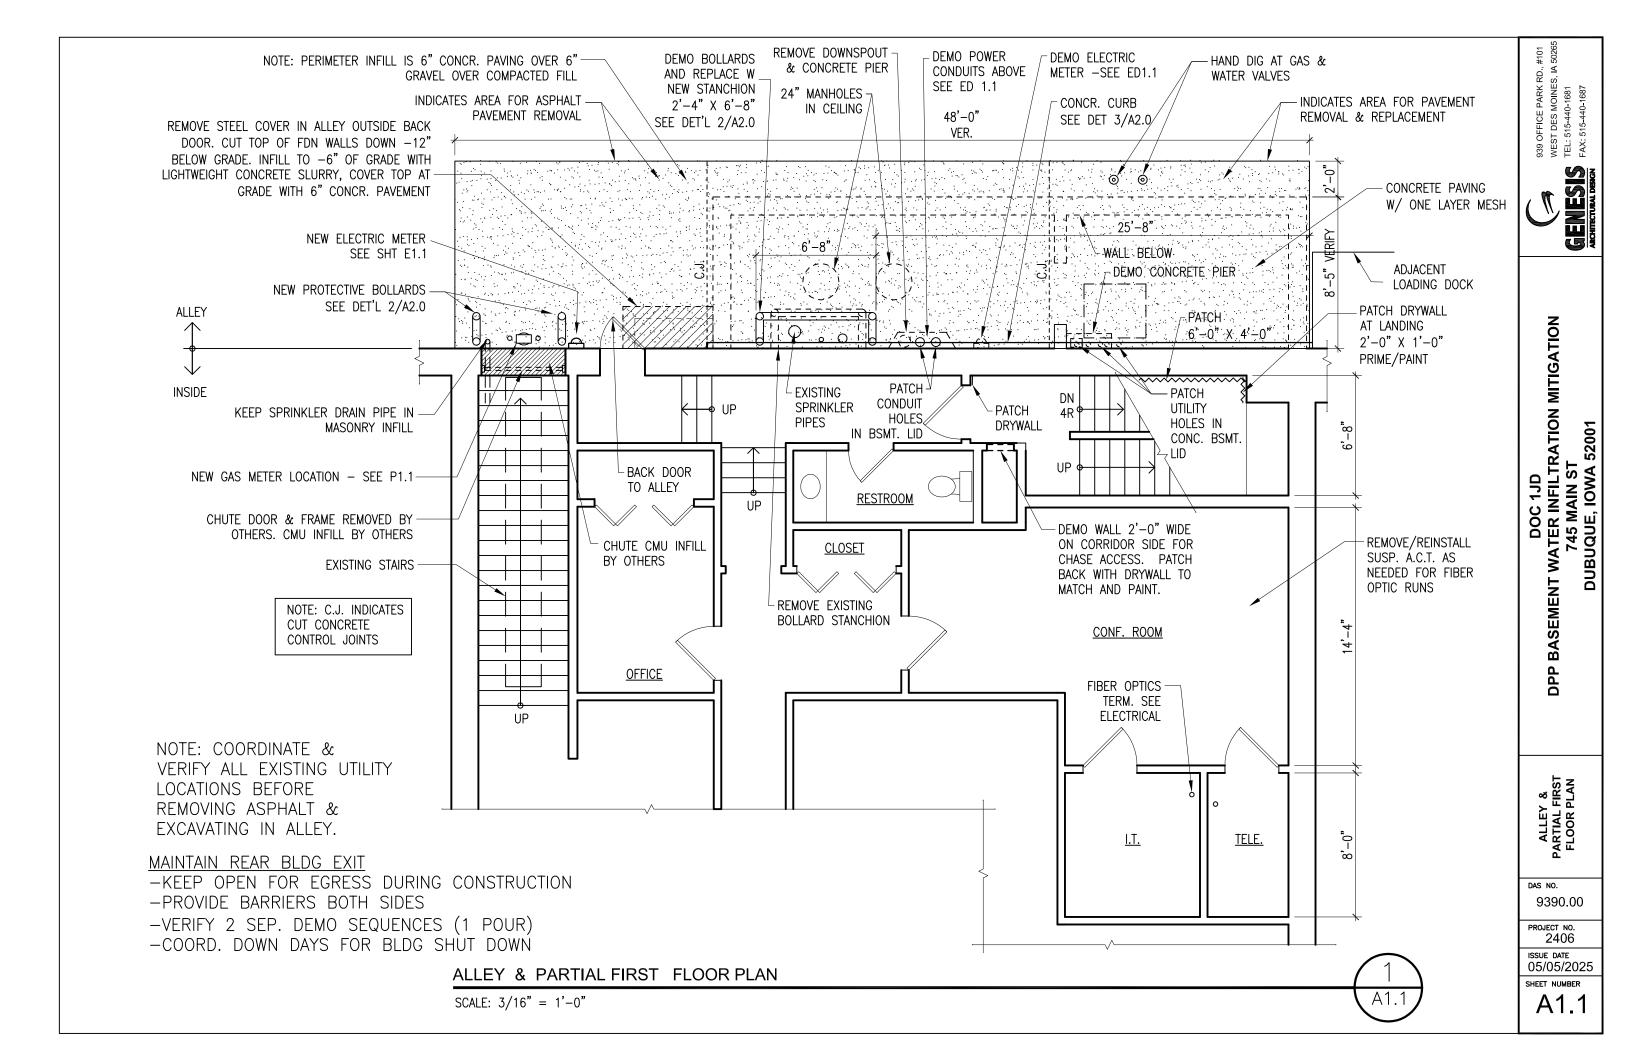

SEPARATE ROOFING PROJECT SO THAT PLASTER & PAINTING WORK IS DONE

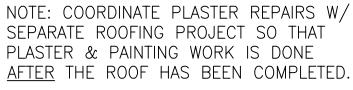

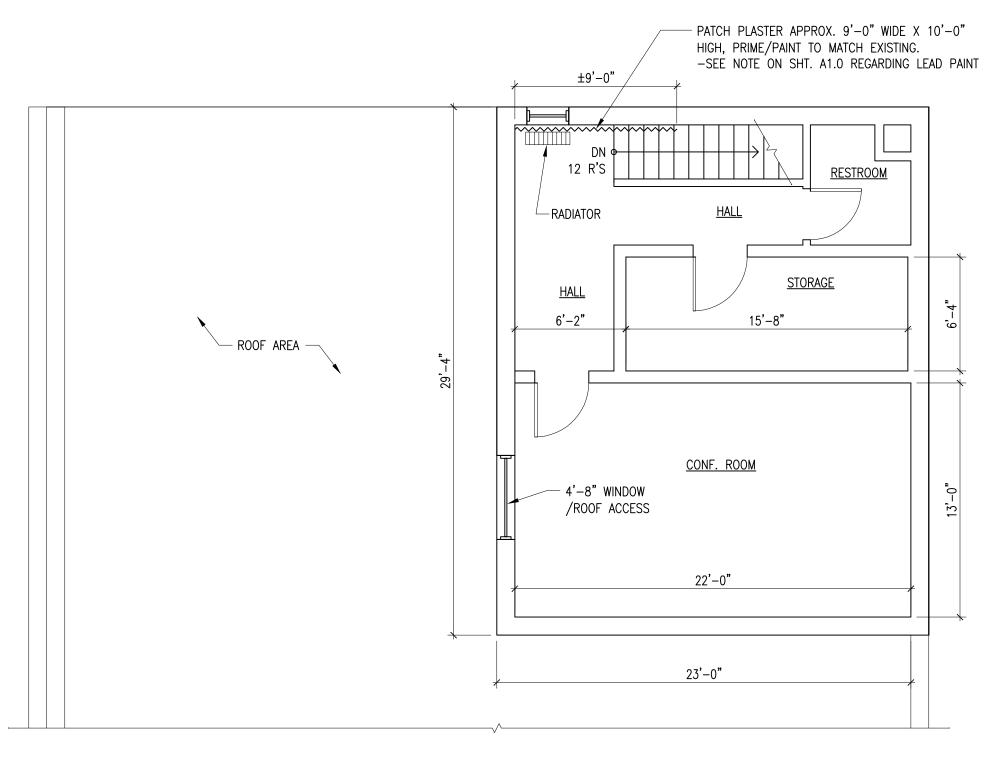

PARTIAL SECOND FLOOR PLAN

SCALE: 3/16" = 1'-0"



DOC 1JD BASEMENT WATER INFILTRATION MITIGATION 745 MAIN ST DUBUQUE, IOWA 52001

DPP

DAS NO. 9390.00

PROJECT NO. 2406

ISSUE DATE 03/05/2025 SHEET NUMBER

A1.2


9390.00

PROJECT NO. 2406

ISSUE DATE 03/05/2025

SHEET NUMBER A1.3



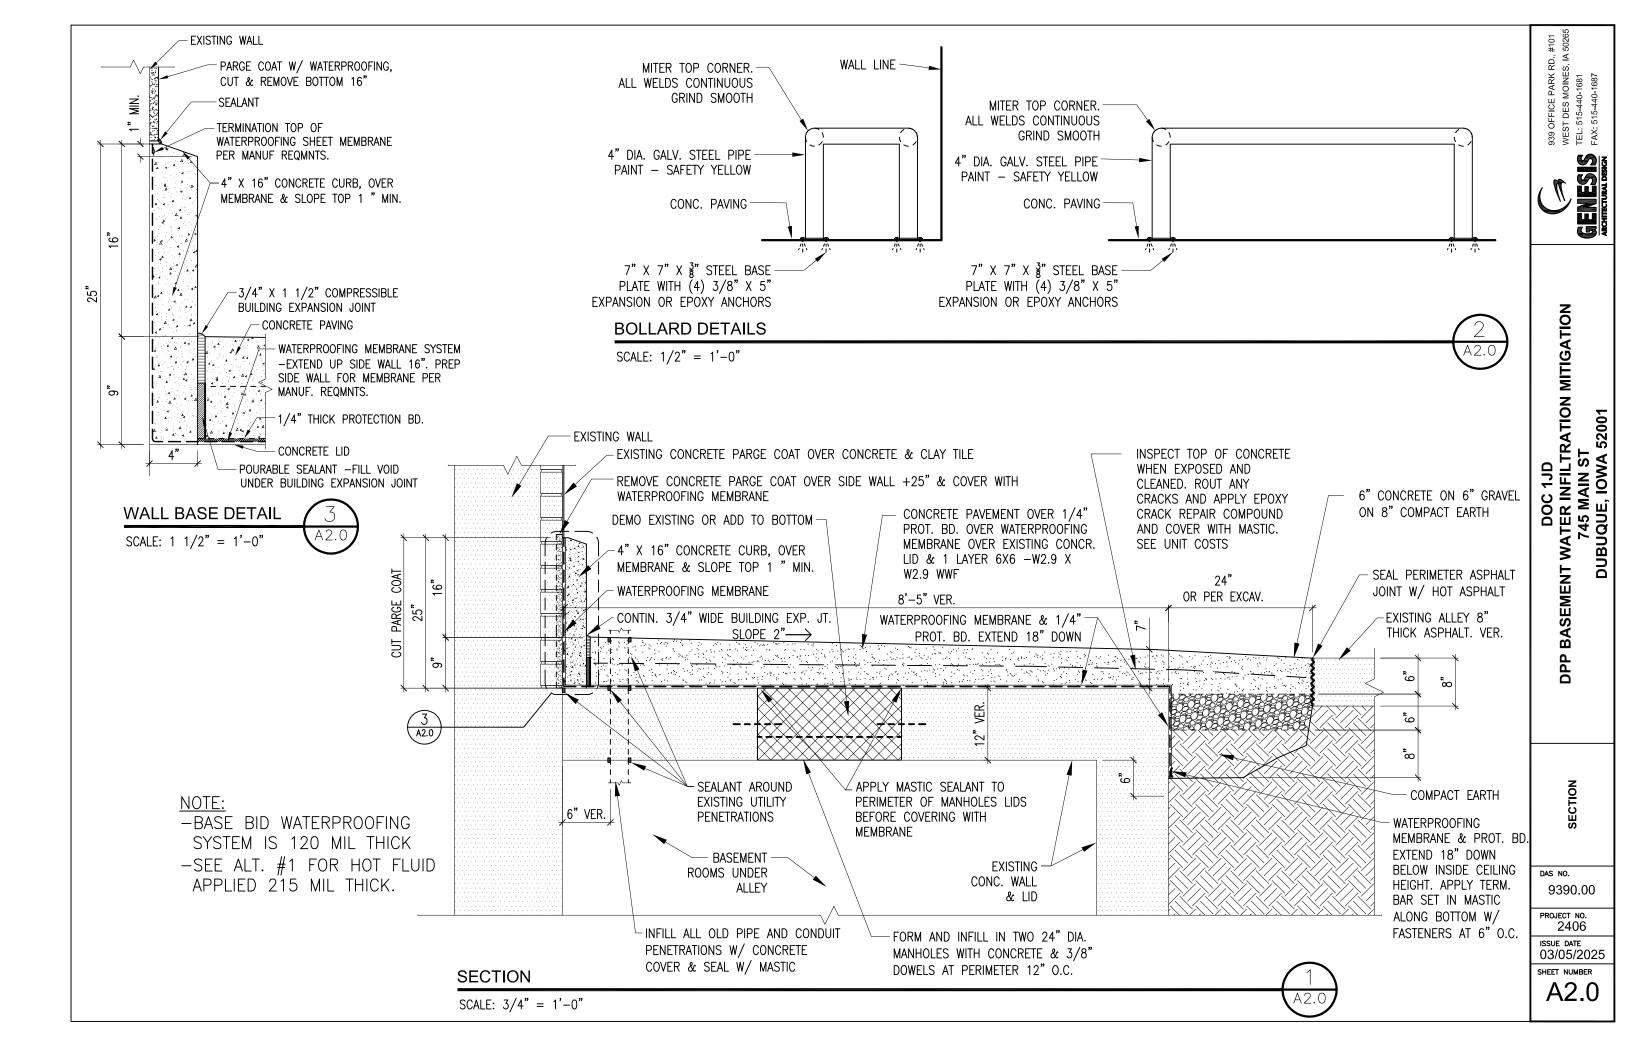

GENERAL PLUMBING NOTES

- 1. ALL WORK SHALL CONFORM TO THE REQUIREMENTS OF ALL APPLICABLE STATE, AND NATIONAL CODES, AS WELL AS LOCAL UTILITY REQUIREMENTS. PROVIDE ALL REQUIRED ACCESSORIES AND EQUIPMENT FOR A COMPLETE OPERATIONAL SYSTEM AND MAINTAIN WARRANTY REQUIREMENTS. VERIFY ALL EQUIPMENT PROVIDED IS SUITABLE FOR INTENDED USE.
- 2. WORK NOT SPECIFICALLY SHOWN IN DETAIL, REFERENCED, OR OTHERWISE IMPLIED, SHALL BE PROVIDED IN ACCORDANCE WITH TRADE OR INDUSTRY BEST STANDARD PRACTICES TO PROVIDE A COMPLETE OPERATIONAL SYSTEM.
- 3. ALL MATERIALS SHALL BE NEW AND SHALL BE OF THE TYPE AND SHALL MEET THE CAPACITIES OF EQUIPMENT SPECIFIED ON THE DRAWINGS.
- 4. ALL EQUIPMENT LISTED UNDER THESE SPECIFICATIONS SHALL BE LIMITED TO PRODUCTS REGULARLY PRODUCED AND RECOMMENDED FOR SERVICE IN ACCORDANCE WITH ENGINEERING DATA, RATINGS, OR OTHER COMPREHENSIVE LITERATURE MADE AVAILABLE TO THE PUBLIC AND IN EFFECT AT THE TIME OF OPENING BIDS.
- 5. EQUIPMENT SHALL BE INSTALLED IN STRICT ACCORDANCE WITH THE MANUFACTURER'S INSTRUCTIONS AND CODE REQUIREMENTS FOR TYPE AND CAPACITY OF EACH PIECE OF EQUIPMENT USED.
- 6. ALL CUTTING AND PATCHING REQUIRED FOR PLUMBING AND FIRE WORK SHALL BE PERFORMED BY THE MECHANICAL CONTRACTOR UNLESS NOTED OTHERWISE. ALL FINISHED SURFACES THAT ARE CUT SHALL BE REPLACED IN KIND SO THERE IS NO VISIBLE EVIDENCE OF CUTTING AND/OR PATCHING.
- 7. INSTALL HANGERS AND SUPPORTS AS REQUIRED TO ADEQUATELY AND SECURELY SUPPORT PLUMBING SYSTEM COMPONENTS IN A NEAT AND WORKMANLIKE MANNER. DO NOT FASTEN SUPPORTS TO PIPES, DUCTS, MECHANICAL EQUIPMENT, OR CONDUIT.
- COORDINATE PIPE ROUTING AND EQUIPMENT WITH BUILDING STRUCTURE, LIGHTING, AND FIRE ALARM DEVICES.
- 9. ALL EXPOSED MATERIALS SHALL BE PLENUM RATED.
- 10. NO LOADS SHALL BE PERMITTED TO BE HUNG FROM ROOF DECKING. ALL HANGERS SHALL BE HUNG DIRECTLY FROM STRUCTURE.
- 11. PROVIDE AS-BUILT DRAWINGS FOR PLUMBING AND FIRE SYSTEMS WITHIN 30 DAYS OF SUBSTANTIAL COMPLETION.
- 12. PROVIDE O&M MANUALS FOR ALL SYSTEMS AND EQUIPMENT TO OWNER WITHIN 30 DAYS OF SUBSTANTIAL COMPLETION.

9 OFFICE PARK RD., #101 EST DES MOINES, IA 50265 L: 515-440-1681



DOC 1JD PP BASEMENT WATER INFILTRATION MITIGATION 745 MAIN ST DUBUQUE, IOWA 52001

PLUMBING TES

PROJECT NO. 2406

03/05/25 SHEET NUMBER


PO.0

DEMO SPRINKLER PIPING AS INDICATED.

FOR CONTRACTOR REFERENCE ONLY: BLACK HILLS TO DEMO GAS REGULATOR VENT RISER TO ALLEY. REFER TO NEW WORK PLANS FOR RECONNECTION.

FOR CONTRACTOR REFERENCE ONLY: REMOVAL OF GAS METER, REGULATOR, AND GAS PIPING TO BE COMPLETED BY BLACK HILLS ENERGY. REFER TO NEW WORK PLANS FOR NEW GAS SERVICE ENTRANCE LOCATION. COORDINATE PHASING

OF WORK WITH UTILITY COMPANY.

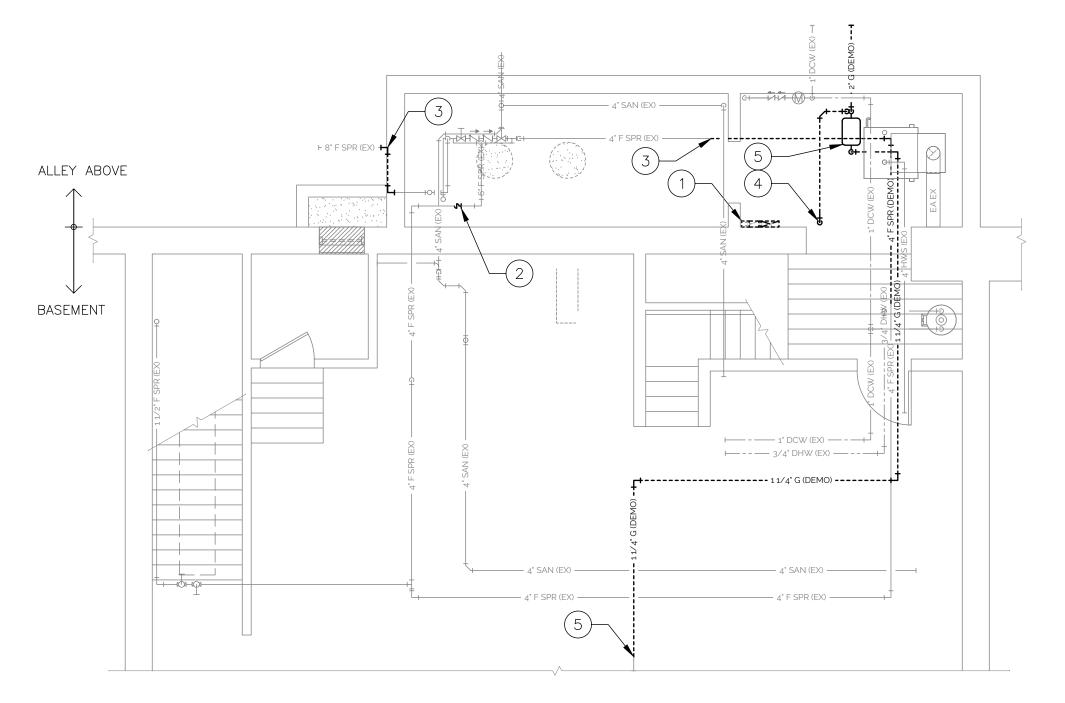



PARTIAL BASEMENT PLUMBING DEMO PLAN



MITIGATION DOC 1JD BASEMENT WATER INFILTRATION 745 MAIN ST DUBUQUE, IOWA 52001

PARTIAL BASEMENT PLUMBING DEMO PLAN

DPP

DAS NO.

9390.00


PROJECT NO. 2406 ISSUE DATE

03/05/25 SHEET NUMBER

PD1.0

2 FOR CONTRACTOR REFERENCE ONLY: BLACK HILLS TO DEMO GAS REGULATOR VENT RISER TO ALLEY.

TOR CONTRACTOR REFERENCE ONLY: WATER METER REMOTE READER TO BE RELOCATED BY CITY OF DUBUQUE WATER DEPARTMENT. REFER TO NEW WORK PLANS FOR NEW LOCATION.

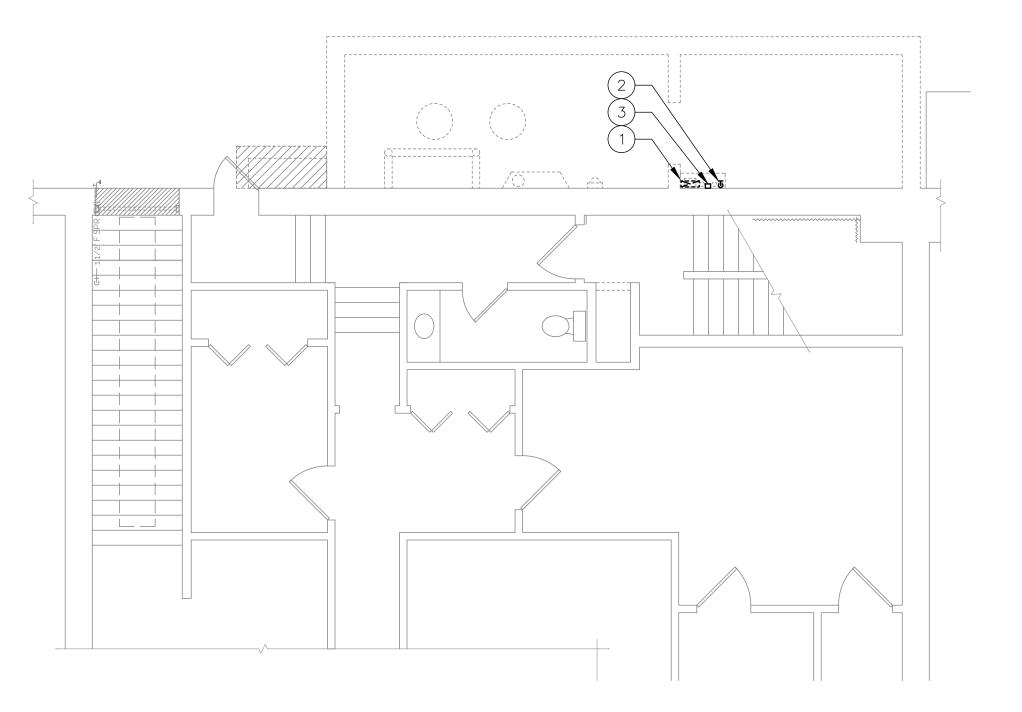



ALLEY & PARTIAL FIRST FLOOR PLUMBING DEMO PLAN

DFFICE PARK RD., #101 T DES MOINES, IA 50265 515-440-1681

WEST DES MOINES, TEL: 515-440-1681 FAX: 515-440-1687



DOC 1JD BASEMENT WATER INFILTRATION MITIGATION 745 MAIN ST DUBUQUE, IOWA 52001

> ALLEY PLUMBING UTILITY DEMO PLAN

DPP

DAS NO. 9390.00

PROJECT NO. 2406

O3/05/25 SHEET NUMBER

PD1.1

2 FOR CONTRACTOR REFERENCE ONLY: NATURAL GAS SERVICE UP TO METER. WORK TO BE PERFORMED BY BLACK HILLS ENERGY.

(3) FOR CONTRACTOR REFERENCE ONLY: CONNECT TO EXISTING GAS PIPING IN THIS AREA. WORK TO BE PERFORMED BY BLACK HILLS ENERGY.


4 FOR CONTRACTOR REFERENCE ONLY: 1-1/4" G UP. REFER TO SHEET P1.1 FOR CONTINUATION. WORK TO BE PERFORMED BY BLACK HILLS ENERGY.

SENESIS SENESIS

MITIGATION

DOC 1JD BASEMENT WATER INFILTRATION 745 MAIN ST DUBUQUE, IOWA 52001

DPP

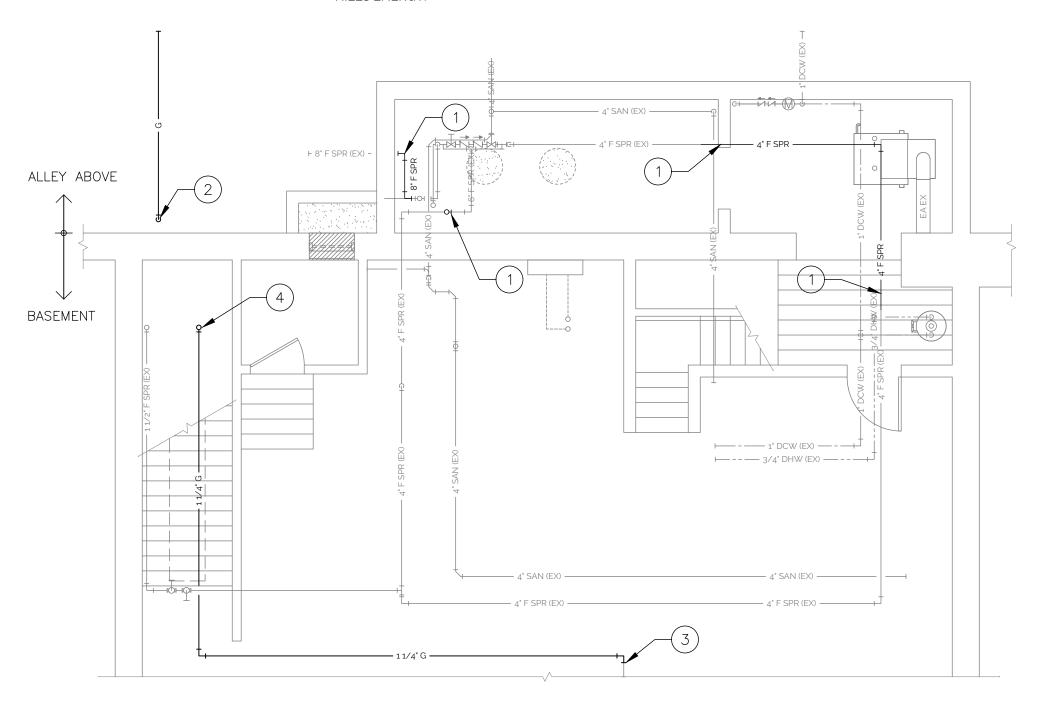



PARTIAL BASEMENT PLUMBING PLAN

3/16" = 1'-0"

PARTIAL BASEMENT
PLUMBING PLAN

9390.00


PROJECT NO. 2406 ISSUE DATE

03/05/25 SHEET NUMBER

P1.0



(3) FOR CONTRACTOR REFERENCE ONLY: 1-1/4" G DOWN. REFER TO SHEET P1.0 FOR CONTINUATION. WORK TO BE PERFORMED BY BLACK HILLS ENERGY.

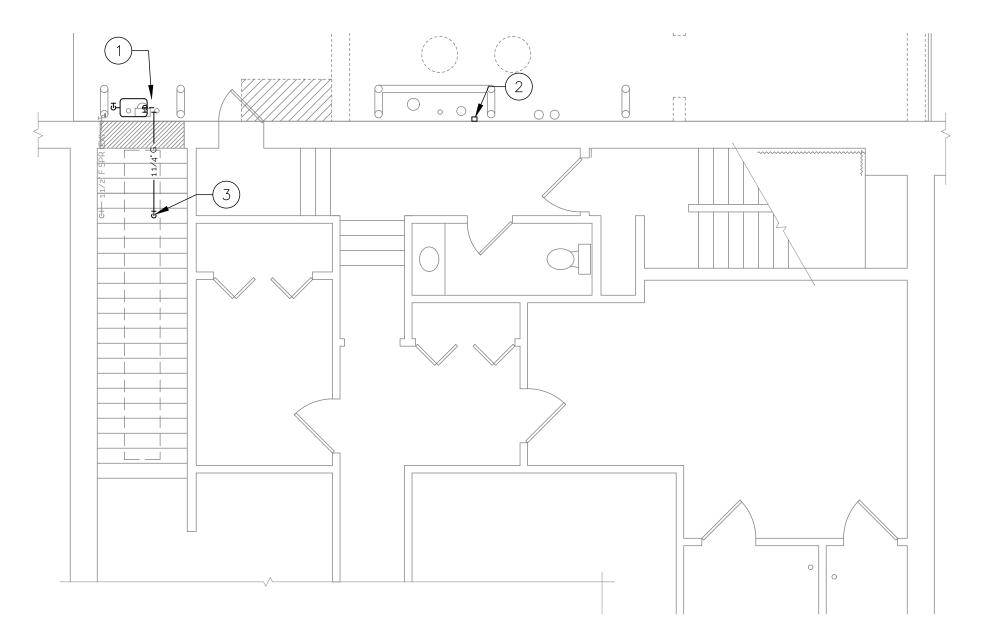



ALLEY & PARTIAL FIRST FLOOR PLUMBING PLAN

OFFICE PARK RD., #101 st DES MOINES, IA 50265 515-440-1681

DPP

PROJECT NO. 2406 ISSUE DATE

03/05/25 SHEET NUMBER

P1.1

GENERAL ELECTRICAL NOTES

- 1. ALL WORK SHALL CONFORM TO THE REQUIREMENTS OF ALL APPLICABLE STATE, AND NATIONAL CODES, AS WELL AS LOCAL UTILITY REQUIREMENTS. CONTRACTOR SHALL COORDINATE WITH LOCAL CODE OFFICIALS TO DETERMINE IF ANY CODE INTERPRETATIONS BY CODE ENFORCEMENT OFFICIALS WILL IMPACT PLANNED WORK.
- 2. PROVIDE ALL REQUIRED ACCESSORIES AND EQUIPMENT FOR A COMPLETE OPERATIONAL SYSTEM AND MAINTAIN WARRANTY REQUIREMENTS. VERIFY ALL EQUIPMENT PROVIDED IS SUITABLE FOR INTENDED USE. INSTALL ALL EQUIPMENT IN STRICT ACCORDANCE WITH MANUFACTURER'S INSTRUCTIONS.
- 3. WORK NOT SPECIFICALLY SHOWN IN DETAIL, REFERENCED, OR OTHERWISE IMPLIED, SHALL BE PROVIDED IN ACCORDANCE WITH TRADE OR INDUSTRY BEST STANDARD PRACTICES TO PROVIDE A COMPLETE OPERATIONAL SYSTEM.
- 4. COORDINATE EXACT WIRING REQUIREMENTS WITH MANUFACTURER'S REQUIREMENTS FOR EACH FIXTURE AND PIECE OF EQUIPMENT.
- 5. INSTALL HANGERS AND SUPPORTS AS REQUIRED TO ADEQUATELY AND SECURELY SUPPORT ELECTRICAL SYSTEM COMPONENTS IN A NEAT AND WORKMANLIKE MANNER AS SPECIFIED IN NECA 1. DO NOT FASTEN SUPPORTS TO PIPES, DUCTS, MECHANICAL EQUIPMENT, OR CONDUIT.
- 6. INSTALL CONDUIT SECURELY IN A NEAT AND WORKMANLIKE MANNER AS SPECIFIED IN NECA 1.
- 7. EQUIPMENT CONNECTIONS: MAKE CONDUIT CONNECTIONS TO EQUIPMENT USING FLEXIBLE CONDUIT.
- 8. INSTALL DISCONNECT SWITCHES, CONTROLLERS, CONTROL STATIONS, AND CONTROL DEVICES TO COMPLETE EQUIPMENT WIRING REQUIREMENTS.
- 9. PROVIDE AS-BUILT DRAWINGS FOR ELECTRICAL SYSTEMS WITHIN 30 DAYS OF SUBSTANTIAL COMPLETION.
- 10. PROVIDE 0&M MANUALS FOR ALL SYSTEMS AND EQUIPMENT TO OWNER WITHIN 30 DAYS OF SUBSTANTIAL COMPLETION.
- 11. ALL EXPOSED CABLING SHALL BE PLENUM RATED.
- 12. CONTRACTOR(S) SHALL UNCONDITIONALLY WARRANTY IN WRITING ALL MATERIALS, EQUIPMENT, AND WORKMANSHIP FOR ONE YEAR FROM DATE OF ACCEPTANCE BY OWNER. CONTRACTOR(S) SHALL PROVIDE FREE SERVICE FOR ALL EQUIPMENT INVOLVED IN THEIR CONTRACT DURING THE WARRANTY PERIOD.

9 OFFICE PARK RD., #101 EST DES MOINES, IA 50265 L: 515-440-1681



DOC 1JD BASEMENT WATER INFILTRATION MITIGATION 745 MAIN ST DUBUQUE, IOWA 52001

GENERAL ELECTRICAL NOTES

Ь

pas no. 9390.00

PROJECT NO. 2406

03/05/25 SHEET NUMBER


EO.0

REMOVE (2) LINES OF FIBER OPTIC CABLING AND CONDUIT AS INDICATED. COORDINATE REMOVAL OF 3RD LINE OF FIBER OPTICE CABLING WITH MEDIACOM. MINIMIZE SHUTDOWN(S) TO NIGHT/WEEKEND AS MUCH AS POSSIBLE. COORDINATE SHUTDOWN WITH OWNER.

DEMO CIRCUITS SERVING DOWNSPOUT HEAT TRACE. COORDINATE HEAT TRACE LOCATIONS AND REVISIONS WITH ROOFING REPLACEMENT AND TUCKPOINTING PROJECTS. REFER TO NEW WORK PLANS FOR NEW CONDUIT ROUTING.

REMOVE FIRE ALARM GONG CONDUCTORS TO FIRE SPRINKLER SERVICE. REFER TO SHEET ED1.1 FOR GONG LOCATION.

COORDINATE REMOVAL OF PHONE LINES AND SPLICE BOX WITH CENTURYLINK. MINIMIZE SHUTDOWN(S) TO NIGHT/WEEKEND AS MUCH AS POSSIBLE. COORDINATE SHUTODOWN WITH OWNER.

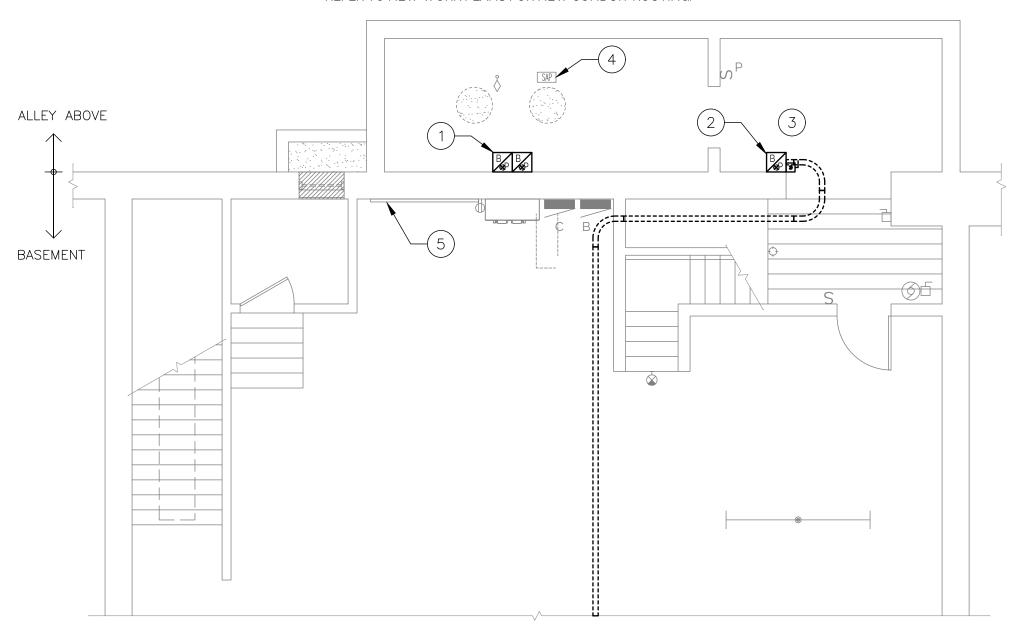



PARTIAL BASEMENT ELECTRICAL DEMO PLAN

MITIGATION

DOC 1JD BASEMENT WATER INFILTRATION 745 MAIN ST DUBUQUE, IOWA 52001 DPP

PARTIAL BASEMENT ELECTRICAL DEMO PLAN

DAS NO.

9390.00

PROJECT NO. 2406

ISSUE DATE 03/05/25

SHEET NUMBER ED1.0


REMOVE (2) LINES OF FIBER OPTIC CABLING AND CONDUIT AS INDICATED. COORDINATE REMOVAL OF 3RD LINE OF FIBER OPTICE CABLING WITH MEDIACOM. DO NOT CUT/SEVER CABLING; CABLING IS TO BE REUSED. MINIMIZE SHUTDOWN(S) TO NIGHT/WEEKEND AS MUCH AS POSSIBLE. COORDINATE SHUTDOWN WITH OWNER.

REMOVE ABANDONED CONDUIT. CONDUIT IS ROUTED UP THROUGH SHEET METAL ENCLOSURE TO ~10'-0" ABOVE GRADE, THEN ROUTES HORIZONTALLY ~15'-0". REMOVE ENTIRE LENGTH OF ABANDONED CONDUIT.

REMOVE FIRE ALARM GONG. REMOVE CONDUCTORS BACK TO FIRE SPRINKLER SERVICE IN BASEMENT SPRINKLER ROOM. REFER TO SHEET ED1.0 FOR BASEMENT SPRINKLER ROOM LOCATION. SALVAGE GONG FOR REUSE.

COORDINATE REMOVAL OF PHONE LINES AND SPLICE BOX WITH CENTURYLINK. MINIMIZE SHUTDOWN(S) TO NIGHT/WEEKEND AS MUCH AS POSSIBLE. COORDINATE SHUTODOWN WITH OWNER.

REROUTE CIRCUITS SERVING DOWNSPOUT HEAT TRACE. COORDINATE HEAT TRACE LOCATIONS AND REVISIONS WITH ROOFING REPLACEMENT AND TUCKPOINTING PROJECTS.

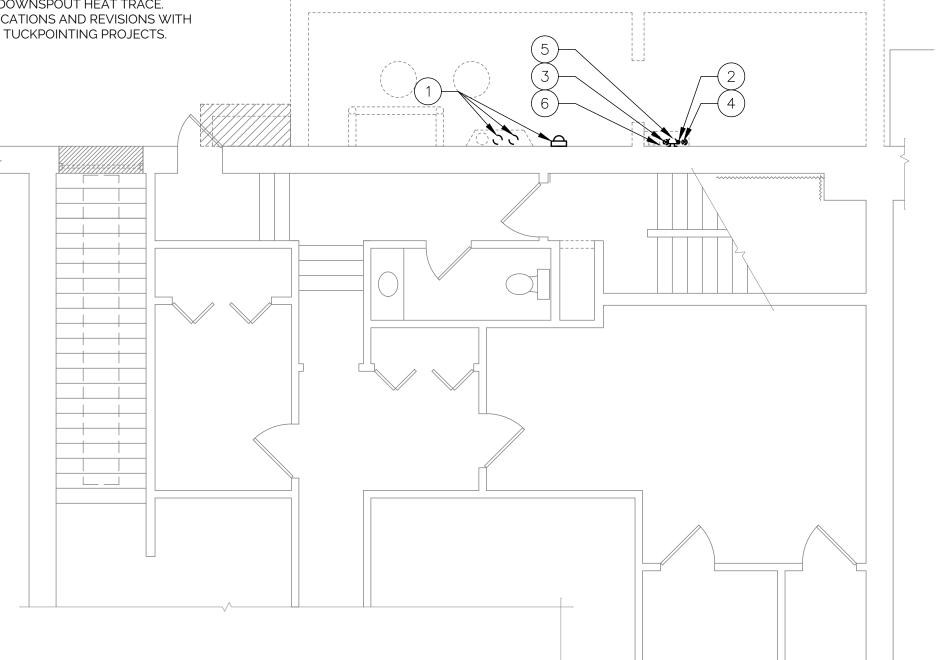



ALLEY & PARTIAL FIRST FLOOR ELECTRICAL DEMO PLAN

MITIGATION DOC 1JD SEMENT WATER INFILTRATION M 745 MAIN ST DUBUQUE, IOWA 52001 BASI DPP

ALLEY & PARTIAL FIRST FLOOR ELECTRICAL DEMO PLAN

DAS NO. 9390.00

PROJECT NO. 2406

ISSUE DATE 03/05/25

SHEET NUMBER ED1.1 ROUTE 3" CONDUITS TO EXISTING MDP AND RE-FEED PANEL.

3/4" CONDUIT WITH HEAT TRACE CONDUCTORS UP THROUGH CHASE. REFER TO SHEET E1.1 FOR CONTINUATION.

ROUTE NEW CONDUIT AND CONDUCTORS FROM NEW GONG LOCATION TO FIRE SPRINKLER ENTRANCE IN BASEMENT SPRINKLER ROOM. REFER TO SHEET E1.1 FOR GONG LOCATION.

DO NOT DRILL THROUGH EXISTING BEAM. CONTRACTOR SHALL PRE-MARK PENETRATION LOCATIONS FOR OWNER/DESIGN TEAM REVIEW PRIOR TO DRILLING. DRILL PILOT HOLES PRIOR TO CORE-DRILLING TO VERIFY LOCATION DOES NOT PENETRATE BEAM.

(6) CONTRACTOR SHALL ROUTE (1) 4" CONDUIT TO ALLIANT ENERGY TRANSFORMER APPROXIMATELY 80'-0" NORTH OF SERVICE LOCATION. ALLIANT ENERGY TO PROVIDE CONDUCTORS. CONDUIT SHALL NOT PENETRATE BASEMENT UTILITY ROOM. COORDINATE SCHEDULE WITH ALLIANT ENERGY.

CENTURYLINK. LINES SHALL PARALLEL HEAT TRACE

COORDINATE REROUTING OF NEW TELEPHONE LINES WITH CONDUIT/CONDUCTORS DOWN TO BASEMENT.


MITIGATION

DOC 1JD
MENT WATER INFILTRATION M
745 MAIN ST
DUBUQUE, IOWA 52001

Ξ

BASI

DPP

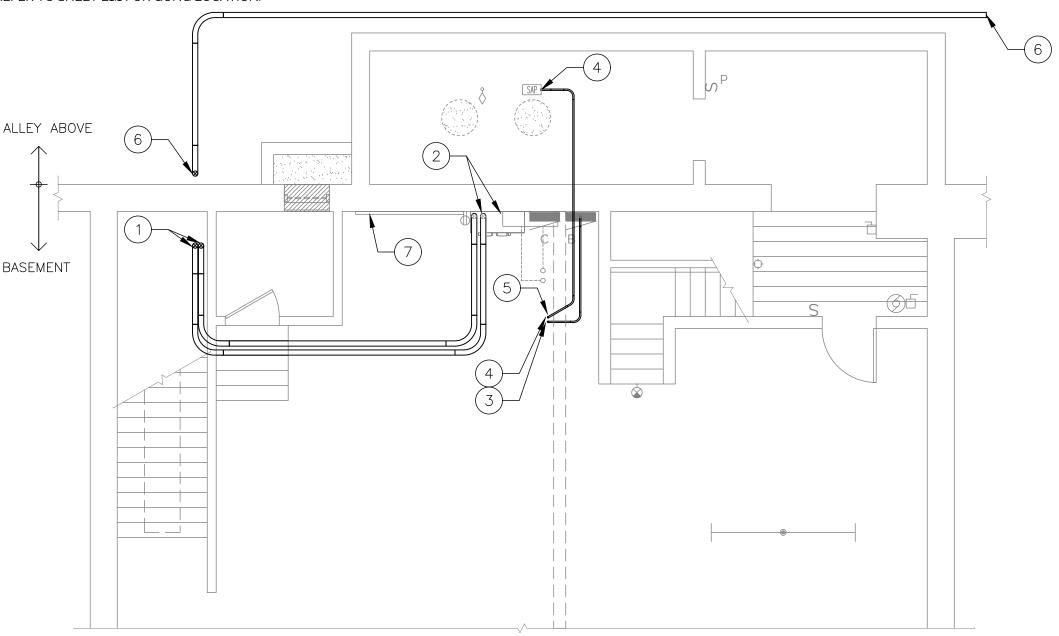



PARTIAL BASEMENT ELECTRICAL PLAN

PARTIAL BASEMENT ELECTRICAL PLAN 9390.00

PROJECT NO. 2406 ISSUE DATE


DAS NO.

03/05/25 SHEET NUMBER

E1.0

KEYED NOTES

- PROVIDE NEW 600A, 208/3 SERVICE DISCONNECT, ELECTRIC METER, AND C/T CABINET IN ALLEY. COORDINATE WITH ALLIANT ENERGY.
- ROUTE (2) PARALLEL SETS OF (4) #500 + (1) 2/0 GROUND COPPER CONDUCTORS EACH IN NEW 3" CONDUIT FROM NEW SERVICE DISCONNECT, ELECTRIC METER, AND C/T LOCATION IN ALLEY TO MDP. COORDINATE WITH ALLIANT ENERGY.
- REROUTE (2) 12-STRAND FIBER OPTIC CABLES THROUGH 1ST FLOOR CEILING TO DATA CLOSET. PROVIDE SLEEVE AT EACH OPEN END OF CONDUIT. COORDINATE EXACT ROUTING WITH OWNER PRIOR TO START OF WORK. COORDINATE ROUTING OF 3RD FIBER OPTIC CABLE WITH MEDIACOM. MINIMIZE SHUTDOWN(S) TO NIGHT/WEEKEND AS MUCH AS POSSIBLE.
- ROUTE NEW 3/4" CONDUIT FOR HEAT TRACE ABOVE CORRIDOR CEILING AND PENETRATE EXTERIOR WALL AS HIGH AS POSSIBLE. PROVIDE WEATHER-PROOF JUNCTION BOX ON SOUTH WALL OF 2ND STORY 2'-0" ABOVE LOWER ROOF. REFER TO SHEET A1.3 FOR FURTHER DETAILS.
- (5) REINSTALL SALVAGED FIRE ALARM GONG. ROUTE NEW CONDUIT AND CONDUCTORS THROUGH WALL WITH NEW HEAT TRACE CONDUIT AND RECONNECT TO FIRE SPRINKLER ENTRANCE IN BASEMENT SPRINKLER ROOM. SEE SHEET E1.0 FOR BASEMENT SPRINKLER ROOM LOCATION.
- COORDINATE REROUTING OF NEW TELEPHONE LINES WITH CENTURYLINK. LINES SHALL PARALLEL HEAT TRACE CONDUIT/CONDUCTORS DOWN TO BASEMENT.

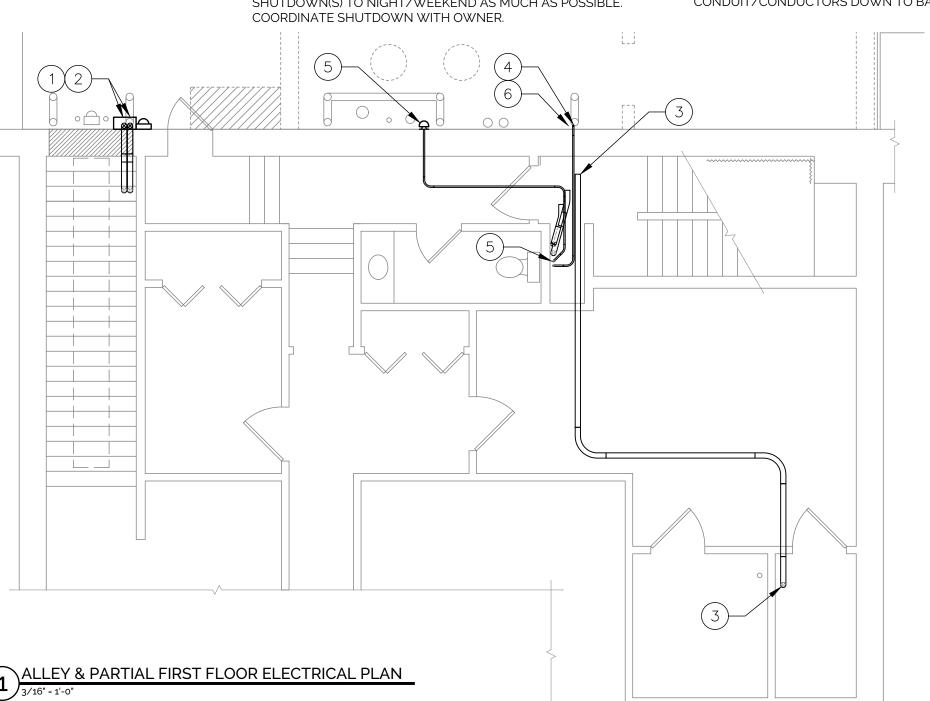

MITIGATION DOC 1JD
MENT WATER INFILTRATION M
745 MAIN ST
DUBUQUE, IOWA 52001

Σ BASI

Ь

ALLEY ELECTRICAL UTILITY PLAN

DAS NO.

9390.00

PROJECT NO. 2406 ISSUE DATE

03/05/25

SHEET NUMBER E1.1