

DCA MON MAIN HOUSE SITE WORK AND OUTBUILDING REPAIRS

26223 HARDING RD CLERMONT, IOWA

DAS PROJECT # 9226.00 GENESIS PROJECT # 2114.02

EARTH CONTINUOUS WOOD CONCRETE WOOD TREATED BLKG. BRICK GYPSUM BOARD/ PLASTER CONCRETE BLOCK BATT INSULATION PLYWOOD EXISTING MATERIAL

I hereby certify that the portion of this technical submission described below was prepared by me or under my supervisor and responsible charge. I am a duly registered Architect under the laws of the State of Iowa. Signature Edward L Matt Reg. No. Pages or Sheets covered in part or whole by this seal: A0, A0.1, A0.2, A0.3, A1.0, A1.1, A2.0, A2.1, A3.0, A4.0, A5.0 & A5.1 Date Issued: 3-22-22

CONTACT INFORMATION

OWNER

IOWA DEPT. OF ADMIN. SERVICES

JAMES TROWER, OWNER'S REP

STATE BUILDING & CONSTRUCTION RESOURCE
BUREAU, G.S.E.

109 SE 13TH STREET DES MOINES, IA 50319-0150 OFFICE: 515-725-4150

ON SITE CONTACT

IOWA DEPT. OF CULTURAL AFFAIRS
HANNAH FREDERICK, ON SITE CONTACT
P.O. BOX 372
CLERMONT, IA 52135
PHONE: 563–423–7173

CONSTRUCTION MANAGER

STORY CONSTRUCTION CO.
JEFFREY REAMS, PROJECT MANAGER
2810 WAKEFIELD CIRCLE
AMES, IA 50010
OFFICE: 515-232-4358

ARCHITECT

GENESIS ARCHITECTURAL DESIGN EDWARD MATT, AIA PROJECT ARCHITECT 939 OFFICE PARK ROAD, SUITE 101 WEST DES MOINES, IA 50265-2505 OFFICE: 515-440-1681

STRUCTURAL ENGINEER

PETERSON ENGINEERS
DONALD PETERSON, P.E.
1200 VALLEY WEST DRIVE, SUITE 505
WEST DES MOINES, IA 50266
OFFICE: 515-225-2821

CIVIL ENGINEER

FEHR GRAHAM
JON BIEDERMAN, P.E.
128 SOUTH VINE STREET
WEST UNION, IA 52175
OFFICE: 563-422-5131

SHEET INDEX

AO COVER SHEET

A0.1 PRESERVATION NOTES & ABBREVIATIONS

AO.2 LOCATION MAP AND OUTBUILDINGS

A0.3 AERIAL SITE MAP

A1.0 WORKSHOP PLANS

A1.1 WORKSHOP ELEVATIONS

A2.0 CARETAKERS HOUSE PLAN

2.1 CARETAKERS HOUSE ELEVATIONS

A3.0 LAUNDRY PLAN AND ELEVATIONS

A4.0 CHICKEN COOP PLAN AND ELEVATIONS

A5.0 PAVER PLAN - NORTH & SOUTH

A5.1 PAVER PLAN - RELOCATED

S1.0 WORKSHOP STRUCTURAL PLAN

C.01 LEGEND & CERTIFICATION

C.02 GEN. NOTES + SUPPLEMENTAL SPECIFICATIONS

.03 EXISTING CONDITIONS PLAN

C.04 BASE BID SITE PLAN

C.05 ALTERNATE BID SITE PLAN

C.06 SUDAS DETAILS

E1.0 ELECTRICAL PLAN

GENESIS TEL: 515-440-11

DCA MON MAIN HOUSE SITE WORK
AND OUTBUILDING REPAIRS
MONTAUK HISTORIC SITE
26223 HARDING RD, CLERMONT, IA 52135

COVER SHEET

DAS NO. 9226.00

PROJECT NO. 2114 ISSUE DATE

3/21/22 SHEET NUMBER

A0

ABBREVIATIONS

AD I	AD IIICTADI E	I/W	NEX MALL
ADJ	ADJUSTABLE _.	KW	KEY WALL
A/E	ARCHITECT / ENGINEER		
AMT	AMOUNT	MAS	MASONRY
APPROX	APPROXIMATELY	MTL	METAL
ARCH	ARCHITECT	MFR	MANUFACTURER
		MIN	MINIMUM
AVE	AVERAGE		
		MISC	MISCELLANEOUS
BD	BOARD	MO	MASONRY OPENING
BLDG	BUILDING		
BLK	BLOCK	NIC	NOT IN CONTRACT
BRK	BRICK	NO	NUMBER
		NOM	NOMINAL
BSMT	BASEMENT		
		NTS	NOT TO SCALE
CC	CENTER TO CENTER		
CJ	CONTROL JOINT	OC	ON CENTER
Ę.	CENTER LINE	OPNG	OPENING
		ORIG	ORIGINAL
CMU	CONCRETE MASONRY UNIT	0S	OUTSIDE
COL	COLUMN	03	OUTSIDE
CONC	CONCRETE		
CONT	CONTINUOUS	PR	PAIR
CONTR	CONTRACTOR	PROT	PROTECTION
		PT	PAINT
CRS	COURSES	• • • • • • • • • • • • • • • • • • • •	1 7 MIXI
CTR	CENTER	D	DEMONE AND DEDILAGE
		R&R	REMOVE AND REPLACE
D	DEPTH	RAD	RADIUS
DEMO	DEMOLITION	RCJ	REINFORCED CONTROL JOINT
DTL	DETAIL	RCMU	REINFORCED CONC. MASONRY JT.
		REBAR	REINFORCING BAR
DIA	DIAMETER		
DIM	DIMENSION	REINF	REINFORCED
DN	DOWN	REJ	ROOF EXPANSION JOINT
DO	REPEAT	REQ'D	REQUIRED
DWG	DRAWING	RQMT	REQUIREMENT
D#10	DIVANINO	110(1111	THE GOTTEMENT
_,	FAOLL	SECT	SECTION
EA	EACH		
EJ	EXPANSION JOINT	SF.	SQUARE FOOT OR FEET
EJF	EXPANSION JOINT FILLER	SHT	SHEET
ELEV	ELEVATION	SIM	SIMILAR
ENGR	ENGINEER	SPEC	SPECIFICATION
EQ	EQUAL	SQ	SQUARE
		STD	STANDARD
EX/EXST	EXISTING		
EXT	EXTERIOR	STL	STEEL
FND	FOUNDATION	T&B	TOP AND BOTTOM
FIN	FINISH	TOW	TOP OF WALL
		T.P.	TUCK POINT
FLR	FLOOR	TWF	
FT	FOOT OR FEET		THROUGH WALL FLASHING
		TYP	TYPICAL
GA	GAUGE		
GALV	GALVANIZED	UNO	UNLESS NOTED OTHERWISE
GND			
עווט ן	GROUND	VERT	VERTICAL
l		V LI\I	Y LINITONL
Н	HIGH	144	WIDTH
HGT	HEIGHT	W	WIDTH
HORIZ	HORIZONTAL	W/	WITH
		w/o	WITHOUT
1,4,4,	IN ACCODDANCE WITH		
IAW	IN ACCORDANCE WITH	WCJ	WALL CONTROL JOINT
INCL	INCLUDED	WD	WOOD
INT	INTERIOR	WEJ	WALL EXPANSION JOINT
IS	INSIDE	WGT	WEIGHT
		•	
JT	JOINT		
V1	VOIITI		

PRESERVATION NOTES:

- A. MONTAUK IS A HISTORIC SITE THAT IS OWNED AND MAINTAINED BY THE STATE OF IOWA. IT WAS LISTED ON THE NATIONAL REGISTER OF HISTORIC PLACES IN 1973. THE MANSION AND OUTBUILDINGS ON THIS SITE ALL CONTRIBUTE TO THE SITE'S HISTORIC SIGNIFICANCE, AND THEREFORE ALL WORK MUST BE PERFORMED IN KEEPING WITH THE SECRETARY OF INTERIOR'S STANDARDS FOR HISTORIC PRESERVATION.
- B. PRESERVATION: TO APPLY MEASURES NECESSARY TO SUSTAIN THE EXISTING FORM, INTEGRITY, AND MATERIALS OF A HISTORIC PROPERTY. THE GOAL OF PRESERVATION IS TO HALT THE PROCESS OF DETERIORATION AND STABILIZE THE ITEM'S CONDITION.
- C. REHABILITATION: TO MAKE POSSIBLE A COMPATIBLE USE FOR A PROPERTY THROUGH REPAIR, ALTERATIONS, AND ADDITIONS WHILE PRESERVING THOSE PORTIONS OR FEATURES THAT CONVEY ITS HISTORICAL, CULTURAL, OR ARCHITECTURAL VALUES.
- D. PROTECT AND MAINTAIN: TO REMOVE DETERIORATING MATERIALS, APPLY PROTECTIVE PRODUCTS, AND INSTALL PROTECTIVE MEASURES TO PROVIDE THE LEAST DEGREE OF INTERVENTION.
- E. MATERIAL IN KIND: MATERIAL THAT MATCHES EXISTING MATERIALS, AS MUCH AS POSSIBLE. IN SPECIES. CUT. COLOR. GRAIN. TEXTURE. AND FINISH.
- E. REPAIR: TO STABILIZE, CONSOLIDATE, OR CONSERVE; TO RETAIN EXISTING MATERIALS AND FEATURES WHILE EMPLOYING AS LITTLE NEW MATERIAL AS POSSIBLE. REPAIR INCLUDES PATCHING, PIECING-IN, SPLICING, CONSOLIDATING, OR OTHERWISE REINFORCING OR UPGRADING MATERIALS. WITHIN RESTORATION, REPAIR ALSO INCLUDES LIMITED REPLACEMENT IN KIND, REHABILITATION, AND RECONSTRUCTION, WITH COMPATIBLE SUBSTITUTE MATERIALS FOR DETERIORATED OR MISSING PARTS OF FEATURES WHEN THERE ARE SURVIVING PROTOTYPES.
- REPLACE: TO DUPLICATE AND REPLACE ENTIRE FEATURES WITH NEW MATERIAL IN KIND. REPLACEMENT INCLUDES THE FOLLOWING CONDITIONS:
 - DUPLICATION: INCLUDES REPLACING ELEMENTS DAMAGED BEYOND REPAIR OR MISSING. ORIGINAL MATERIAL IS INDICATED AS THE PATTERN FOR CREATING NEW DUPLICATED ELEMENTS.
 - 2. REPLACEMENT WITH NEW MATERIALS: INCLUDES REPLACEMENT WITH NEW MATERIAL WHEN ORIGINAL MATERIAL IS NOT AVAILABLE AS PATTERNS FOR CREATING NEW DUPLICATED ELEMENTS.
 - 3. REPLACEMENT WITH SUBSTITUTE MATERIALS: INCLUDES REPLACEMENT WITH COMPATIBLE SUBSTITUTE MATERIALS. SUBSTITUTE MATERIALS ARE NOT ALLOWED, UNLESS OTHERWISE INDICATED.
- H. RESTORE: TO CONSOLIDATE, REPLICATE, REPRODUCE, REPAIR, AND REFINISH AS REQUIRED TO ACHIEVE THE INDICATED RESULTS.
- I. WHERE REPAIR WORK IS REQUIRED OR SPECIFICALLY INDICATED, THE FOLLOWING PROCEDURES SHALL BE FOLLOWED:
 - RETAIN AS MUCH EXISTING MATERIAL AS POSSIBLE; REPAIR AND CONSOLIDATE RATHER THAN REPLACE.
 - 2. USE ADDITIONAL MATERIAL OR STRUCTURE TO REINFORCE, STRENGTHEN, PROP, TIE, AND SUPPORT EXISTING MATERIAL OR STRUCTURE.
 - USE REVERSIBLE PROCESSES WHEREVER POSSIBLE.
 - USE TRADITIONAL REPLACEMENT MATERIALS AND TECHNIQUES. NEW WORK SHALL BE DISTINGUISHABLE TO THE TRAINED EYE, ON CLOSE INSPECTION, FROM OLD WORK.
 - RECORD THE WORK BEFORE THE PROCEDURE WITH PRECONSTRUCTION PHOTOGRAPHS AND DURING THE WORK WITH PERIODIC CONSTRUCTION PHOTOS.
- J. WHERE WORK REQUIRES EXISTING FEATURES TO BE REMOVED, CLEANED, AND REUSED, PERFORM THESE OPERATIONS WITHOUT DAMAGE TO THE MATERIAL ITSELF, TO ADJACENT MATERIALS. OR TO THE SUBSTRATE.
- K. REFER TO THE SPECIFICATIONS MANUAL FOR SECTIONS ON SPECIFIC HISTORIC TREATMENT PROCEDURES.

OFFICE PARK RD., #101 ST DES MOINES, IA 50265 :: 515-440-1681



DCA MON MAIN HOUSE SITE WORK
AND OUTBUILDING REPAIRS
MONTAUK HISTORIC SITE
26223 HARDING RD, CLERMONT, IA 52135

PRESERVATION NOTES AND

9226.00

PROJECT NO. 2114

3/21/22

AO.1


GENERAL NOTES:


- A. CONTRACTOR TO FIELD VERIFY ALL BUILDING AND SITE CONDITIONS. REPORT ANY DISCREPANCIES TO ARCHITECT PRIOR TO PROCEEDING WITH ANY WORK. CONTRACTOR IS RESPONSIBLE TO FIELD VERIFY ALL DIMENSIONS AND QUANTITIES.
- CONTRACTOR TO COORDINATE ALL WORK WITH OTHER TRADES AND COORDINATE SCHEDULE WITH OWNER, DAS AND CONSTRUCTION MANAGER.
- C. PRIOR TO DEMOLITION, CONTRACTOR SHALL NOTIFY THE FOLLOWING: OWNER AND CONSTRUCTION MANAGER.
- D. ALL CONSTRUCTION/DEMOLITION DEBRIS SHALL BE DISPOSED OF OFFSITE IN FULL COMPLIANCE WITH CURRENT ENVIRONMENTAL REGULATIONS.
- E. ALL PERMITS AND ADDITIONAL FEES
 REQUIRED TO COMPLETE THE WORK SHALL
 BE INCLUDED IN THE CONTRACTOR BID.

PLAN OF OUTBUILDINGS

SCALE: 3/32" = 1'-0"



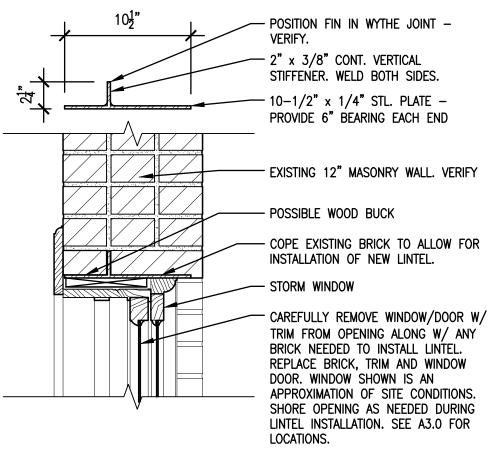

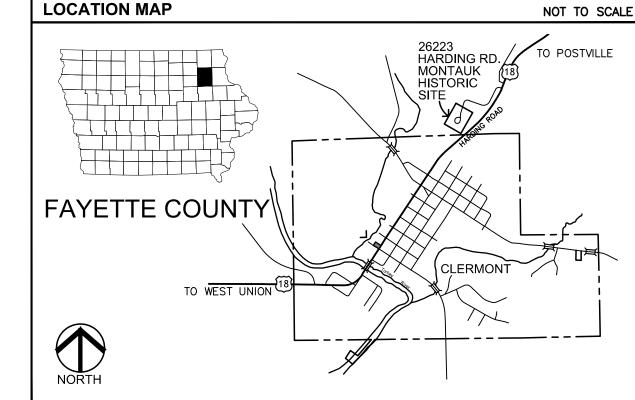

DCA MON MAIN HOUSE SITE WORK
AND OUTBUILDING REPAIRS
MONTAUK HISTORIC SITE
26223 HARDING RD, CLERMONT, IA 52135

LOCATION MAP AND OUTBUILDINGS

DAS NO. 9226.00

PROJECT NO. 2114 ISSUE DATE


3/21/22 SHEET NUMBER

A0.2

STEEL LINTEL DETAIL

SCALE: $1 \frac{1}{2}$ " = 1'-0"

 $\frac{1}{A0.2}$

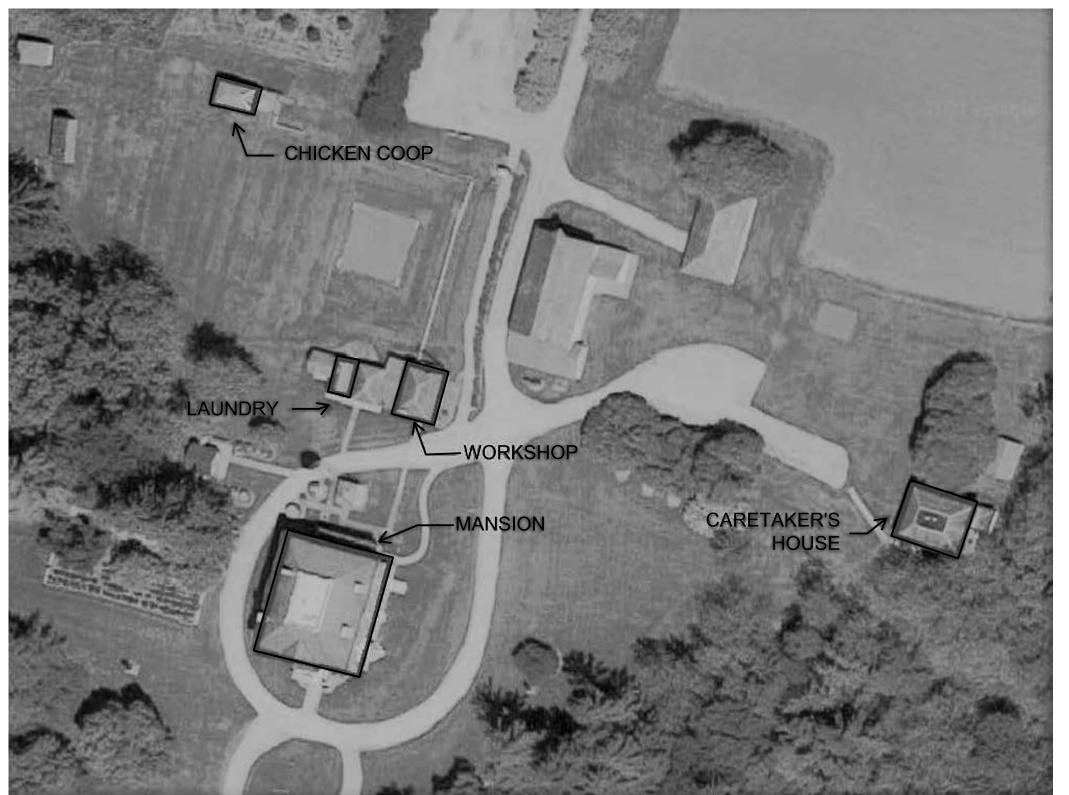

AERIAL SITE MAP

NO SCALE

GENERAL NOTES:

- A. CONTRACTOR TO FIELD VERIFY ALL BUILDING AND SITE CONDITIONS. REPORT ANY DISCREPANCIES TO ARCHITECT PRIOR TO PROCEEDING WITH ANY WORK. CONTRACTOR IS RESPONSIBLE TO FIELD VERIFY ALL DIMENSIONS AND QUANTITIES.
- 3. CONTRACTOR TO COORDINATE ALL WORK WITH OTHER TRADES AND COORDINATE SCHEDULE WITH OWNER, DAS AND CONSTRUCTION MANAGER.
- C. PRIOR TO DEMOLITION, CONTRACTOR SHALL NOTIFY THE FOLLOWING: OWNER AND CONSTRUCTION MANAGER.
- D. ALL CONSTRUCTION/DEMOLITION DEBRIS SHALL BE DISPOSED OF OFFSITE IN FULL COMPLIANCE WITH CURRENT ENVIRONMENTAL REGULATIONS.
- E. ALL PERMITS AND ADDITIONAL FEES REQUIRED TO COMPLETE THE WORK SHALL BE INCLUDED IN THE CONTRACTOR BID.
- F. PROTECT ADJACENT BUILDING ELEMENTS, I.E. ROOFS, FLASHINGS, WINDOWS AND DOORS FROM DAMAGE
- PROTECT LAWN AND LANDSCAPING. REPAIR
 DAMAGED LAWN AREAS. GRADE ANY RUTS SMOOTH,
 RESEED AND WATER TO RE-ESTABLISH LAWN.

OFFICE PARK RD., #101 ST DES MOINES, IA 50264 : 515-440-1681



DCA MON MAIN HOUSE SITE WORK
AND OUTBUILDING REPAIRS
MONTAUK HISTORIC SITE
26223 HARDING RD, CLERMONT, IA 52135

AERIAL

DAS NO. 9226.00

PROJECT NO. 2114

3/21/22

A0.3

18" x 6'-0"CONCRETE GUTTER TROUGH W/ CURVED BOTTOM SEE DETAIL1/A5.0 17'-0" **DEHUMIDIFICATION RELOCATED** 3 A1.1 -PIPE -D.S. (2) (A1.1) 4 A1.1 6 24'-4" | HINGED DOOR IN FLOOR FOR BSMT ACCESS. - RELOCATE D.S. TO 1 A1.1 NORTH CORNER. RE-HANG GUTTERS & SEAL HOLES IN WOOD SHINGLES.

FLOOR PLAN NOTES:

- RIP EDGES OF ¾" T & G FLOOR BOARDS TO LAY FLAT WHERE BUCKLED UP. RE-NAIL TO FLOOR JOISTS.
- 2. PROVIDE 16"W X 12"D x 12" H WOOD BOX ENCLOSURE IN CORNER TO COVER BSMT DRAIN PIPES. FINISH BOX ENCLOSURE WITH WHITE WASH.
- 3. GFCI OUTLETS +18". SEE ELECTRICAL SHT. E1.0. DRILL (2) 1 ½" DIA. HOLES IN FLOOR FOR CORDS FROM BASEMENT.
- 4. EXTEND PVC DEHUMIDIFIER AND SUMP PIPES THROUGH BRICK WALL AT CORNER. ELBOW PIPES TO DISCHARGE INTO CONCRETE GRADE TROUGH. PRIME AND PAINT PVC PIPES TERRA COTTA COLOR TO MATCH BRICK.
- 5.) REMOVE AND REPLACE EXISTING BASEMENT STEEL POSTS WITH GALVANIZED PIPE COLUMNS. SEE STRUCTURAL.
- 6.) SEE BID ALTERNATE #1 FOR COMPLETE SUBFLOOR REPLACEMENT.

NORTH

YLAN NOTES:

OFFICE PARK RD., # ST DES MOINES, IA (



DCA MON MAIN HOUSE SITE WORK
AND OUTBUILDING REPAIRS
MONTAUK HISTORIC SITE
26223 HARDING RD, CLERMONT, IA 52135

WORKSHOP PLANS

DAS NO. 9226.00

PROJECT NO. 2114


3/21/22


SHEET NUMBER
A1.0

WORKSHOP FLOOR PLAN

SCALE:3/16" = 1'-0"


WORKSHOP BASEMENT PLAN
SCALE:3/16" = 1'-0"

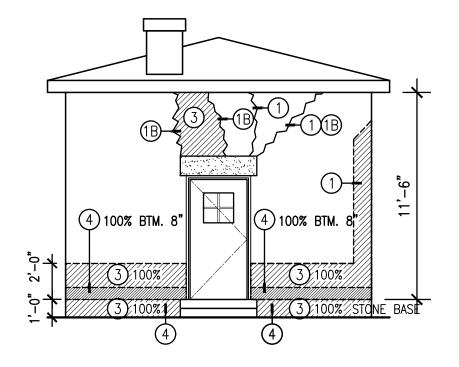


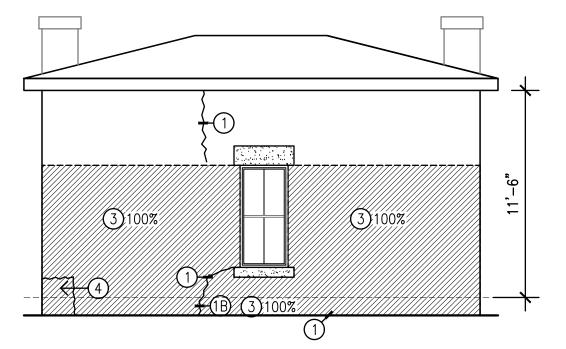

WORKSHOP ELEVATION - SOUTH SCALE:3/16" = 1'-0"

WORKSHOP ELEVATION - EAST SCALE:3/16" = 1'-0"

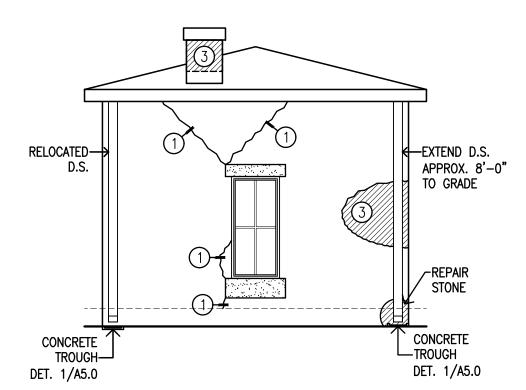

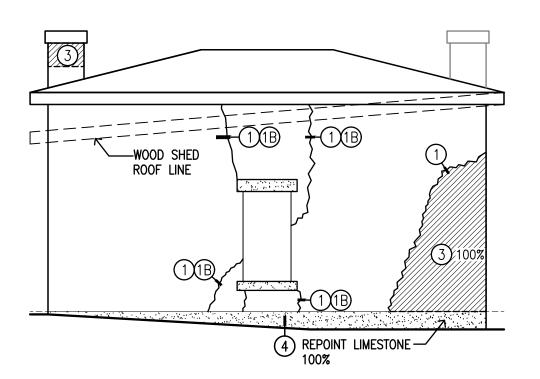

WORKSHOP ELEVATION - NORTH SCALE:3/16" = 1'-0"

WORKSHOP ELEVATION - WEST

SCALE:3/16" = 1'-0"

MASONRY REPAIR SCOPE NOTES:

- (1) MASONRY CRACK. REPLACE BRICK THAT ARE CRACKED THROUGH SEE #2. FULL DEPTH CRACKS IN MORTAR ARE TO BE REPOINTED FULL DEPTH OF BRICK. INSTALL BED JOINT MORTAR PRIOR TO POINTING. REMOVE ANY SEALANT THAT IS IN ANY CRACKS.
- ② REPLACE BRICK. CUT OUT AND REPLACE DAMAGED BRICK WITH MATCHING BRICK. INSTALL BED JOINT MORTAR PRIOR TO POINTING.
- 3 REPOINT AREA OF BRICK. REPOINT MASONRY PER THE PERCENTAGE OF JOINTS INDICATED IN AREA INDICATED BY HATCH. 100% UNLESS NOTED OTHERWISE.
- DEEP BED JOINT REPAIR AREA.
 PERFORM DEEP BED JOINT
 REPAIRS PER THE AREA INDICATED
 BY HATCH. ADD AN ADDITIONAL10%
 OVER AREAS INDICATED.
- (5) REPAIR DAMAGED OR SPALLED STONE WITH STONE PATCHING COMPOUND. BUILD OUT PER MANUFACTURER'S RECOMMENDATIONS. MATCH EXISTING STONE TEXTURE AND PROFILE.
- 6 FOUNDATION CRACK. ROUT OUT CRACK AND REPAIR WITH CONCRETE PATCHING COMPOUND. DEEP CRACKS TO HAVE INJECTION REPAIR GROUT W/ 1" CONCR. PATCHING COMPOUND ON EXTERIOR.
- GROUT PATCH HOLE WITH GROUT COLORED TO MATCH MASONRY.
- 8) CLEAN MASONRY AT WORK AREAS.
- REMOVE ALL UNUSED ANCHORS. PATCH ALL HOLES IN MASONRY; SEE ITEM #7.

BUILDING SPECIFIC NOTES:

- A. WALLS ARE SOLID BRICK.
 FOUNDATION AND OPENING HEAD
 & SILLS ARE LIMESTONE.
- B. CRACKS NOTED AS 1B ARE CRACKS ON THE INSIDE OF BLDG. TO BE REPOINTED. TOUCH UP CRACKS INSIDE WITH WHITE WASH.

GENESIS FEL: 516

DCA MON MAIN HOUSE SITE WORK
AND OUTBUILDING REPAIRS
MONTAUK HISTORIC SITE
26223 HARDING RD, CLERMONT, IA 52135


WORKSHOP ELEVATIONS

das no. 9226.00

PROJECT NO. 2114 ISSUE DATE 3/21/22

SHEET NUMBER


A1.1

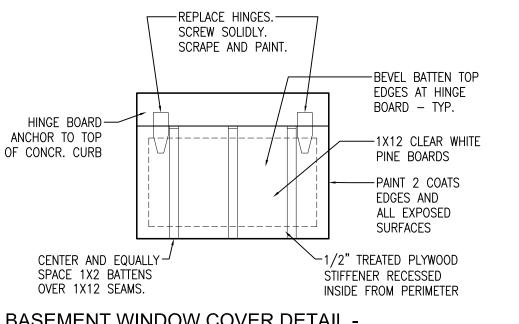

BASEMENT WINDOW COVER DETAIL -SEE BID ALTERNATE #2



NORTH

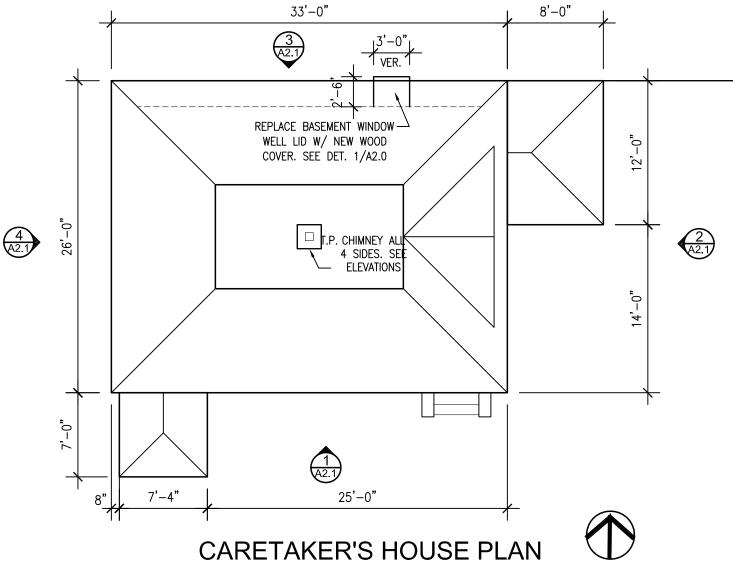

SCALE:1/8" = 1'-0"

GENERAL NOTES:

- CONTRACTOR TO FIELD VERIFY ALL BUILDING AND SITE CONDITIONS. REPORT ANY DISCREPANCIES TO ARCHITECT PRIOR TO PROCEEDING WITH ANY WORK. CONTRACTOR IS RESPONSIBLE TO FIELD VERIFY ALL DIMENSIONS AND QUANTITIES.
- CONTRACTOR TO COORDINATE ALL WORK WITH OTHER TRADES AND COORDINATE SCHEDULE WITH OWNER, DAS AND CONSTRUCTION MANAGER.
- PRIOR TO DEMOLITION, CONTRACTOR SHALL NOTIFY THE FOLLOWING: OWNER AND CONSTRUCTION MANAGER.
- D. ALL CONSTRUCTION/DEMOLITION DEBRIS SHALL BE DISPOSED OF OFFSITE IN FULL COMPLIANCE WITH CURRENT ENVIRONMENTAL REGULATIONS.
- ALL PERMITS AND ADDITIONAL FEES REQUIRED TO COMPLETE THE WORK SHALL BE INCLUDED IN THE CONTRACTOR BID.

BUILDING SPECIFIC NOTES:

- A. WALLS ARE SOLID BRICK WITH LIMESTONE HEAD & SILLS.
- FOUNDATION IS ROUGH CUT LIMESTONE.
- C. STIPPLE INDICATES LIMESTONE.

939 OFFICE PARK RD., #101 WEST DES MOINES, IA 50265 TEL: 515-440-1681 FAX: 515-440-1687



DCA MON MAIN HOUSE SITE WORK AND OUTBUILDING REPAIRS MONTAUK HISTORIC SITE 26223 HARDING RD, CLERMONT, IA 52135

CARETAKER'S HOUSE PLAN


DAS NO. 9226.00

PROJECT NO. 2114

SHEET NUMBER

A2.0

ISSUE DATE 3/21/22

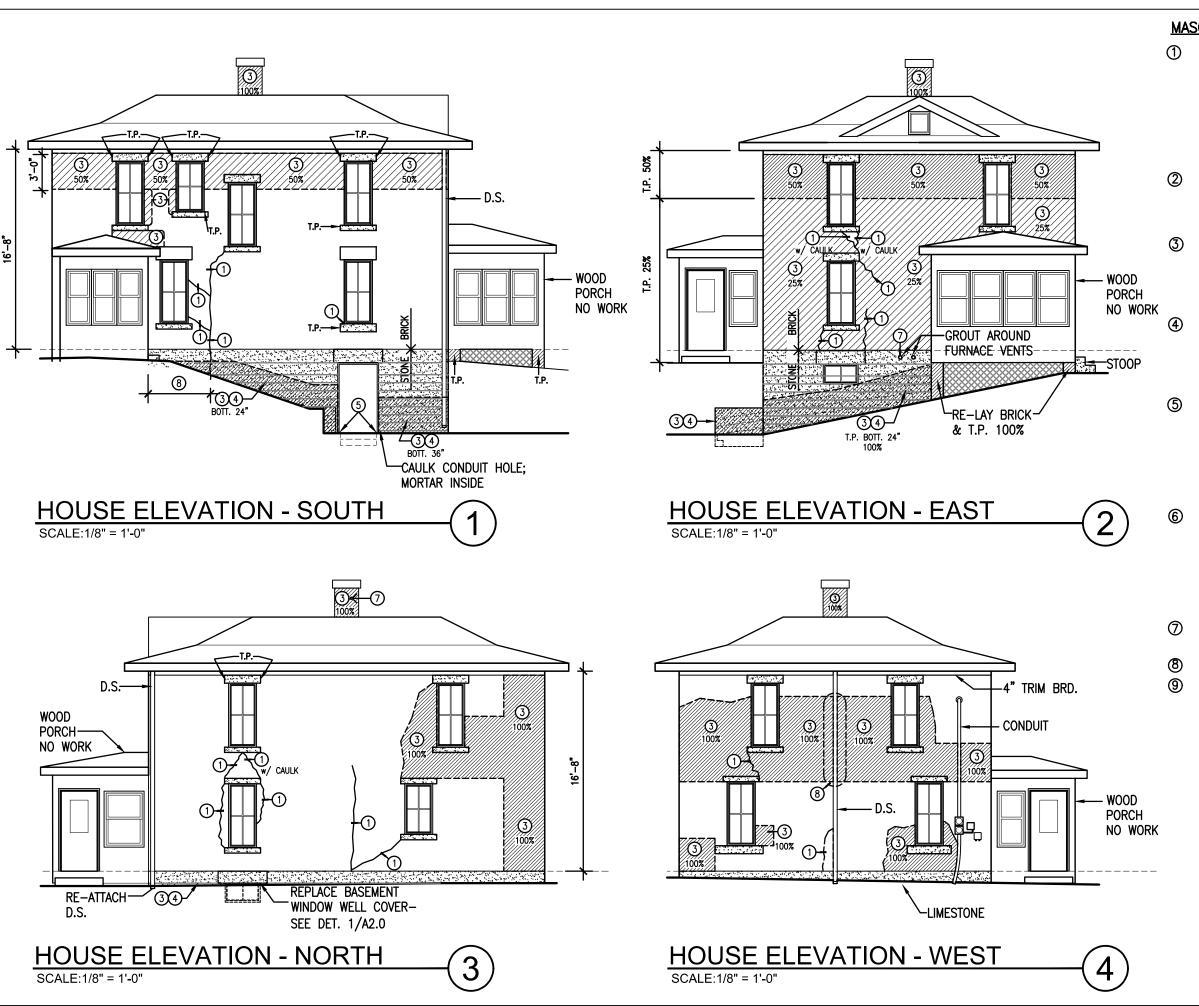

MASONRY REPAIR SCOPE NOTES:

- MASONRY CRACK. REPLACE BRICK THAT ARE CRACKED THROUGH SEE #2. FULL DEPTH CRACKS IN MORTAR ARE TO BE REPOINTED FULL DEPTH OF BRICK. INSTALL BED JOINT MORTAR PRIOR TO POINTING. REMOVE ANY SEALANT THAT IS IN ANY CRACKS.
- PEPLACE BRICK. CUT OUT AND REPLACE DAMAGED BRICK WITH MATCHING BRICK. INSTALL BED JOINT MORTAR PRIOR TO POINTING.
- REPOINT AREA OF BRICK.
 REPOINT MASONRY PER THE
 PERCENTAGE OF JOINTS INDICATED
 IN AREA INDICATED BY HATCH.
 100% UNLESS NOTED OTHERWISE.
- DEEP BED JOINT REPAIR AREA.
 PERFORM DEEP BED JOINT
 REPAIRS PER THE AREA INDICATED
 BY HATCH. ADD AN ADDITIONAL10%
 OVER AREAS INDICATED.
- REPAIR DAMAGED OR SPALLED STONE WITH STONE PATCHING COMPOUND. BUILD OUT PER MANUFACTURER'S RECOMMENDATIONS. MATCH EXISTING STONE TEXTURE AND PROFILE.
- FOUNDATION CRACK. ROUT OUT CRACK AND REPAIR WITH CONCRETE PATCHING COMPOUND. DEEP CRACKS TO HAVE INJECTION REPAIR GROUT W/ 1" CONCR. PATCHING COMPOUND ON EXTERIOR.
- GROUT PATCH HOLE WITH GROUT COLORED TO MATCH MASONRY.
- 8 CLEAN MASONRY AT WORK AREAS.

939 OFFICE PARK RD., #101 WEST DES MOINES, IA 50265 TEL: 515-440-1681 FAX: 515-440-1687



DCA MON MAIN HOUSE SITE WORK
AND OUTBUILDING REPAIRS
MONTAUK HISTORIC SITE
26223 HARDING RD, CLERMONT, IA 52135


CARETAKER'S HOUSE ELEVATIONS

das no. 9226.00

PROJECT NO. 2114

3/21/22 SHEET NUMBER

A2.1

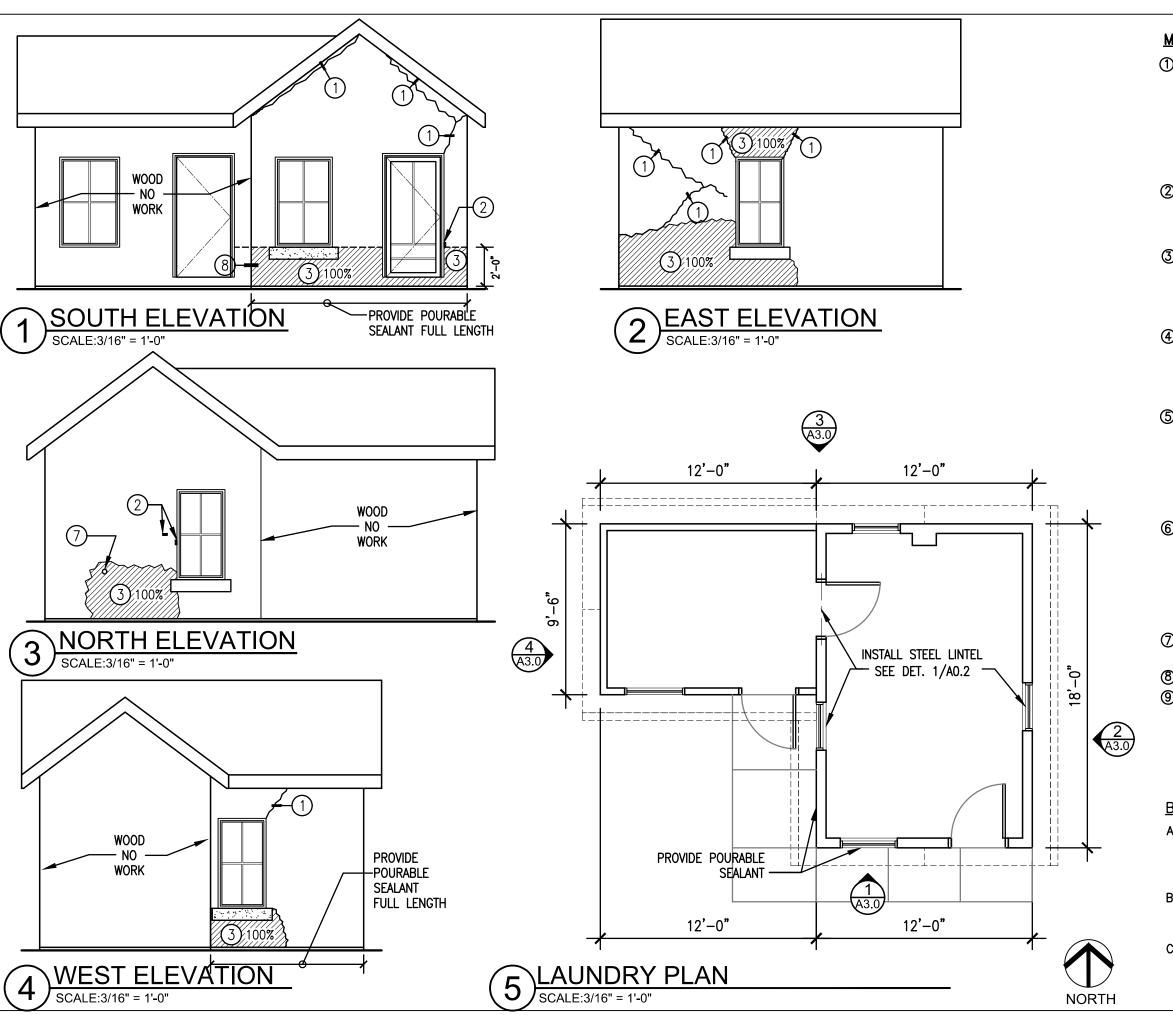

MASONRY REPAIR SCOPE NOTES:

- MASONRY CRACK. REPLACE BRICK THAT ARE CRACKED THROUGH – SEE #2. FULL DEPTH CRACKS IN MORTAR ARE TO BE REPOINTED FULL DEPTH OF BRICK. INSTALL BED JOINT MORTAR PRIOR TO POINTING. REMOVE ANY SEALANT THAT IS IN ANY CRACKS.
- PREPLACE BRICK. CUT OUT AND REPLACE DAMAGED BRICK WITH MATCHING BRICK. INSTALL BED JOINT MORTAR PRIOR TO POINTING.
- 3 REPOINT AREA OF BRICK.
 REPOINT MASONRY PER THE
 PERCENTAGE OF JOINTS INDICATED
 IN AREA INDICATED BY HATCH.
 100% UNLESS NOTED OTHERWISE.
- 4) DEEP BED JOINT REPAIR AREA.
 PERFORM DEEP BED JOINT
 REPAIRS PER THE AREA INDICATED
 BY HATCH. ADD AN ADDITIONAL10%
 OVER AREAS INDICATED.
- STONE WITH STONE PATCHING COMPOUND. BUILD OUT PER MANUFACTURER'S RECOMMENDATIONS. MATCH EXISTING STONE TEXTURE AND PROFILE.
- FOUNDATION CRACK. ROUT OUT CRACK AND REPAIR WITH CONCRETE PATCHING COMPOUND. DEEP CRACKS TO HAVE INJECTION REPAIR GROUT W/ 1" CONCR. PATCHING COMPOUND ON EXTERIOR.
- GROUT PATCH HOLE WITH GROUT COLORED TO MATCH MASONRY.
- B) CLEAN MASONRY AT WORK AREAS.
- PATCH ALL HOLES IN MASONRY; SEE ITEM #7.

BUILDING SPECIFIC NOTES:

- A. ALL CRACKS TO THRU WALLS TO THE INSIDE. TUCKPOINT CRACKS INSIDE. COORDINATE ALL WORK IN ADVANCE WITH OWNER
- B. TUCKPOINT BOTTOM 16" OF WALL INSIDE ON NORTH AND EAST WALLS.
- C. WHITE WASH ALL AREAS OF WORK INSIDE BUILDING.

GENESIS TEL: 515-44

DCA MON MAIN HOUSE SITE WORK
AND OUTBUILDING REPAIRS
MONTAUK HISTORIC SITE
26223 HARDING RD, CLERMONT, IA 52135


LAUNDRY

DAS NO. 9226.00

PROJECT NO. 2114

3/21/22 SHEET NUMBER

A3.0

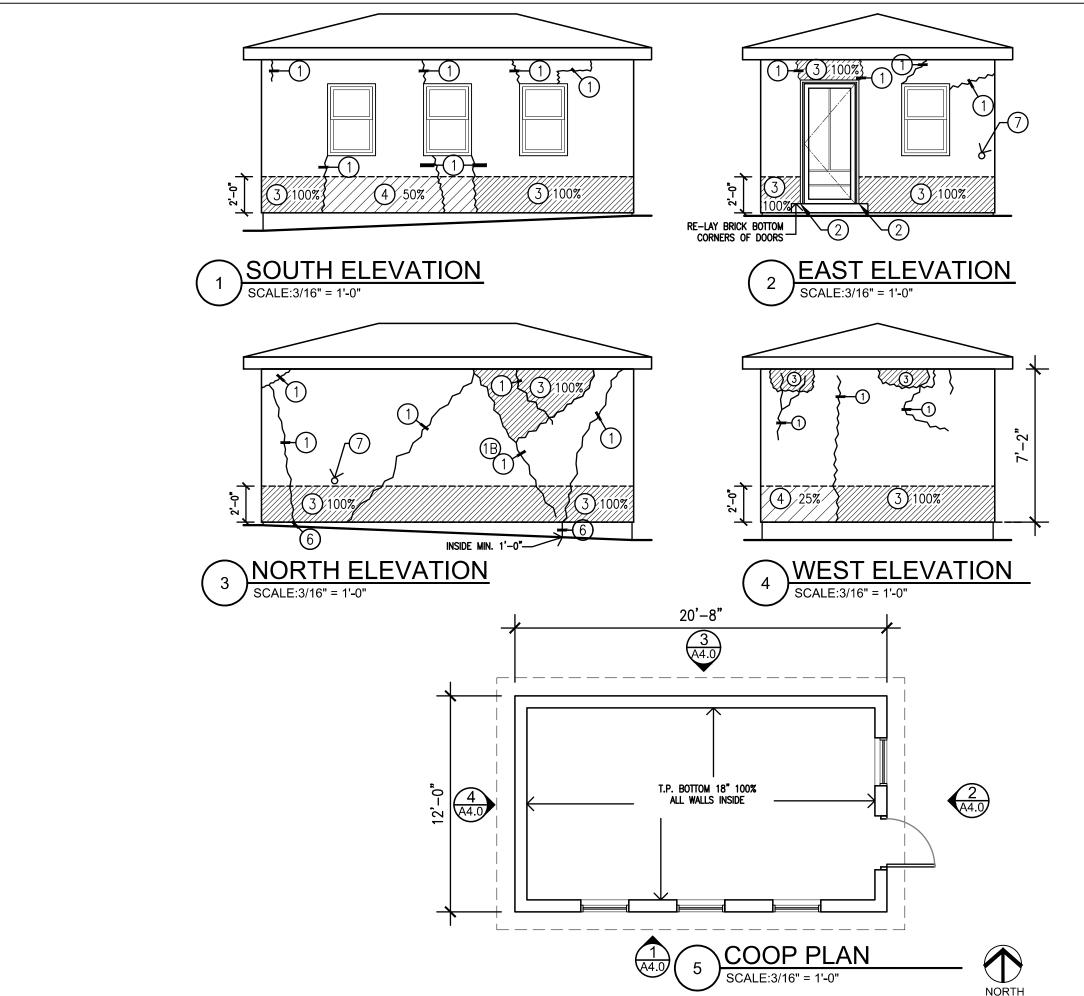

MASONRY REPAIR SCOPE NOTES:

-) MASONRY CRACK. REPLACE BRICK THAT ARE CRACKED THROUGH SEE #2. FULL DEPTH CRACKS IN MORTAR ARE TO BE REPOINTED FULL DEPTH OF BRICK. INSTALL BED JOINT MORTAR PRIOR TO POINTING. REMOVE ANY SEALANT THAT IS IN ANY CRACKS.
- REPLACE BRICK. CUT OUT AND REPLACE DAMAGED BRICK WITH MATCHING BRICK. INSTALL BED JOINT MORTAR PRIOR TO POINTING.
- REPOINT AREA OF BRICK.
 REPOINT MASONRY PER THE
 PERCENTAGE OF JOINTS INDICATED
 IN AREA INDICATED BY HATCH.
 100% UNLESS NOTED OTHERWISE.
- DEEP BED JOINT REPAIR AREA.
 PERFORM DEEP BED JOINT
 REPAIRS PER THE AREA INDICATED
 BY HATCH. ADD AN ADDITIONAL10%
 OVER AREAS INDICATED.
- STONE WITH STONE PATCHING COMPOUND. BUILD OUT PER MANUFACTURER'S RECOMMENDATIONS. MATCH EXISTING STONE TEXTURE AND PROFILE.
- FOUNDATION CRACK. ROUT OUT CRACK AND REPAIR WITH CONCRETE PATCHING COMPOUND. DEEP CRACKS TO HAVE INJECTION REPAIR GROUT W/ 1" CONCR. PATCHING COMPOUND ON EXTERIOR.
- GROUT PATCH HOLE WITH GROUT COLORED TO MATCH MASONRY.
- (8) CLEAN MASONRY AT WORK AREAS.
- PATCH ALL UNUSED ANCHORS. PATCH ALL HOLES IN MASONRY; SEE ITEM #7.

BUILDING SPECIFIC NOTES:

- A. WALLS ARE STRUCTURAL CLAY TILE WITH BRICK CORNERS.
- B. ALL CRACKS GO THRU TO INSIDE. TUCKPOINT INSIDE AND OUTSIDE.
- C. PACK MORTAR INTO TILE AT ALL OPEN JOINTS AND AREAS CALLED FOR DEEP JOINT REPAIRS.
- DRILL 1/2" DIA. HOLES (1, EACH)
 INTO CLAY COURSE OVER EACH
 WINDOW AND THE DOOR. DRILL
 FROM INSIDE. INJECT MORTAR
 GROUT INTO TILES TO CREATE
 AND BOND BEAM LINTEL.
- WHITE WASH ALL AREAS OF WORK INSIDE BUILDING.

939 OFFICE PARK RD., #'
WEST DES MOINES, IA 5(
TEL: 515-440-1681
FAX: 515-440-1687



DCA MON MAIN HOUSE SITE WORK AND OUTBUILDING REPAIRS MONTAUK HISTORIC SITE 26223 HARDING RD, CLERMONT, IA 52135

> CHICKEN COOP PLAN & ELEVATIONS

DAS NO. 9226.00

PROJECT NO. 2114

3/21/22 SHEET NUMBER

A4.0

A5.0

CONCRETE GUTTER TROUGH


SCALE: $1 \frac{1}{2} = 1'-0"$

NOTE: SEE SHEET A1.0 FOR LOCATIONS ON NORTH SIDE OF WORKSHOP.

INSTALL AFTER CIVIL GRADING WORK SHOWN ON SHT. CO.5 IS COMPLETED.

- G. PATCH ENDS OF PAVERS ALONG ROAD WITH 3/8" CRUSHED LIMESTONE GRAVEL.
- REPAIR AND REGRADE LAWN AREA AROUND ALL PAVER WORK. SEED AND WATER TO RE-ESTABLISH


- A. FIELD VERIFY ALL STONE PAVER DIMENSIONS.
- CAREFULLY EXCAVATE TO REMOVE EXISTING PAVERS. DO NOT OVER EXCAVATE. MINIMIZE SOIL DISTURBANCE IN WORK AREA.
- NEW PAVERS ARE TO BE 4 INCHES THICK.
- CAREFULLY EXCAVATE AND REMOVE PAVERS IDENTIFIED TO BE SALVAGED AND RELOCATED. HANDLE WITH CARE TO AVOID DAMAGE. COORDINATE WITH OWNER AND CM FOR TEMPORARY STORAGE OF PAVERS BEFORE RELOCATING.
- SET PAVER UNITS IN FLAT AND CONTINUOUS RUNS. FILL GAPS UNDER PAVERS WITH BED OF SAND FOR SOLID BED BEARING.
- F. PROVIDE 3/8" WIDE JOINTS BETWEEN UNITS AND FILL WITH POLYMERIC JOINT SAND.

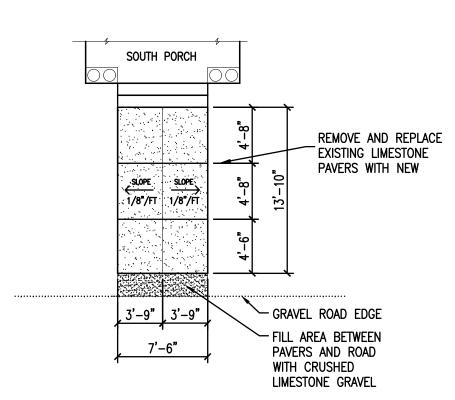

SOUTH PAVERS

SCALE: 1/8" = 1'-0"



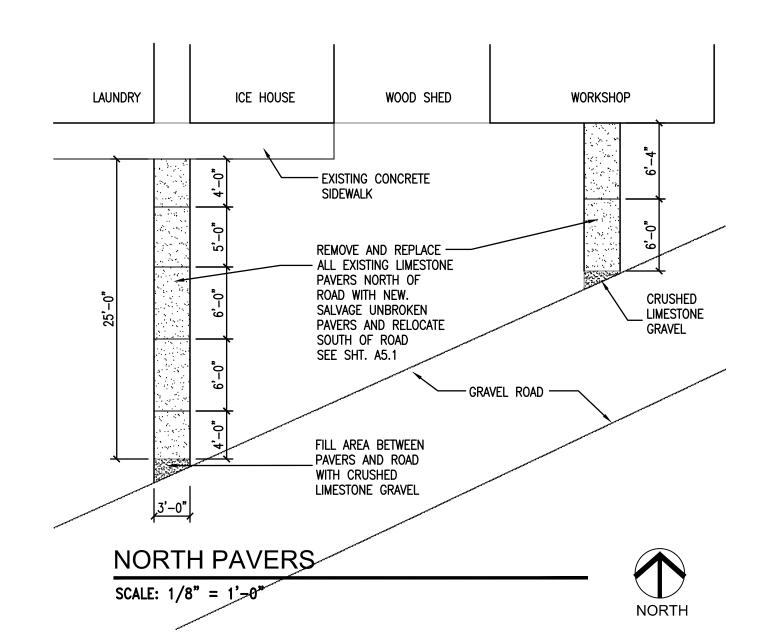



DCA MON MONTAUK MAIN HOUSE SITE WORK AND OUTBUILDING REPAIRS MONTAUK HISTORIC SITE 26223 HARDING RD, CLERMONT, IA 52135

STONE PAVERS NORTH & SOUTH

DAS NO. 9226.00

PROJECT NO. 2114 ISSUE DATE

3/21/22 SHEET NUMBER

A5.0 11 OF 20

LIMESTONE PAVER NOTES:

- A. FIELD VERIFY ALL STONE PAVER DIMENSIONS.
- B. CAREFULLY EXCAVATE AND REMOVE PAVERS IDENTIFIED TO BE SALVAGED AND RELOCATED TO AVOID DAMAGE. COORDINATE WITH OWNER AND CM FOR TEMPORARY STORAGE OF PAVERS BEFORE RELOCATING.
- C. NEW PAVERS ARE TO BE 4 INCHES THICK.
- D. OVER EXCAVATE AND SET NEW PAVERS ON 4 INCH THICK BED OF CRUSHED GRAVEL. COORDINATE OVER EXCAVATION WITH CM.
- E. REPAIR AND REGRADE LAWN AREA AROUND ALL PAVER WORK. SEED AND WATER TO RE-ESTABLISH LAWN.

NOTE: RELOCATE LETTER-LABLED PAVER UNITS FROM NORTH OF ROAD TO CORRESPONDING LABLED LOCATIONS SOUTH OF ROAD. CUT EXISTING PAVERS TO FIT AS NEEDED AT NEW LOCATIONS. REMOVE AND DISPOSE OF CRUMBLED PAVERS IN DESIGNATED RELOCATION AREAS.

939 OFFICE PARK RD., #101 WEST DES MOINES, IA 50265 TEL: 515-440-1681 FAX: 515-440-1687



DCA MON MONTAUK MAIN HOUSE SITE WORK AND OUTBUILDING REPAIRS MONTAUK HISTORIC SITE 26223 HARDING RD, CLERMONT, IA 52135


> STONE PAVERS RELOCATED

DAS NO. 9226.00

PROJECT NO. 2114

3/21/22 SHEET NUMBER

A5.1

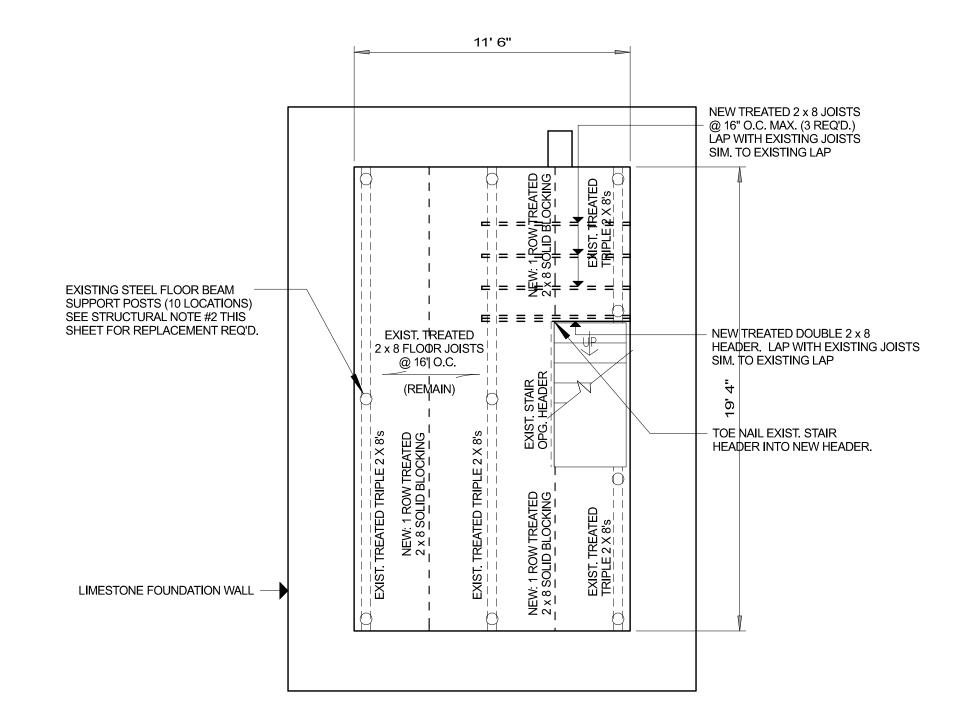

WORKSHOP FLOOR FRAMING PLAN

SCALE: 1/4" = 1' 0"

DESIGN DATA:

- 1. DESIGN STRESSES FOR NEW WOOD JOISTS: BENDING STRESS: Fb = 900 P.S.i. TREATED DOUGLAS FIR OR SYP, #2 OR BETTER.
- 2. DESIGN LIVE LOADS: WORKSHOP FLOOR - 100 P.S.F. (MUSEUM/OFFICE LOADING)

STRUCTURAL NOTES:

- 1. CONTRACTOR SHALL CORRELATE ALL DIMENSIONS ON STRUCTURAL DRAWINGS WITH ARCH. DRAWINGS AND VERIFY ALL EXISTING CONDITIONS AND DIMENSIONS THAT AFFECT NEW WORK, NOTIFY ARCHITECT OF ALL DISCREPANCIES.
- 2. INSTALL TEMPORARY SHORING TO SUPPORT EXISTING BEAMS TO ALLOW REMOVAL OF THE EXISTING FLOOR SUPPORT POSTS. REPLACE ALL TEN EXISTING POSTS WITH A GALVANIZED 3" DIAMETER STANDARD PIPE COLUMN WITH A 1/2" THICK GALVANIZED STEEL BASE PLATE AND CAP PLATE. INSTALL NEW COLS. TIGHT TO BOTTOM OF EXISTING BEAMS
- AND GROUT BETWEEN TOP OF EXISTING CONCRETE PIER AND BOTTOM OF BASE PLATE WITH NON-METALLIC, NON-SHRINK GROUT. 1" MINIMUM GROUT THICKNESS. AFTER GROUT HAS CURED, ANCHOR BASE PLATE TO EXISTING PIER WITH A MINIMUM OF 2 - 5/8" DIA, EPOXY OR WEDGE ANCHORS AT EACH COLUMN.

939 OFFICE PARK RD., # WEST DES MOINES, IA 50 TEL: 515-440-1681



STRUCTURAL

PROJECT TITLE:

MONTAUK HISTORIC SITE 26223 HARDING ROD., CLERMONT, IA. DCA MON MAIN HOUSE SITE WORK AND OUTBUILDING REPAIRS

SHEET CONTENTS

WORKSHOP STRUCTURAL PLANS AND DETAILS

EVISIONS:				
IOTE:	DATE:			

9226.00

I HEREBY CERTIFY THAT I HAVE PERSONALLY PREPARED THIS ENGINEERING DOCUMENT, AND THAT I AM A DULY LICENSED PROFESSIONAL ENGINEER UNDER THE LAWS OF THE STATE OF IOWA.

2114


3-14-2022

SHEET NUMBER **S1.0**



3/17/22

DONALD G. PETERSON, P.E., IOWA #7845 LICENSE RENEWAL DATE: 12/31/2022 CERTIFICATION FOR STRUCTURAL ENGINEERING, SHEET S1.0

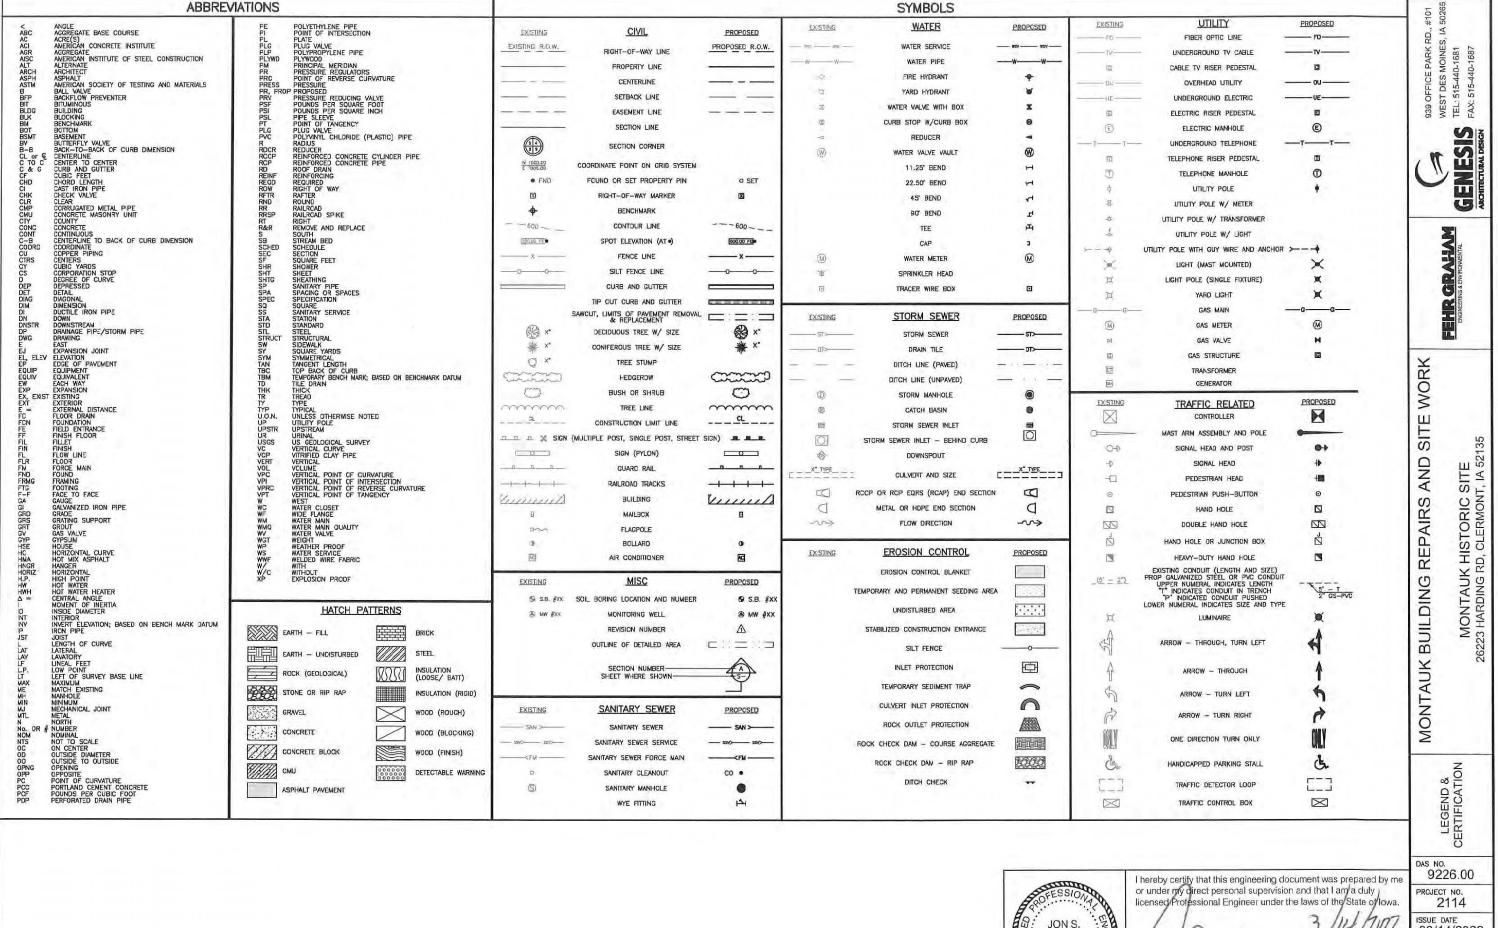

JONS. **BIEDERMAN** 13868 AWOLA

Jon 6. Biederman, P.E. License Number 13868

My license renewal date is December 31, 2022. Pages or sheets covered by this seal; C.01-C.06 14 OF 20

03/14/2022 SHEET NUMBER C.01

GENERAL NOTES

- 1. All work shall conform to and be performed in accordance with all applicable codes and ordinances.
- 2. The Urban Standard Specifications for Public Improvements (SUDAS), 2022 edition plus Supplemental Specifications and Special Provisions as prepared by Fehr Graham shall be considered a part of these documents as if bound
- 3. Any quantities shown on the Civil Sheets C.01 through C.06 are to assist the Bidder. The Bidder/Contractor shall make a final determination of the quantities required to complete the work and the bid shall be on the basis of the Bidder/Contractor's own calculations. Payment for work specified on Sheets C.01 through C.06 shall be per the project contract documents and not that listed in SUDAS. Any comment related to quantity or payment on the C Sheets is solely provided to assist the Bidder/Contractor in the preparation of bidding and shall not be cause for change order request.
- Construction Survey for this project to be provided by the OWNER. The Contractor is required to provide minimum of two business days' notice to the Engineer when requesting stakes. or CONTRACTOR.
- 5. The CONTRACTOR shall notify all appropriate engineering departments and utility companies prior to construction. All necessary precautions shall be taken to avoid damage to any existing utility. Iowa Code 480, Underground Facilities Information, requires notice to Iowa One Call (1—800—292—8989) not less than 48 hours before excavation, excluding weekends and legal
- 6. The location of existing underground utilities and rock elevations are shown in an approximate way only and have not been independently verified by the OWNER or its représentative. The CONTRACTOR shall determine the éxact location of all existing utilities and rock elevations before commencing work, and agrees to be fully responsible for any and all damages which might be occasioned by the CONTRACTOR'S failure to locate and preserve any and all underground utilities and rock elevations.
- 7. The CONTRACTOR shall visit the site and inspect the project area and become thoroughly familiar with the actual job conditions prior to bidding and the start of any work. Failure to visit the site shall not relieve the CONTRACTOR from performing the work in accordance with these drawings.
- 8. The CONTRACTOR shall verify at the site, all dimensions and conditions shown on the drawings, and shall notify the ENGINEER of any discrepancies, omissions, and/or conflict prior to proceeding with the work.
- The CONTRACTOR shall not scale drawings. Dimensions shall govern. Large scale drawings shall govern over small scale drawings. Notes and details on the drawings shall apply to all similar conditions whether they are repeated
- 10. The CONTRACTOR shall be responsible for any damage to existing facilities outside the construction limits resulting from negligence
- 11. CONTRACTOR shall protect existing facilities, buildings, and other appurtenances not to be removed from the site during the construction
- 12. CONTRACTOR shall confine his work to the construction limits and easements. If the CONTRACTOR obtains additional easement for the storage of equipment and materials, copies of the agreements with the property Owners shall be provided to the OWNER.
- 13. CONTRACTOR shall submit a detailed construction schedule and staging plan a minimum of two (2) days prior to the preconstruction meeting.
- 14. CONTRACTOR shall be responsible to maintain access to individual properties during construction whenever practical. CONTRACTOR shall notify residents of access restrictions minimum of 24 hours prior to removal of existing access.
- 15. CONTRACTOR shall submit for acceptance work plans and schedules for accomplishment of temporary and permanent erosion control prior to the start of construction.
- 16. CONTRACTOR shall coordinate temporary disruption of utility services with the affected utility companies and/or affected property owners when relocating existing facilities, connecting to existing facilities and placing new services

SUPPLEMENTAL SPECIFICATIONS

Statewide Urban Design and Specifications (SUDAS) are the base specification for this project. The following supplemental specifications modify the standard specifications. SUDAS method of measurement and payment does not apply for this project. All costs shall be included in the overall bid as specified in the contract documents.

DIVISION 3 - TRENCH AND BACKFILL

2.02 - BEDDING MATERIAL

A. 1. Use clean stone for pipe envelope in wet trench or as directed by the Engineer. IDOT gradation no. 11, 12 or 31 shall be used for pipe envelope in dry trench unless otherwise directed by the Engineer. 3.05 - PIPE BEDDING AND BACKFILL

Pipe Embedment Requirements for Rigid Gravity Pipe:

Class R-1

RCAP and RCEP: Class R-5

Pipe Embedment Requirements for Flexible Gravity Pipe:

PVC Truss Pipe and DR18: Class F-2

HDPE Single & Dual Wall, PVC Gravity Pipe (SDR 23.5, 26, 35): Class F-3

Pipe Embedment Requirements for Pressure Pipe:

PVC DR18: Class P-3

DIVISION 4 - SEWERS AND DRAINS

SECTION 4020

1.03 - SUBMITTALS

A. The Jurisdictional Engineer hereby requests that all materials to be incorporated into the work have certifications furnished which show that the materials comply with Specifications prior to any construction. - STORM SEWERS

Storm sewer main to be HDPE dual wall. SECTION 4030

2.02 - PIPE APRONS

CMP pipe apron required for this project, attach to HDPE dual wall pipe.

DIVISION 5 - WATER MAINS AND APPURTENANCES

SECTION 5010

1.03 - SUBMITTALS

A. The Jurisdictional Engineer hereby requests that all materials to be incorporated into the work have certifications furnished which show that the materials comply with Specifications prior to any construction.

3.13 Insulation

999-B. Rigid insulation board with minimum total R=16 shall be placed 6" above existing water service line. Excavate an 8'x16' area, centered on the service line, level, place rigid insulation (4" thick will typically have total R greater than 16, verify), and backfill. Stagger, or rotate, layers of insulation board so joints do not align.

DIVISION 6 - STRUCTURES FOR SANITARY AND STORM

SECTION 6010

1.03 - SUBMITTALS

The Jurisdictional Engineer hereby requests that all materials to be incorporated into the work have certifications furnished which show that the materials comply with Specifications prior to any construction.

DIVISION 7 - STREETS & RELATED WORK

SECTION 7030

2.08 - GRANULAR DRIVEWAY SURFACING Use Class A crushed stone.

DIVISION 9 - SITE WORK & LANDSCAPING

SECTION 9010

2.02 - SEED MIXTURES

All seeding shall be Type 1 (Permanent Lawn Mixture). Contractor is responsible for obtaining full grass coverage, including reseeding as may be necessary. Fertilizing and mulching is required. Hydroseeding is

SECTION 9040

3.13 - RIP RAP

1. Install rip rap (revetment stone or erosion stone) as shown on Figures 9040.110 and 9040.111. Place rip rap on engineering fabric.

RD.,





WORK SITE MONTAUK HISTORIC SITE 26223 HARDING RD, CLERMONT, IA 52135 AND REPAIRS BUILDING MONTAUK

GENERAL NOTES & SUPPLEMENTAL SPECIFICATIONS

DAS NO. 9226.00

PROJECT NO. 2114

ISSUE DATE 03/14/2022

SHEET NUMBER C.02

15 OF 20

CP#2 = ALUMINUM CAP ON REBAR (Pt#2) N-9031386.78, E-15660901.59, ELEV-1039.22

GENESIS ACHIECTRAN DESCRIP FEHR GRALLAM ENGINE & ENCINCAMENTAL MONTAUK BUILDING REPAIRS AND SITE WORK MONTAUK HISTORIC SITE 26223 HARDING RD, CLERMONT, IA 52135

EXISTING CONDITIONS PLAN

DAS NO. 9226.00


PROJECT NO. **2114**


ISSUE DATE 03/14/2022

SHEET NUMBER

C.03 16 OF 20

BM#2 = TOP CENTER OF METAL STRUCTURE (Pt# 1235) N-9031266.99, E-15660958.75, ELEV-1044.87'

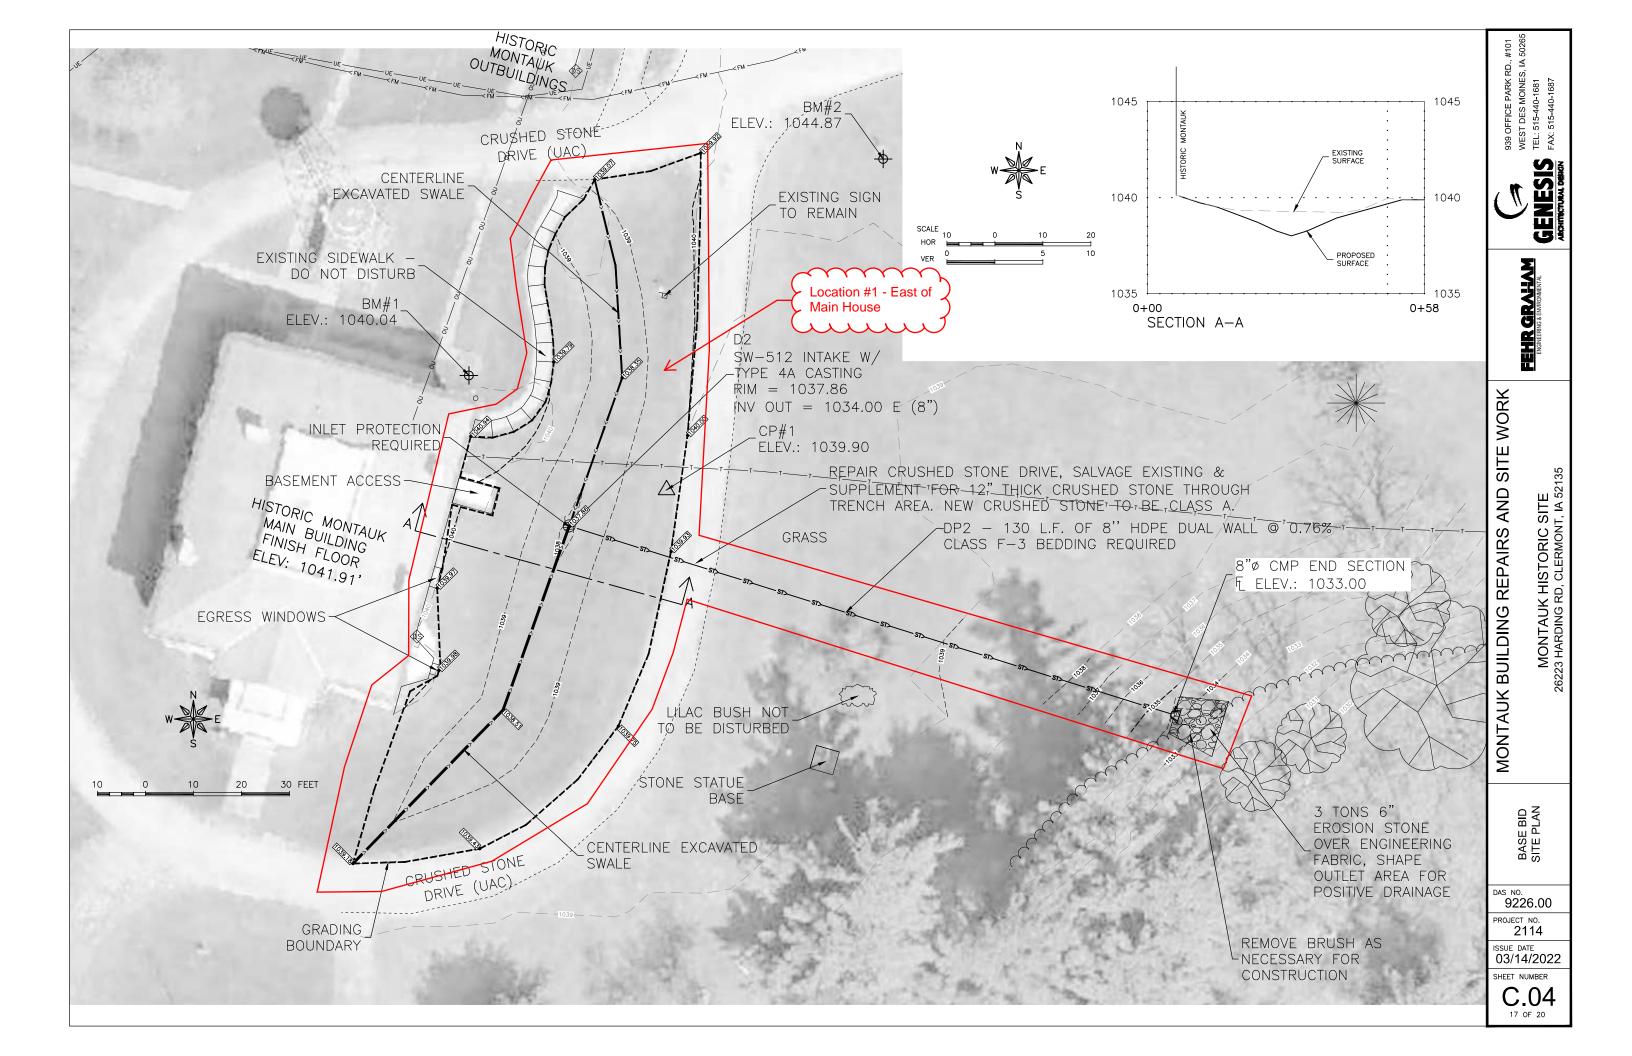

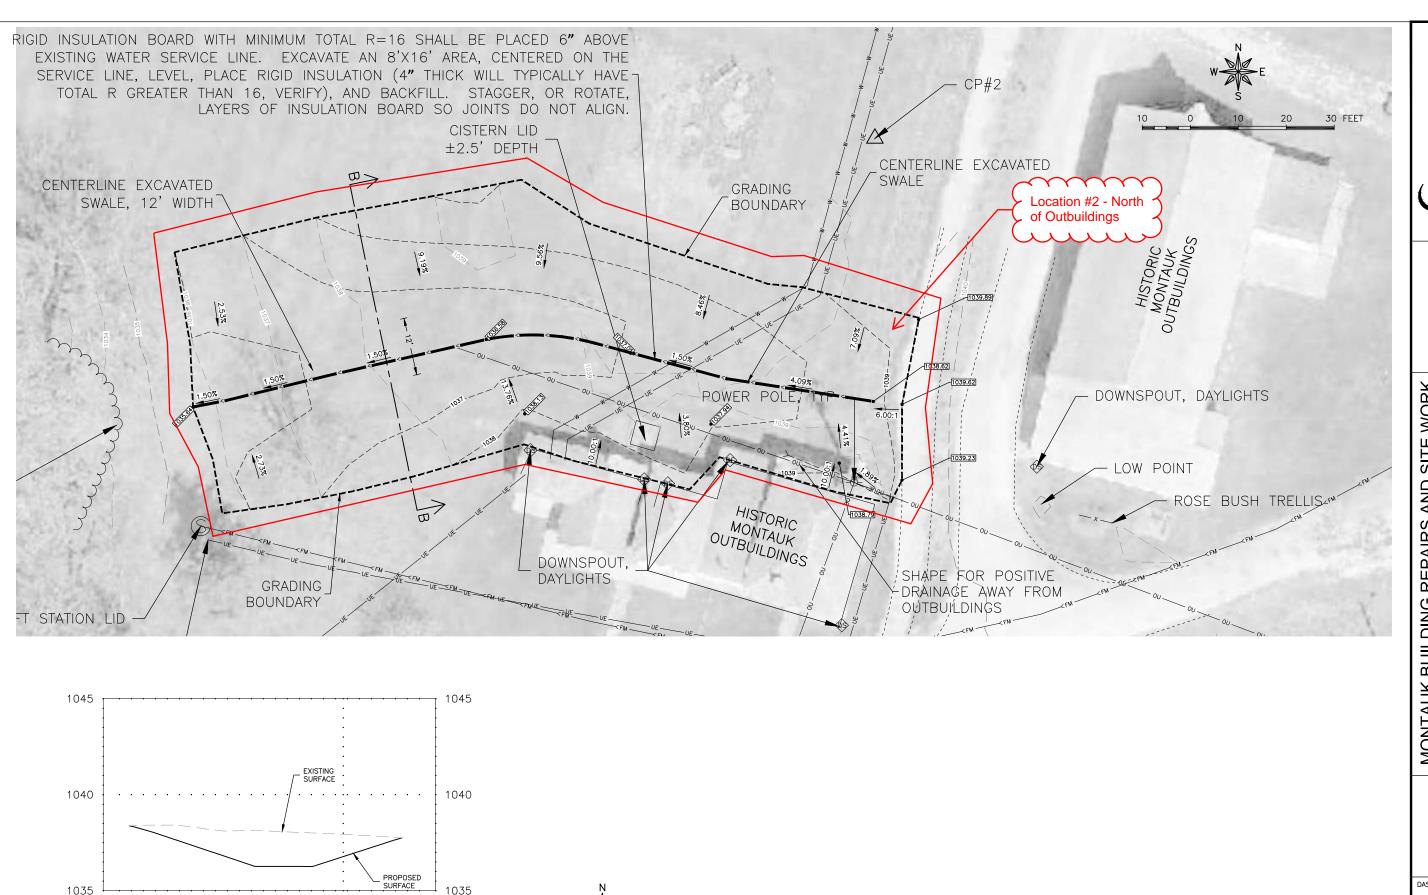

0+00

SECTION B-B

0+69





FEHR GRAHAM ENGINEERING & ENVIRONMENTAL

MONTAUK BUILDING REPAIRS AND SITE WORK

MONTAUK HISTORIC SITE 26223 HARDING RD, CLERMONT, IA 52135


9226.00

PROJECT NO. 2114

03/14/2022

SHEET NUMBER

C.05

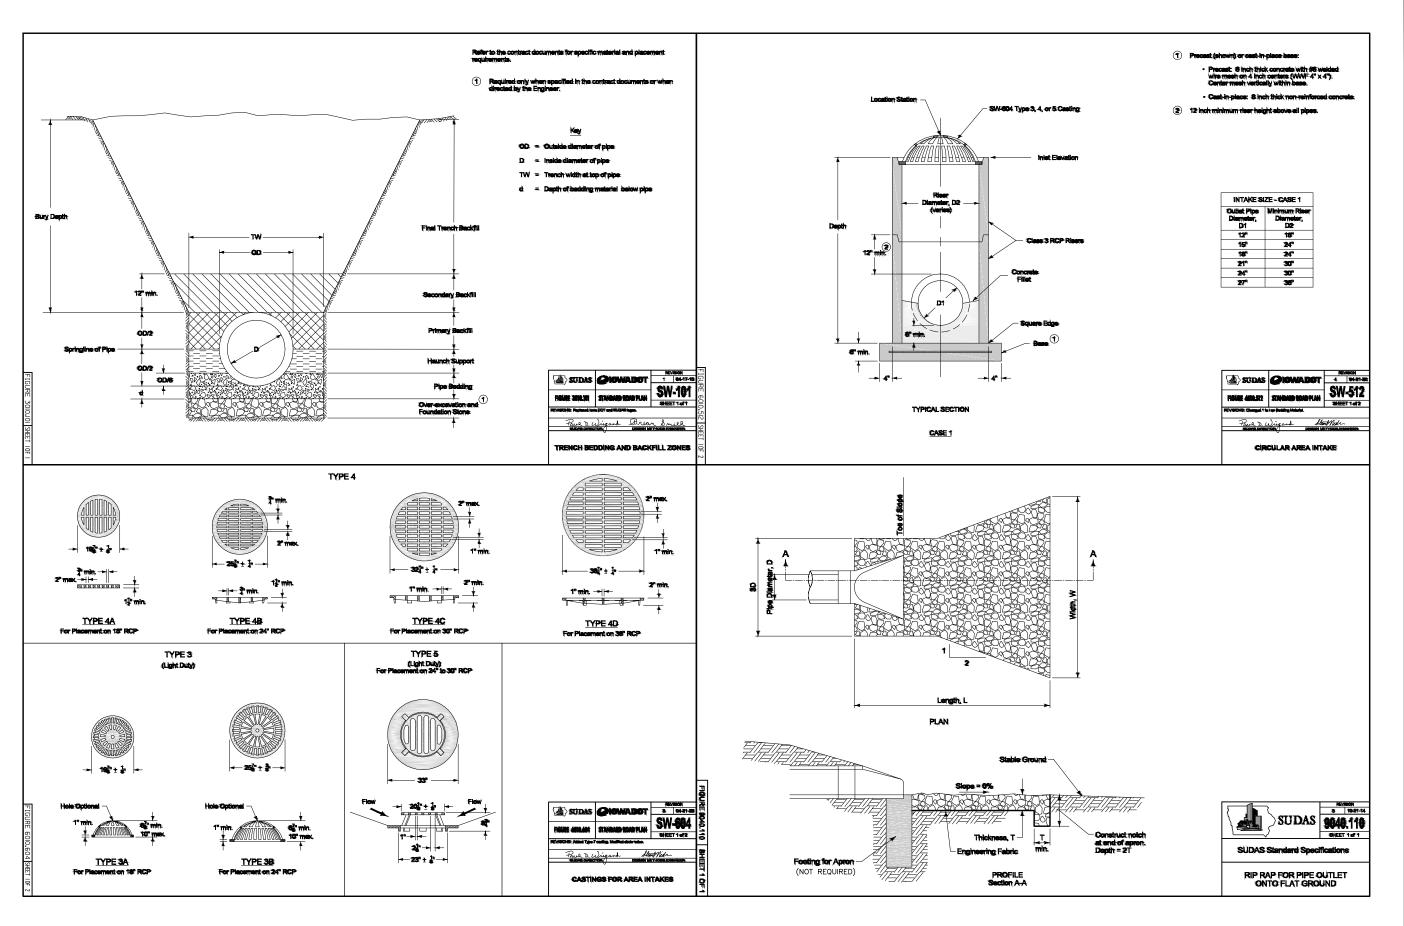

39 OFFICE PARK RD., #101 VEST DES MOINES, IA 50265 EL: 515-440-1681

WEST DES WEST DES TEL: 515-44



FEHR GRALLAM ENGINERING & ENVIRONMENTAL

MONTAUK BUILDING REPAIRS AND SITE WORK
MONTAUK HISTORIC SITE
26223 HARDING RD, CLERMONT, IA 52135

SUDAS DETAILS

DAS NO. 9226.00

PROJECT NO. **2114**

ISSUE DATE 03/14/2022

SHEET NUMBER

C.06

WORKSHOP ELECTRICAL PLAN SCALE:3/16" = 1'-0"



B. UNDERGROUND MINIMUM CONDUIT COVER TO BE INSTALLED IN ACCORDANCE WITH NEC TABLE

ELECTRICAL KEY NOTES:

- 1. EXTEND BRANCH CIRCUITS IN NEW UNDERGROUND CONDUIT TO INTERIOR WALL OF WORKSHOP. CONDUIT SHALL BE 3/4" TRADE SIZE.
- 2. BRANCH CIRCUIT CONDUCTORS SHALL BE STRANDED #12 AWG THHN.
- 3. RECEPTACLES SHALL BE SURFACE MOUNTED WITH STAINLESS STEEL COVER PLATE.
- 4. RECEPTACLES SHALL BE 20A, GFCI TYPE.
- 5. INSTALL DUCT SEAL IN CONDUIT AT INTERIOR SIDE OF WALL.
- 6. INSTALL TWO (2) 20A CIRCUIT BREAKERS IN EXISTING PANEL.

MATTHEW R. **PROSS** 20814

I hereby certify that this engineering document was prepared by me or under my direct personal supervision and that I am a duly licensed Professional Engineer under the laws of the State of lowa.

Matthew R. Pross

02/24/2022

Date

My license expiration date is: December 31, 2023

Sheets covered by this seal: E1.0

939 OFFICE PARK RD., #101 WEST DES MOINES, IA 50265 TEL: 515-440-1681 FAX: 515-440-1687

WORK SITE MONTAUK BUILDING REPAIRS AND

DAS NO. 9226.00

PROJECT NO. 2114 ISSUE DATE

3 - 14 - 22 SHEET NUMBER

E1.0 20 of 20