



ISD OUTREACH BUILDING AND ELEMENTARY BUILDING FIRE ALARM REPLACEMENT

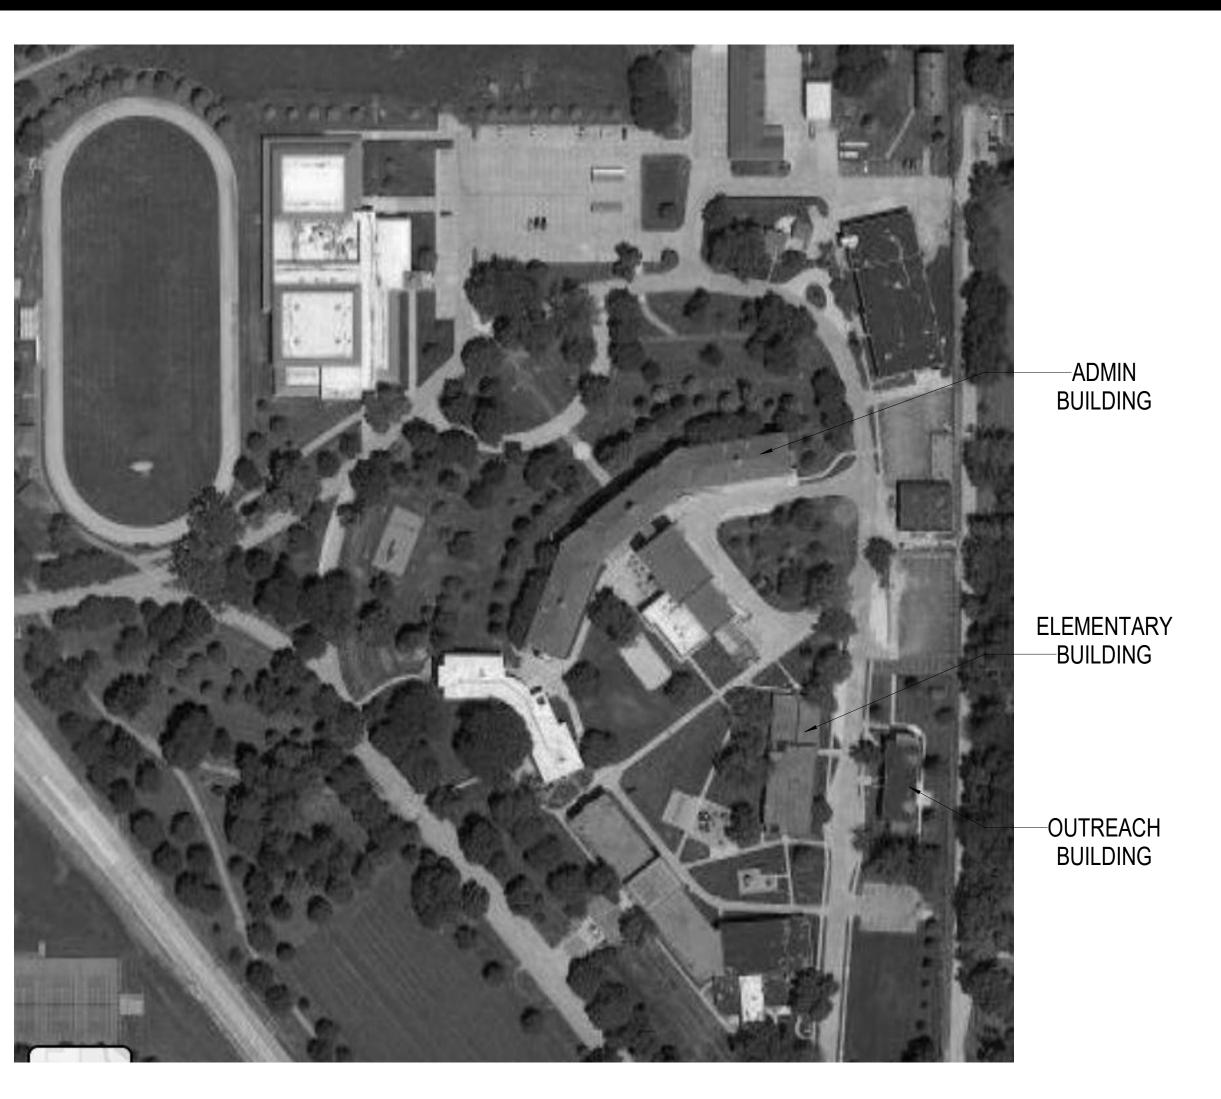

3501 HARRY LANGDON BLVD. COUNCIL BLUFFS, IA 51503 CONSTRUCTION DRAWINGS

FEBRUARY 2, 2024 MEI PROJECT #23266 RFB938100-01

SHEET LIST					
Sheet Number	Sheet Name				
E001	COVER SHEET				
E002	FIRE ALARM DETAILS AND NOTES				
ED101	OUTREACH BUILDING - FIRE ALARM DEMOLITION PLANS				
ED201	ELEMENTARY SCHOOL - FIRE ALARM DEMOLITION PLANS				
E101	OUTREACH BUILDING - FIRE ALARM PLANS				
E201	ELEMENTARY SCHOOL - FIRE ALARM PLANS				

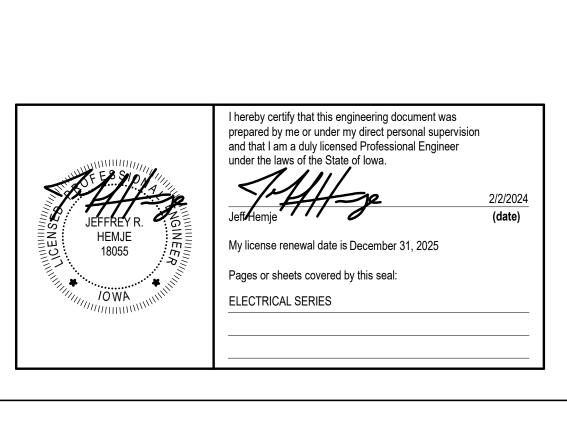

IOWA SCHOOL FOR FIRE ALARM REPL

agency approval

date: 2/2/2024


project 23266

designed by: JRH

drawn by: DGM

E001

	ELECTRICAL SYMBOLS					
SYMBOL	DESCRIPTION	SYMBOL	DESCRIPTION			
	FIRE	ALARM				
◆	FIRE ALARM SMOKE DETECTOR	(F)	CEILING FIRE ALARM STROBE			
Ф	FIRE ALARM HEAT DETECTOR	ĒΑ	CEILING FIRE ALARM STROBE - AMBER			
-	DUCT MOUNTED SMOKE DETECTOR	ĒВ	CEILING FIRE ALARM STROBE - BLUE			
F	FIRE ALARM MANUAL PULL STATION	⊢(F) SW	WALL SEVERE WEATHER STROBE			
F -X	FIRE SPRINKLER VALVE TAMPER SWITCH	⊢€	WALL FIRE ALARM STROBE			
F₩	FIRE SPRINKLER FLOW SWITCH	⊢€A	WALL FIRE ALARM STROBE - AMBER			
FACP	FIRE ALARM CONTROL PANEL	⊢₽B	WALL FIRE ALARM STROBE - BLUE			
FAAP	FIRE ALARM ANNUNCIATOR PANEL	(f)	CEILING FIRE ALARM HORN & STROBE COMBINATION			
H	FIRE ALARM MAGNETIC DOOR HOLDER	F	CEILING FIRE ALARM SPEAKER & STROBE COMBINATION			
FK	FIRE ALARM HORN & STROBE COMBINATION	⊬ F	WALL FIRE ALARM SPEAKER & STROBE COMBINATION			
F◀	FIRE ALARM MINI-HORN & STROBE COMBINATION	(S)F	CEILING FIRE ALARM SPEAKER			
	PANIC BUTTON LOCATION	⊬s⟩F	WALL FIRE ALARM SPEAKER			
			WALL FIRE ALARW SPEARER			
	GE	NERAL				
	GE LIGHTING PANEL	NERAL ⊢⊕	WALL MOUNTED JUNCTION BOX			
	GE LIGHTING PANEL DISTRIBUTION PANEL SWITCHBOARD OR MOTOR CONTROL CENTER	NERAL	WALL MOUNTED JUNCTION BOX JUNCTION BOX			
	GE LIGHTING PANEL DISTRIBUTION PANEL SWITCHBOARD OR MOTOR CONTROL CENTER CABINET, ENCLOSURE, OR CONTROL PANEL, TYPE INDICATED ON PLANS	NERAL ⊢⊕	WALL MOUNTED JUNCTION BOX			
	GE LIGHTING PANEL DISTRIBUTION PANEL SWITCHBOARD OR MOTOR CONTROL CENTER	NERAL ⊢⊕	WALL MOUNTED JUNCTION BOX JUNCTION BOX CONDUIT SEAL			
	GE LIGHTING PANEL DISTRIBUTION PANEL SWITCHBOARD OR MOTOR CONTROL CENTER CABINET, ENCLOSURE, OR CONTROL PANEL, TYPE INDICATED ON PLANS BRANCH CIRCUIT - EXPOSED	NERAL ⊢⊕	WALL MOUNTED JUNCTION BOX JUNCTION BOX CONDUIT SEAL CIRCUIT DOWN			
	GE LIGHTING PANEL DISTRIBUTION PANEL SWITCHBOARD OR MOTOR CONTROL CENTER CABINET, ENCLOSURE, OR CONTROL PANEL, TYPE INDICATED ON PLANS BRANCH CIRCUIT - EXPOSED BRANCH CIRCUIT CONCEALED IN CEILING OR WALL	NERAL ⊢⊕	WALL MOUNTED JUNCTION BOX JUNCTION BOX CONDUIT SEAL CIRCUIT DOWN CIRCUIT UP			
	LIGHTING PANEL DISTRIBUTION PANEL SWITCHBOARD OR MOTOR CONTROL CENTER CABINET, ENCLOSURE, OR CONTROL PANEL, TYPE INDICATED ON PLANS BRANCH CIRCUIT - EXPOSED BRANCH CIRCUIT CONCEALED IN CEILING OR WALL BRANCH CIRCUIT CONCEALED IN FLOOR	NERAL ⊢⊕	WALL MOUNTED JUNCTION BOX JUNCTION BOX CONDUIT SEAL CIRCUIT DOWN CIRCUIT UP CONDUIT STUB-OUT			
	CE LIGHTING PANEL DISTRIBUTION PANEL SWITCHBOARD OR MOTOR CONTROL CENTER CABINET, ENCLOSURE, OR CONTROL PANEL, TYPE INDICATED ON PLANS BRANCH CIRCUIT - EXPOSED BRANCH CIRCUIT CONCEALED IN CEILING OR WALL BRANCH CIRCUIT CONCEALED IN FLOOR BRANCH CIRCUIT - CLASS TWO WIRING	NERAL O S S S S S S S S S S S S	WALL MOUNTED JUNCTION BOX JUNCTION BOX CONDUIT SEAL CIRCUIT DOWN CIRCUIT UP CONDUIT STUB-OUT CIRCUIT BREAK			
	GE LIGHTING PANEL DISTRIBUTION PANEL SWITCHBOARD OR MOTOR CONTROL CENTER CABINET, ENCLOSURE, OR CONTROL PANEL, TYPE INDICATED ON PLANS BRANCH CIRCUIT - EXPOSED BRANCH CIRCUIT CONCEALED IN CEILING OR WALL BRANCH CIRCUIT CONCEALED IN FLOOR BRANCH CIRCUIT - CLASS TWO WIRING HOMERUN TO PANEL (QUANTITY OF ARROWS INDICATES QUANTITY OF CIRCUITS)	NERAL O	WALL MOUNTED JUNCTION BOX JUNCTION BOX CONDUIT SEAL CIRCUIT DOWN CIRCUIT UP CONDUIT STUB-OUT CIRCUIT BREAK BELL			
	LIGHTING PANEL DISTRIBUTION PANEL SWITCHBOARD OR MOTOR CONTROL CENTER CABINET, ENCLOSURE, OR CONTROL PANEL, TYPE INDICATED ON PLANS BRANCH CIRCUIT - EXPOSED BRANCH CIRCUIT CONCEALED IN CEILING OR WALL BRANCH CIRCUIT CONCEALED IN FLOOR BRANCH CIRCUIT - CLASS TWO WIRING HOMERUN TO PANEL (QUANTITY OF ARROWS INDICATES QUANTITY OF CIRCUITS) SPECIAL PURPOSE HOMERUN AS INDICATED	NERAL O	WALL MOUNTED JUNCTION BOX JUNCTION BOX CONDUIT SEAL CIRCUIT DOWN CIRCUIT UP CONDUIT STUB-OUT CIRCUIT BREAK BELL PUSH BUTTON			
	LIGHTING PANEL DISTRIBUTION PANEL SWITCHBOARD OR MOTOR CONTROL CENTER CABINET, ENCLOSURE, OR CONTROL PANEL, TYPE INDICATED ON PLANS BRANCH CIRCUIT - EXPOSED BRANCH CIRCUIT CONCEALED IN CEILING OR WALL BRANCH CIRCUIT CONCEALED IN FLOOR BRANCH CIRCUIT - CLASS TWO WIRING HOMERUN TO PANEL (QUANTITY OF ARROWS INDICATES QUANTITY OF CIRCUITS) SPECIAL PURPOSE HOMERUN AS INDICATED CONDUIT / CONDUIT SLEEVE (SIZE INDICATED ON PLANS)	NERAL O	WALL MOUNTED JUNCTION BOX JUNCTION BOX CONDUIT SEAL CIRCUIT DOWN CIRCUIT UP CONDUIT STUB-OUT CIRCUIT BREAK BELL PUSH BUTTON BUZZER			
WP	LIGHTING PANEL DISTRIBUTION PANEL SWITCHBOARD OR MOTOR CONTROL CENTER CABINET, ENCLOSURE, OR CONTROL PANEL, TYPE INDICATED ON PLANS BRANCH CIRCUIT - EXPOSED BRANCH CIRCUIT CONCEALED IN CEILING OR WALL BRANCH CIRCUIT CONCEALED IN FLOOR BRANCH CIRCUIT - CLASS TWO WIRING HOMERUN TO PANEL (QUANTITY OF ARROWS INDICATES QUANTITY OF CIRCUITS) SPECIAL PURPOSE HOMERUN AS INDICATED CONDUIT / CONDUIT SLEEVE (SIZE INDICATED ON PLANS) SUBSCRIPT "WP" APPLIED TO ANY SYMBOL INDICATES WEATHERPROOF NEMA TYPE 3R OR EQUIVALENT SUBSCRIPT "3R" OR "RT" APPLIED TO ANY SYMBOL INDICATES	NERAL O O O O O O O O O O O O O	WALL MOUNTED JUNCTION BOX JUNCTION BOX CONDUIT SEAL CIRCUIT DOWN CIRCUIT UP CONDUIT STUB-OUT CIRCUIT BREAK BELL PUSH BUTTON BUZZER			
	LIGHTING PANEL DISTRIBUTION PANEL SWITCHBOARD OR MOTOR CONTROL CENTER CABINET, ENCLOSURE, OR CONTROL PANEL, TYPE INDICATED ON PLANS BRANCH CIRCUIT - EXPOSED BRANCH CIRCUIT CONCEALED IN CEILING OR WALL BRANCH CIRCUIT CONCEALED IN FLOOR BRANCH CIRCUIT - CLASS TWO WIRING HOMERUN TO PANEL (QUANTITY OF ARROWS INDICATES QUANTITY OF CIRCUITS) SPECIAL PURPOSE HOMERUN AS INDICATED CONDUIT / CONDUIT SLEEVE (SIZE INDICATED ON PLANS) SUBSCRIPT "WP" APPLIED TO ANY SYMBOL INDICATES WEATHERPROOF NEMA TYPE 3R OR EQUIVALENT SUBSCRIPT "3R" OR "RT" APPLIED TO ANY SYMBOL INDICATES WEATHERPROOF NEMA TYPE 3R OR EQUIVALENT	NERAL O F F F F F F F F F F F F	WALL MOUNTED JUNCTION BOX JUNCTION BOX CONDUIT SEAL CIRCUIT DOWN CIRCUIT UP CONDUIT STUB-OUT CIRCUIT BREAK BELL PUSH BUTTON BUZZER THERMOSTAT			
E-3 WP 3R OR RT	LIGHTING PANEL DISTRIBUTION PANEL SWITCHBOARD OR MOTOR CONTROL CENTER CABINET, ENCLOSURE, OR CONTROL PANEL, TYPE INDICATED ON PLANS BRANCH CIRCUIT - EXPOSED BRANCH CIRCUIT CONCEALED IN CEILING OR WALL BRANCH CIRCUIT CONCEALED IN FLOOR BRANCH CIRCUIT - CLASS TWO WIRING HOMERUN TO PANEL (QUANTITY OF ARROWS INDICATES QUANTITY OF CIRCUITS) SPECIAL PURPOSE HOMERUN AS INDICATED CONDUIT / CONDUIT SLEEVE (SIZE INDICATED ON PLANS) SUBSCRIPT "WP" APPLIED TO ANY SYMBOL INDICATES WEATHERPROOF NEMA TYPE 3R OR EQUIVALENT SUBSCRIPT "3R" OR "RT" APPLIED TO ANY SYMBOL INDICATES WEATHERPROOF NEMA TYPE 3R OR EQUIVALENT SUBSCRIPT "9D" ADDED TO ANY FLOOR OUTLET INDICATES PEDESTAL	NERAL O O O O O O O O O O O O O	WALL MOUNTED JUNCTION BOX JUNCTION BOX CONDUIT SEAL CIRCUIT DOWN CIRCUIT UP CONDUIT STUB-OUT CIRCUIT BREAK BELL PUSH BUTTON BUZZER THERMOSTAT SUBSCRIPT "E" ADDED TO ANY SYMBOL INDICATES EXISTING SUBSCRIPT "R" ADDED TO ANY SYMBOL INDICATES RELOCATED WHERE (TYP) IS USED ON PLANS INDICATES A TYPICAL NOTE OR CONDITION			
WP	LIGHTING PANEL DISTRIBUTION PANEL SWITCHBOARD OR MOTOR CONTROL CENTER CABINET, ENCLOSURE, OR CONTROL PANEL, TYPE INDICATED ON PLANS BRANCH CIRCUIT - EXPOSED BRANCH CIRCUIT CONCEALED IN CEILING OR WALL BRANCH CIRCUIT CONCEALED IN FLOOR BRANCH CIRCUIT - CLASS TWO WIRING HOMERUN TO PANEL (QUANTITY OF ARROWS INDICATES QUANTITY OF CIRCUITS) SPECIAL PURPOSE HOMERUN AS INDICATED CONDUIT / CONDUIT SLEEVE (SIZE INDICATED ON PLANS) SUBSCRIPT "WP" APPLIED TO ANY SYMBOL INDICATES WEATHERPROOF NEMA TYPE 3R OR EQUIVALENT SUBSCRIPT "3R" OR "RT" APPLIED TO ANY SYMBOL INDICATES WEATHERPROOF NEMA TYPE 3R OR EQUIVALENT	NERAL O F F F F F F F F F F F F	WALL MOUNTED JUNCTION BOX JUNCTION BOX CONDUIT SEAL CIRCUIT DOWN CIRCUIT UP CONDUIT STUB-OUT CIRCUIT BREAK BELL PUSH BUTTON BUZZER THERMOSTAT SUBSCRIPT "E" ADDED TO ANY SYMBOL INDICATES EXISTING SUBSCRIPT "R" ADDED TO ANY SYMBOL INDICATES RELOCATED			
E-3 WP 3R OR RT	LIGHTING PANEL DISTRIBUTION PANEL SWITCHBOARD OR MOTOR CONTROL CENTER CABINET, ENCLOSURE, OR CONTROL PANEL, TYPE INDICATED ON PLANS BRANCH CIRCUIT - EXPOSED BRANCH CIRCUIT CONCEALED IN CEILING OR WALL BRANCH CIRCUIT CONCEALED IN FLOOR BRANCH CIRCUIT - CLASS TWO WIRING HOMERUN TO PANEL (QUANTITY OF ARROWS INDICATES QUANTITY OF CIRCUITS) SPECIAL PURPOSE HOMERUN AS INDICATED CONDUIT / CONDUIT SLEEVE (SIZE INDICATED ON PLANS) SUBSCRIPT "WP" APPLIED TO ANY SYMBOL INDICATES WEATHERPROOF NEMA TYPE 3R OR EQUIVALENT SUBSCRIPT "3R" OR "RT" APPLIED TO ANY SYMBOL INDICATES WEATHERPROOF NEMA TYPE 3R OR EQUIVALENT SUBSCRIPT "9D" ADDED TO ANY FLOOR OUTLET INDICATES PEDESTAL	NERAL O F R R R (TYP)	WALL MOUNTED JUNCTION BOX JUNCTION BOX CONDUIT SEAL CIRCUIT DOWN CIRCUIT UP CONDUIT STUB-OUT CIRCUIT BREAK BELL PUSH BUTTON BUZZER THERMOSTAT SUBSCRIPT "E" ADDED TO ANY SYMBOL INDICATES EXISTING SUBSCRIPT "A" ADDED TO ANY SYMBOL INDICATES RELOCATED WHERE (TYP) IS USED ON PLANS INDICATES A TYPICAL NOTE OR CONDITION			

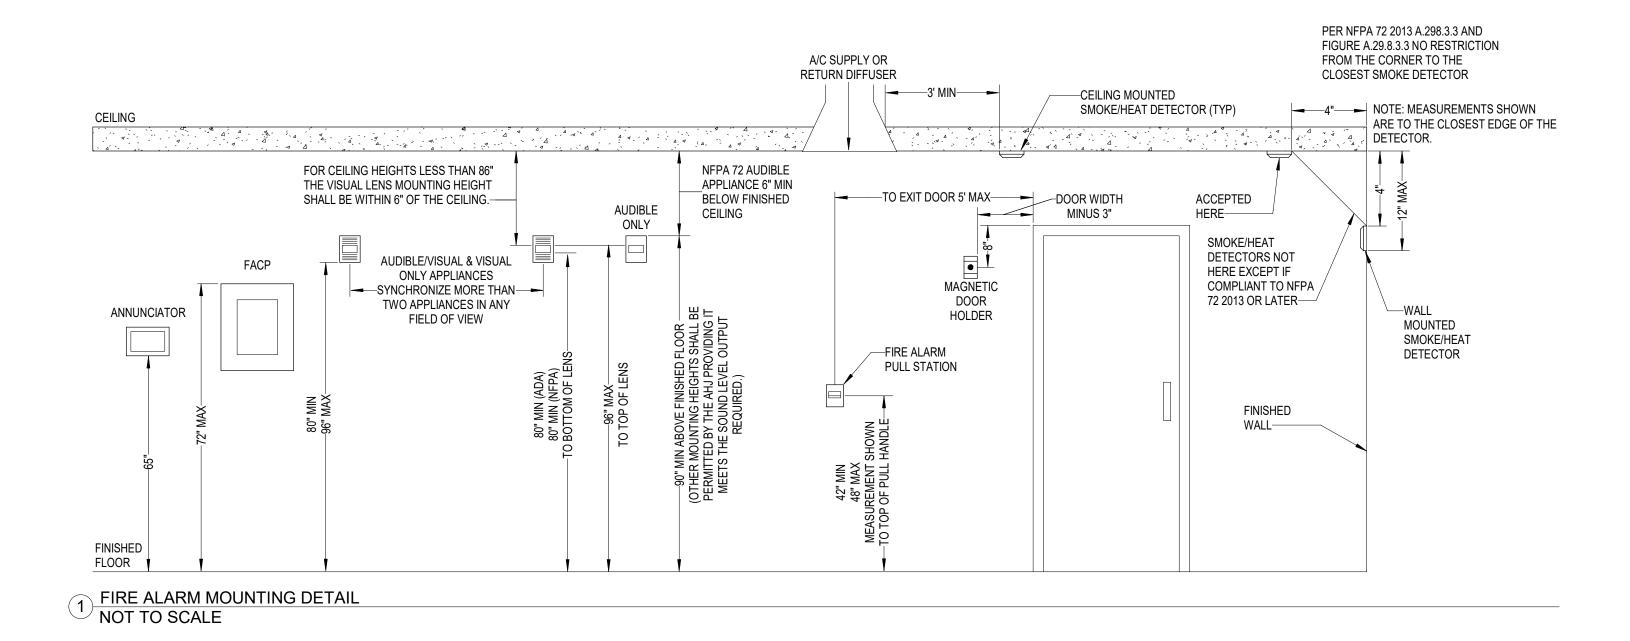

GENERAL FIRE ALARM NOTES

REQUIREMENTS.

1. ALL FIRE ALARM WIRING SHALL BE RAN IN CONDUIT. IN EXPOSED STRUCTURE AREAS, ROUTE

CONDUIT TIGHT TO DECK. CONDUIT SHALL BE ROUTED PARALLEL OR PERPENDICULAR TO STRUCTURE IN A NEAT AND WORKMANLIKE MANNER AND GROUPED WHERE POSSIBLE. PAINT

EXPOSED CONDUIT TO MATCH STRUCTURE IN FINISHED AREAS WITHOUT A CEILING.

2. PROVIDE ELECTRICAL CONNECTIONS TO SMOKE AND FIRE/SMOKE DAMPERS INCLUDING

POWER AND FIRE ALARM. PROVIDE A DUCT MOUNTED SMOKE DETECTOR WITH 5'-0" OF SMOKE DAMPER PER IMC 607.3.3.2. PROVIDE 120V CONNECTION FROM LOCKABLE CIRCUIT BREAKER IN

NEAREST 120V PANEL WITH A MAXIMUM OF 6 PER 20A/1P CIRCUIT. SEE DETAIL FOR ADDITIONAL

GENERAL ELECTRICAL DEMOLITION NOTES

WHICH ARE NOT REMOVED.

CONDITIONS PRIOR TO THE BID DATE.

MANUAL AND NEW WORK DRAWINGS.

CIRCUITING CONTINUITY UNLESS NOTED OTHERWISE.

FOR NEW LOCATION AND RECONNECT AS REQUIRED.

8. UPDATE ALL PANELBOARD DIRECTORIES IMPACTED BY ELECTRICAL WORK.

1. THE OWNER SHALL HAVE FIRST SALVAGE RIGHTS TO ALL FIXTURES, DEVICES AND EQUIPMENT

2. WHERE EXISTING CIRCUITS ARE NOT REUSED, REMOVE CONDUCTORS AND ASSOCIATED ACCESSIBLE RACEWAYS BACK TO THE SOURCE. ABANDON CONCEALED CONDUITS IN WALLS

3. DEMOLITION DRAWINGS INDICATE FIXTURES, DEVICES AND MAJOR PIECES OF EQUIPMENT

PROJECT MANUAL "WORK IN EXISTING BUILDINGS" FOR ADDITIONAL INFORMATION.

4. ALL EXISTING ELECTRICAL DEVICES, FIXTURES, EQUIPMENT, WIRING AND RACEWAYS INCLUDING DATA/COMMUNICATION SYSTEMS SHALL BE REMOVED UNLESS OTHERWISE INDICATED. WHERE EXISTING WALLS ARE TO BE REMOVED ALL ASSOCIATED ELECTRICAL EQUIPMENT SHALL BE REMOVED. DISCONNECT POWER SO THAT DEVICES AND EQUIPMENT MAY BE REMOVED WITH WALLS. SEE ARCHITECTURAL DRAWINGS FOR WALLS TO BE REMOVED. ABANDON CONCEALED CONDUITS WHERE WALLS ARE NOT REMOVED. REUSE

WHICH ARE TO BE REMOVED OR RECONNECTED. REMOVE INDICATED ITEMS AND ASSOCIATED

ITEMS NOT INDICATED BUT WHICH MUST BE REMOVED TO ACCOMMODATE REMODELING. SEE

CONDUITS WHERE POSSIBLE. DEMOLITION IS NOT INDICATED ON THE ELECTRICAL DRAWINGS.

5. REMOVE EXISTING FIRE ALARM DEVICES AND WIRING. THE CONTRACTOR MAY REUSE CONDUIT AND BOXES WHERE POSSIBLE FOR INSTALLATION OF NEW FIRE ALARM SYSTEM. SEE PROJECT

THE CONTRACTOR SHALL VISIT THE SITE AND SHALL BECOME FAMILIAR WITH EXISTING

6. SUBSCRIPT 'E' INDICATES AN EXISTING FIXTURE OR DEVICE TO REMAIN. MAINTAIN EXISTING

7. SUBSCRIPT 'R' INDICATES AN EXISTING FIXTURE OR DEVICE SCHEDULED FOR RELOCATION. REMOVE EXISTING FIXTURE OR DEVICE AND SALVAGE FOR REUSE. SEE NEW WORK PLANS

9. THE ELECTRICAL CONTRACTOR SHALL BE RESPONSIBLE FOR PATCHING, PAINTING, REPAIRING, AND REPLACEMENT OF ALL EXISTING WALLS, CEILING, FLOORS, OR OTHER BUILDING

ELEMENTS WHICH ARE DISTURBED AS PART OF THE DEMOLITION OR INSTALLATION OF NEW

ACT CEILING
OPEN CEILING

CEILING TYPE SCHEDULE

DESCRIPTION

GYP CEILING


BROTHER PC LABEL POLYESTER IDENTIFICATION TAG WITH CLEAR

—20 POINT RED HELVETICA FONT

ADHESIVE BACK


—DEVICE ADDRESS (NUMBER 01 THRU MAXIMUM NUMBER PER LOOP)

IT RACK (E)

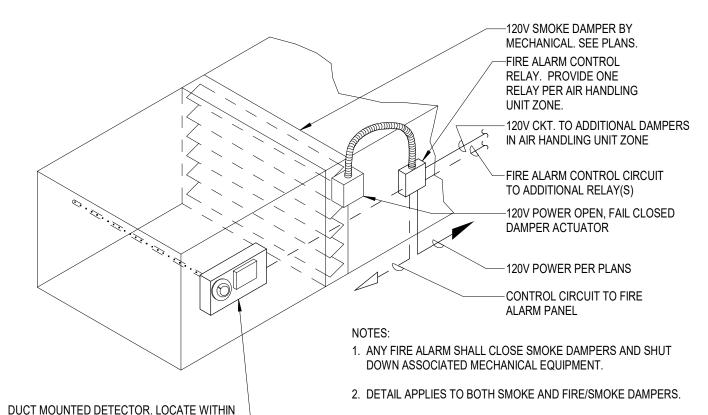

3 FIRE/SMOKE DAMPER CONNECTION DETAIL NOT TO SCALE

5'-0" OF SMOKE DAMPER PER IMC 607.3.3.2.

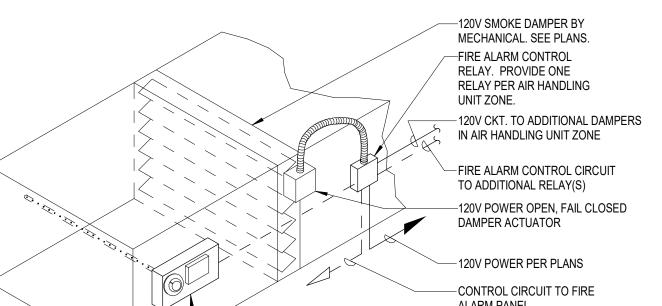

3. PROVIDE BREAKER LOCK AT PANEL FOR 120V CIRCUIT. 4. VERIFY AIR HANDLING UNIT ZONES WITH MECHANICAL. 5. CONNECT TO SPARE 20 AMP, 1 POLE, 120V FUSE IN NEAREST

LIFE SAFETY EMERGENCY PANEL.

6. QUANTITY OF UNITS CONNECTED PER CIRCUIT SHALL BE SUCH THAT VOLTAGE DROP DOES NOT EXCEED 2% TO ANY UNIT. VERIFY INPUT LOAD WITH MANUFACTURERS DATA.

<u>KEYNOTES</u> E105 PROVIDE ONE CAT 6 CABLE FROM NEW FIRE ALARM PANEL TO EXISTING IT RACK FOR IP DIALER COMMUNICATION. TERMINATE TO EXISTING E106 IP DIALER (ADJACENT TO FACP). REFER TO SPECIFICATIONS.

EXISTING FIBER OPTIC PATCH PANEL (TYP) —E106 NEW FACP IT WALL RACK (E) FACP (E) SIMPLEX 4100 SERIES (SHOWN FOR REFERENCE ONLY) -EXISTING 12 STRAND -EXISTING 12 STRAND SINGLEMODE FIBER SINGLEMODE FIBER BETWEEN BUILDINGS BETWEEN BUILDINGS

IT RACK (E)

5 FIRE ALARM CONNECTIVITY SCHEMATIC 12" = 1'-0"

FIRE ALARM DEVICE———

CIRCUIT NO.

2 DETECTOR LOCATION MARKER DETAIL NOT TO SCALE

0 OR 1 (0 FOR SENSOR, 1 FOR MODULE)

 $\overline{\mathbb{Z}}$

agency approval

2/2/2024

designed by: JRH drawn by: DGM


number:

KEYNOTES


E001 REMOVE EXISTING DEVICE AND ASSOCIATED WIRING COMPLETE.

N


N

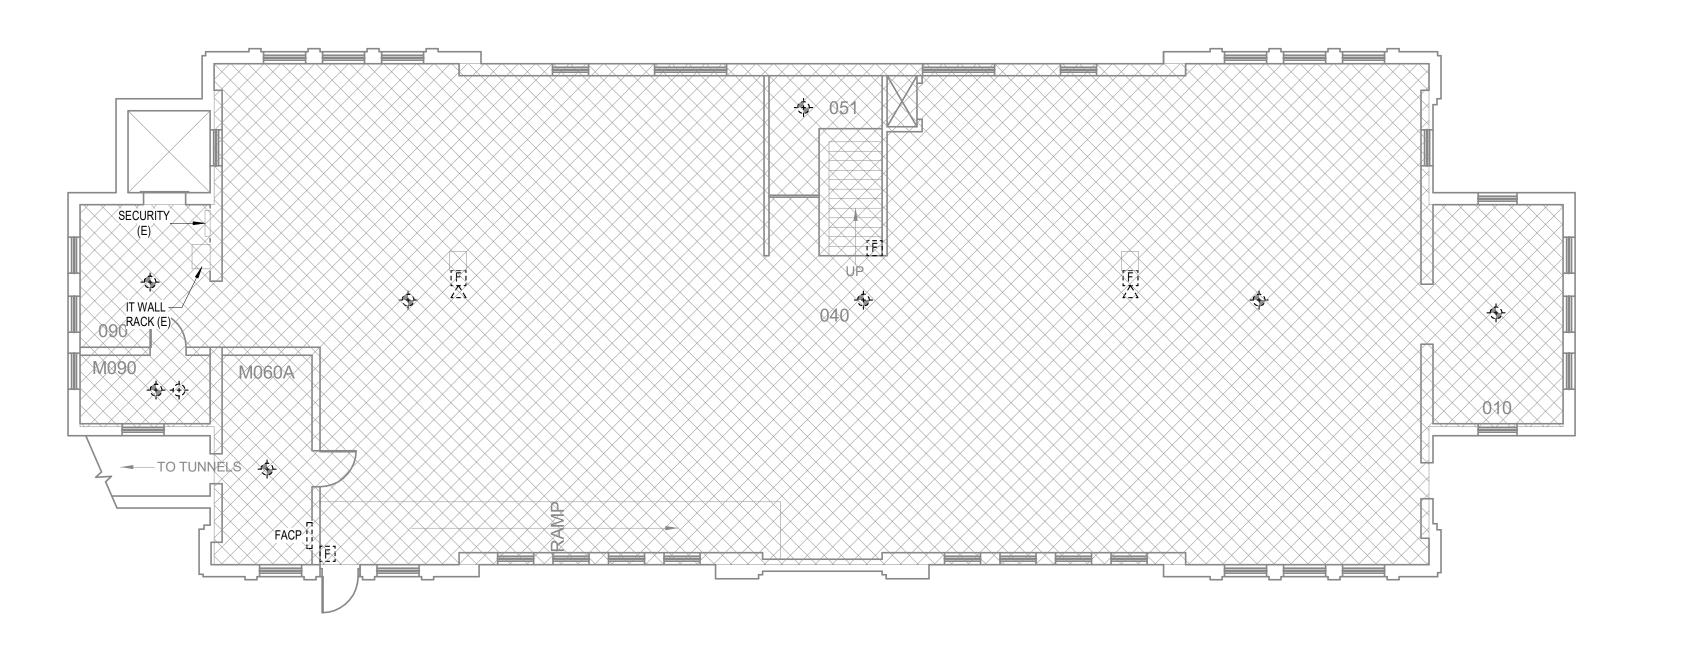

OUTREACH BUILDING - BASEMENT - FIRE ALARM DEMOLITION 1/8" = 1'-0"

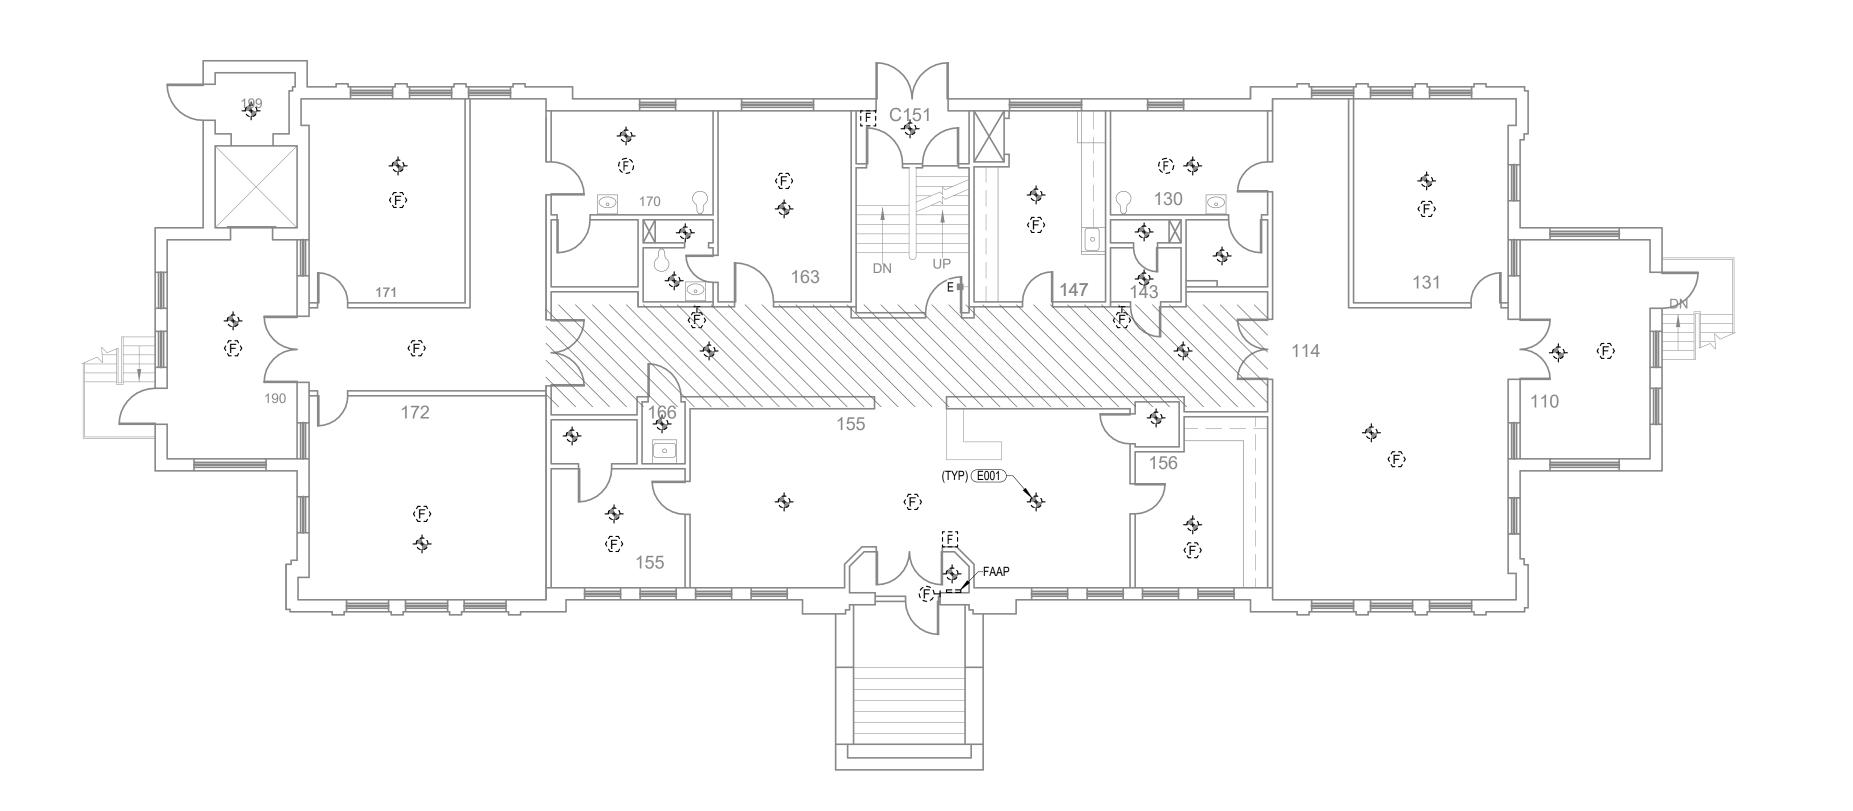

OUTREACH BUILDING - FIRST FLOOR - FIRE ALARM DEMOLITION
1/8" = 1'-0"

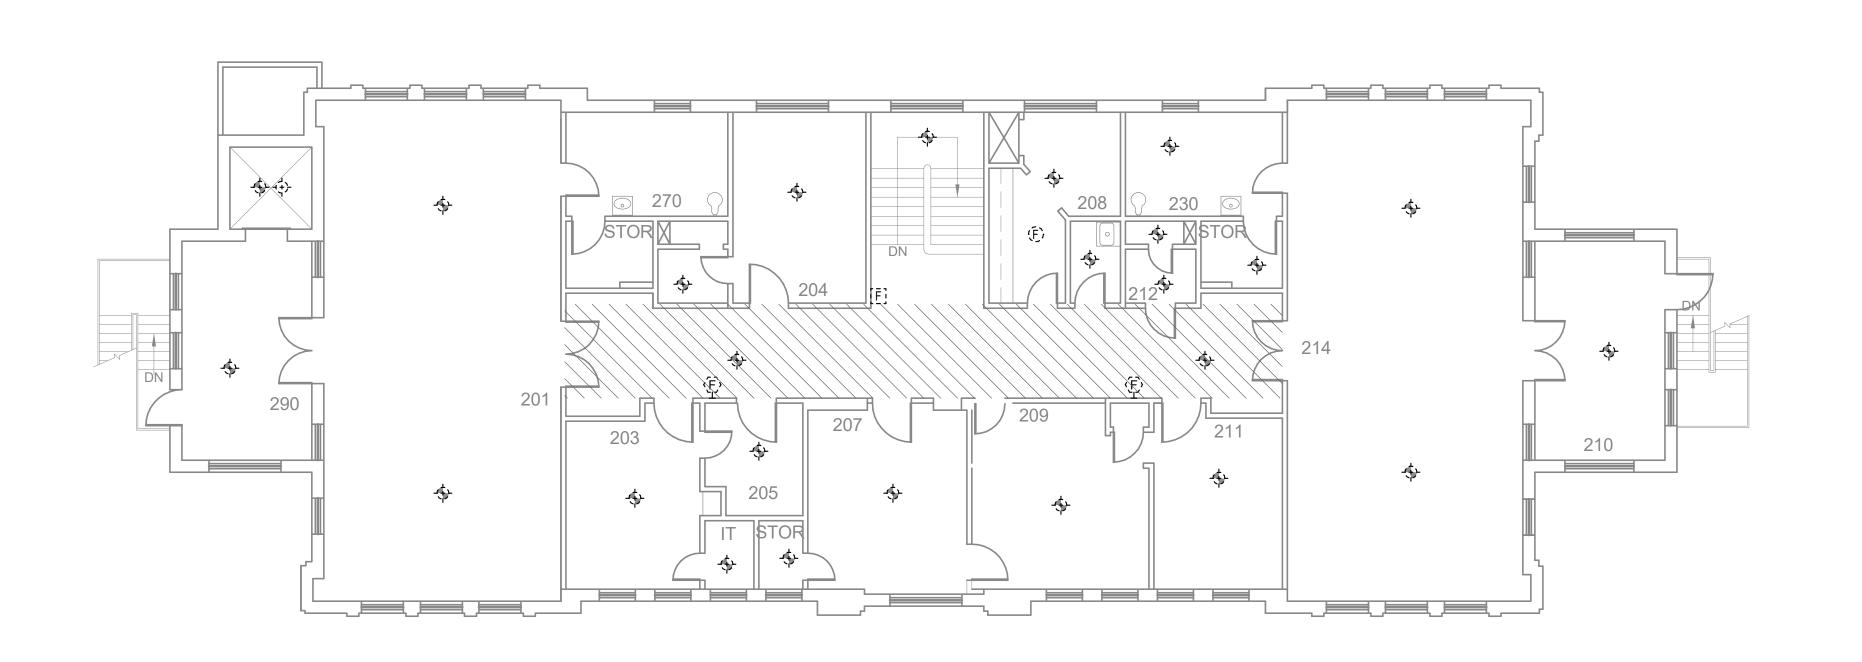

mechanical electrical lighting l technology I sustains 4940 North 118th Street Omaha, NE 68164 P: 402.491.4144 Nebraska COA Number: CA-0835 www.morrisseyengineering.com

PLANS

IOWA SCHOOL FOR THE DEAF

FIRE ALARM REPLACEMENT

agency approval

agency approval

date:	2/2/2024	
project number:	23266	
designed by:	JRH	
drawn by:	DGM	

sheet number:

M040 1 ELEMENTARY SCHOOL - BASEMENT - FIRE ALARM DEMOLTION 1/8" = 1'-0" IT RACK (E) C110 C122 2 ELEMENTARY SCHOOL - FIRST FLOOR - FIRE ALARM DEMOLITION 1/8" = 1'-0" 217 街

<u>KEYNOTES</u>

E001 REMOVE EXISTING DEVICE AND ASSOCIATED WIRING COMPLETE.

permission to reproduce all or part of this drawing is hereby granted solely for the limited purpose of construction of this project or archiving. unauthorized copying, disclosure or construction use without writte permission of morrissey engineering, inc. is prohibite by copyright law.

I sustainability

note:

do not scale drawings. verify all dimensions and clearances from architectural, structural, shop and other appropriate drawings or at site. lay out and clearances required for operation, maintenance, and codes and verify non-interference with other work. do not fabricate prior to verification of clearance for all trades.

engineering: morrisseyengineerings on www.morrisseyengineering.com

PLANS

IOWA SCHOOL FOR THE DEAF

FIRE ALARM REPLACEMENT

agency approval

agency approval

date: 2/2/2024


project 23266
number:

designed by: JRH

drawn by: DGM

sheet


ED201

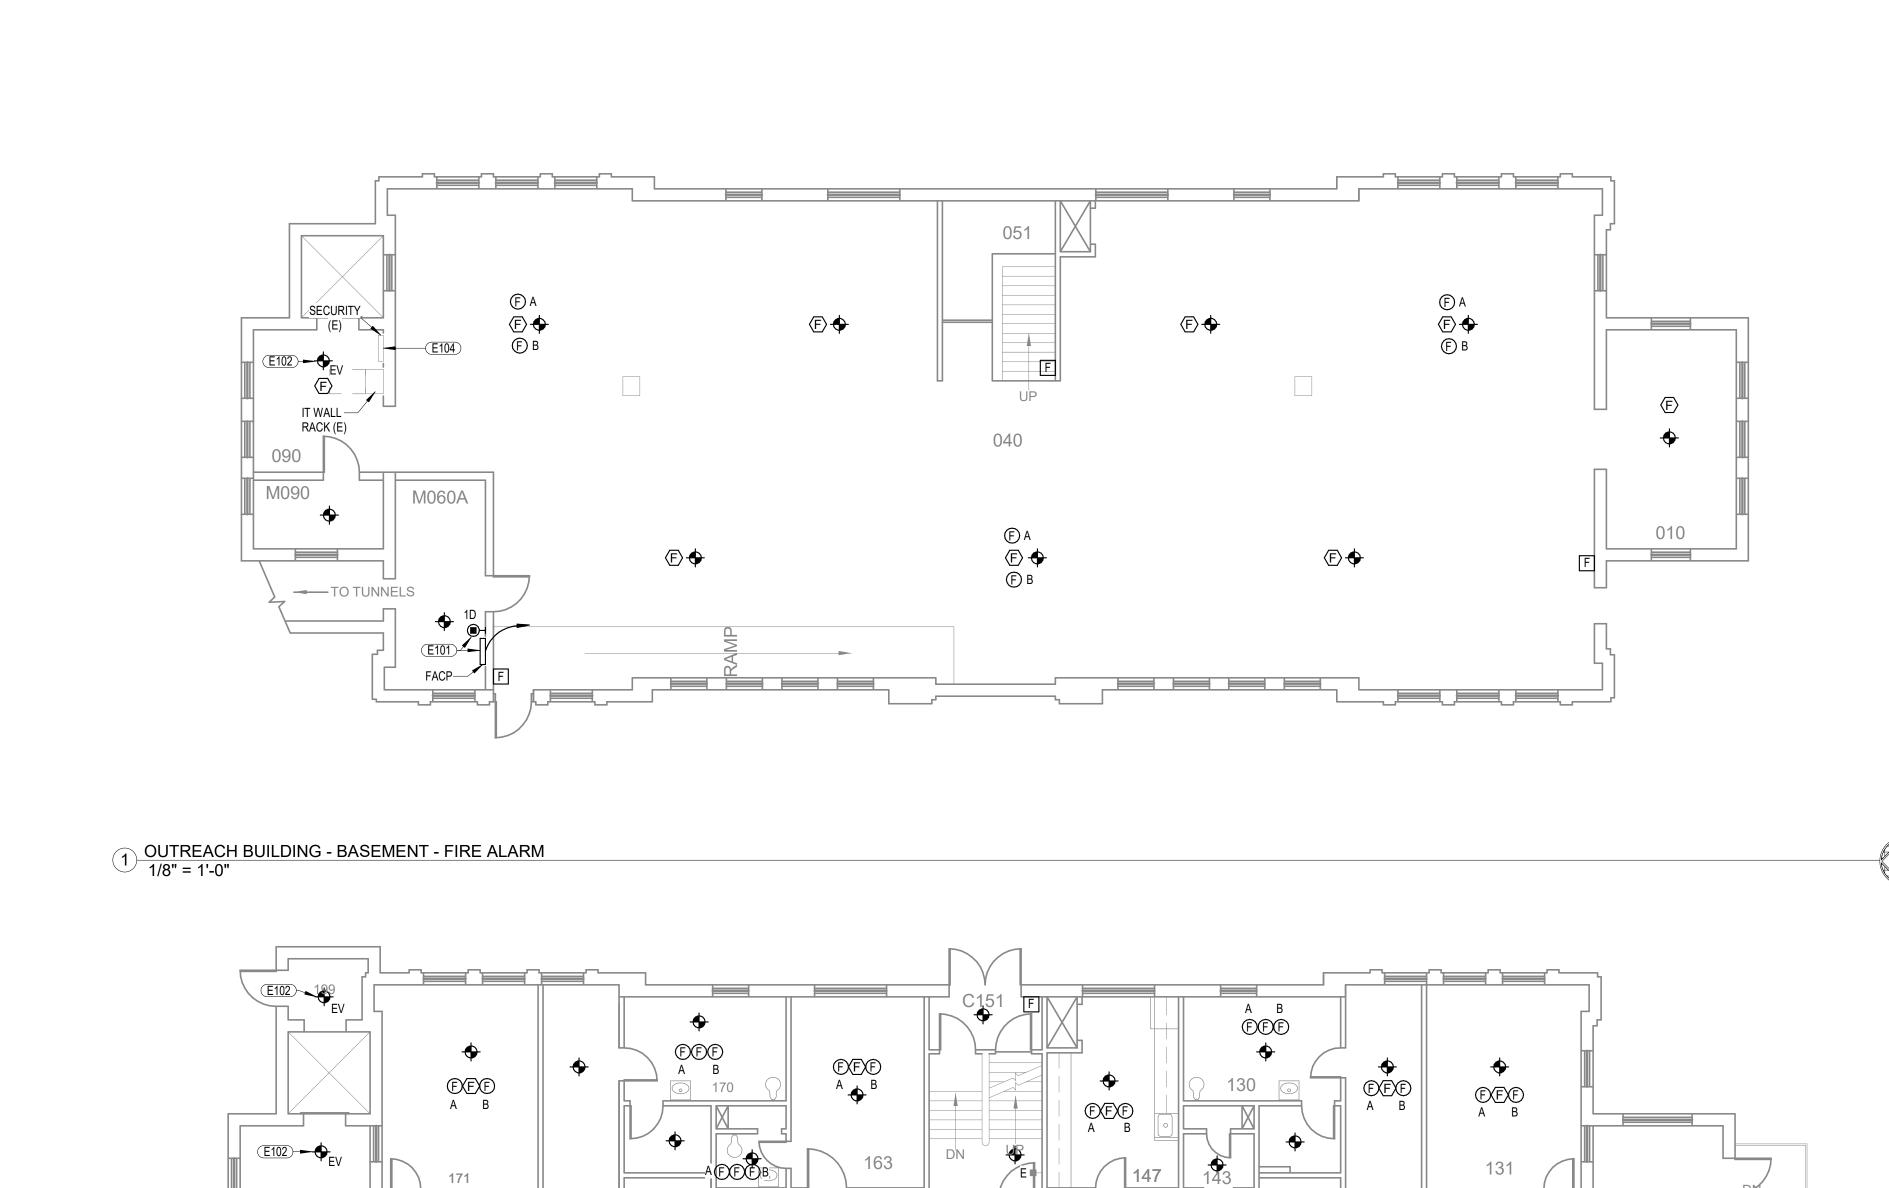

2 OUTREACH BUILDING - FIRST FLOOR - FIRE ALARM 1/8" = 1'-0"

A B E E E

A B EXE E 155

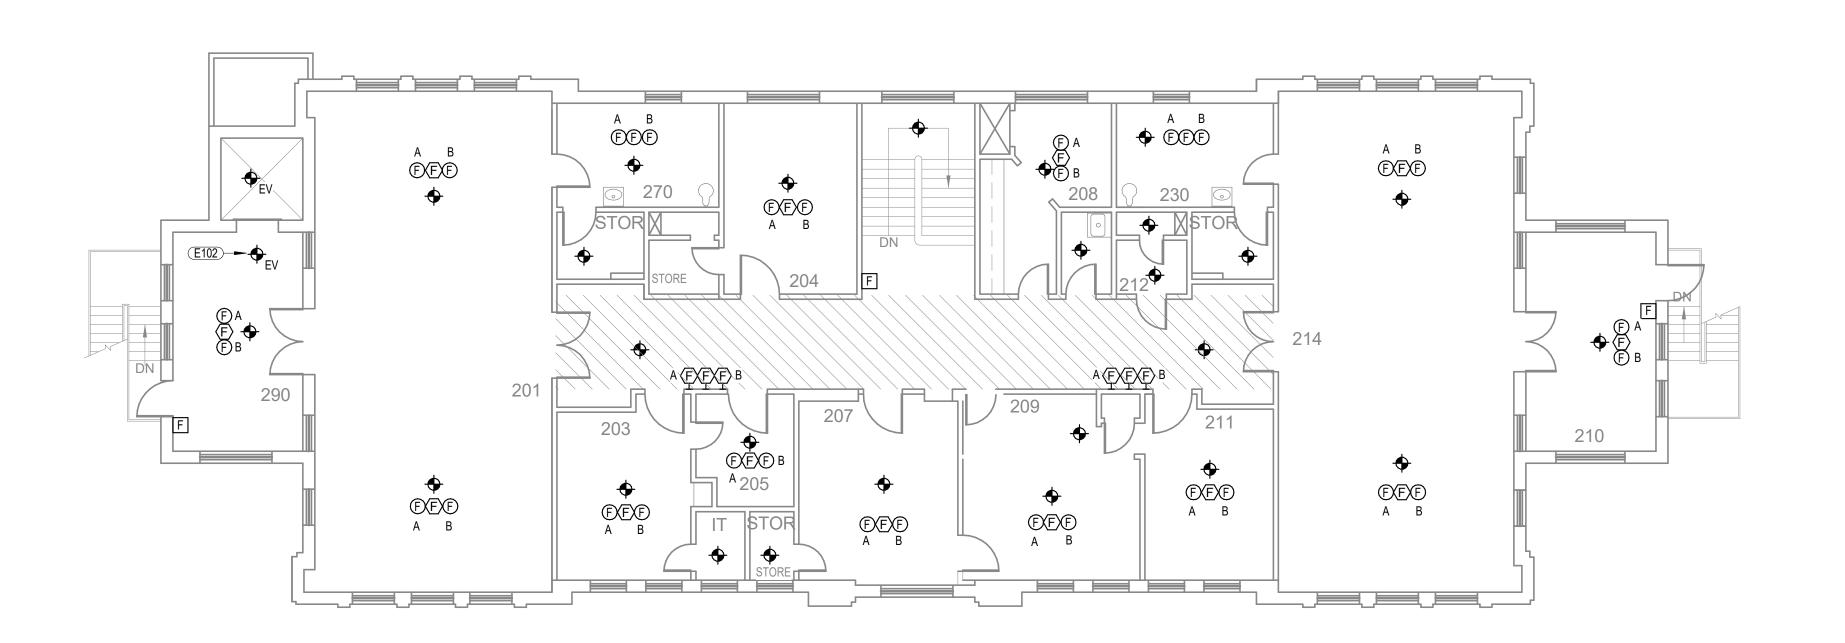


A B

KEYNOTES

- PROVIDE ONE CAT 6 DATA CABLE FROM FIRE ALARM CONTROL PANEL TO IT NETWORK FOR CONNECTION TO IP DIALER. COORDINATE DIALER CONNECTIONS AND NETWORK CONFIGURATIONS WITH OWNER'S IT
- REPRESENTATIVE.
- E102 LABEL 'EV' DENOTES CONNECTION TO ELEVATOR RECALL SYSTEM. PROGRAM FIRE ALARM SYSTEM TO INITIATE ELEVATOR RECALL UPON SMOKE DETECTION. DETECTORS AT LANDINGS SHALL CAUSE THE ELEVATOR TO RETURN TO AN ALTERNATE LEVEL. DESIGNATED AND ALTERNATE LEVELS TO BE DETEREMINED BY THE ELEVATOR INSPECTOR AND FIRE MARSHAL.
- E104 COORDINATE FIRE ALARM WITH ACCESS CONTROL SYSTEM TO RELEASE DOORS UPON ACTIVATION OF FIRE ALARM SYSTEM. COORDINATE REQUIREMENTS WITH AHJ.

III

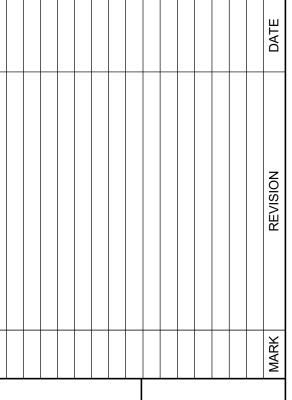

ARM BUILDING OUTREACH

THE DEAF ACEMENT

SCHOOL FOR STANKE ALARM REPLA

IOWA FIRE

agency approval


2/2/2024 designed by: JRH

drawn by: DGM number:


3 OUTREACH BUILDING - SECOND FLOOR - FIRE ALARM 1/8" = 1'-0"

N


N

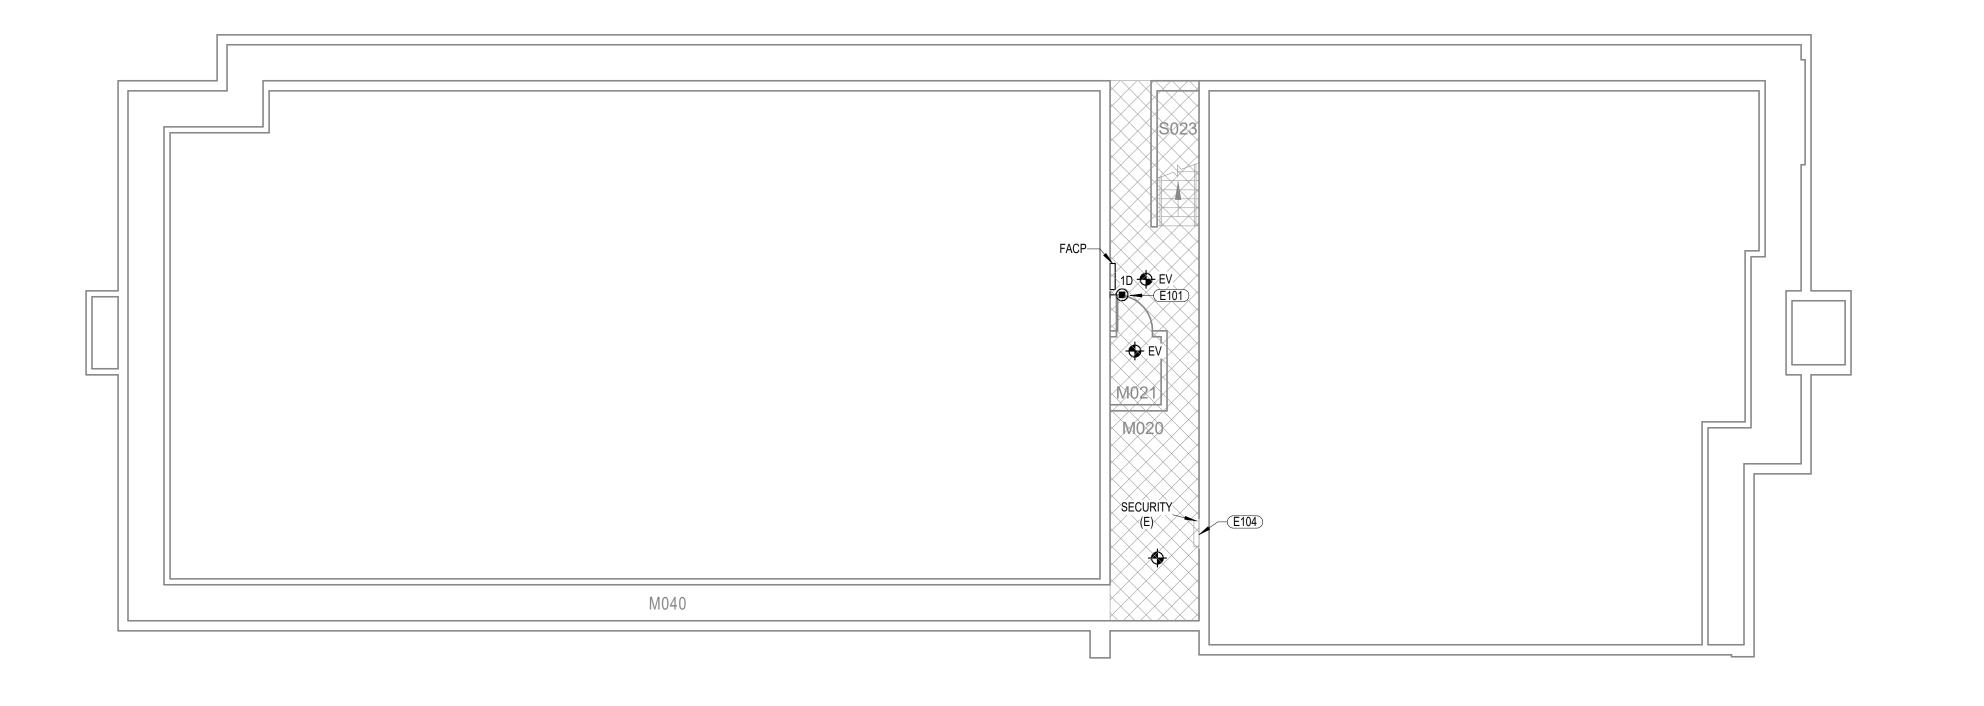

1 ELEMENTARY SCHOOL - BASEMENT - FIRE ALARM 1/8" = 1'-0"

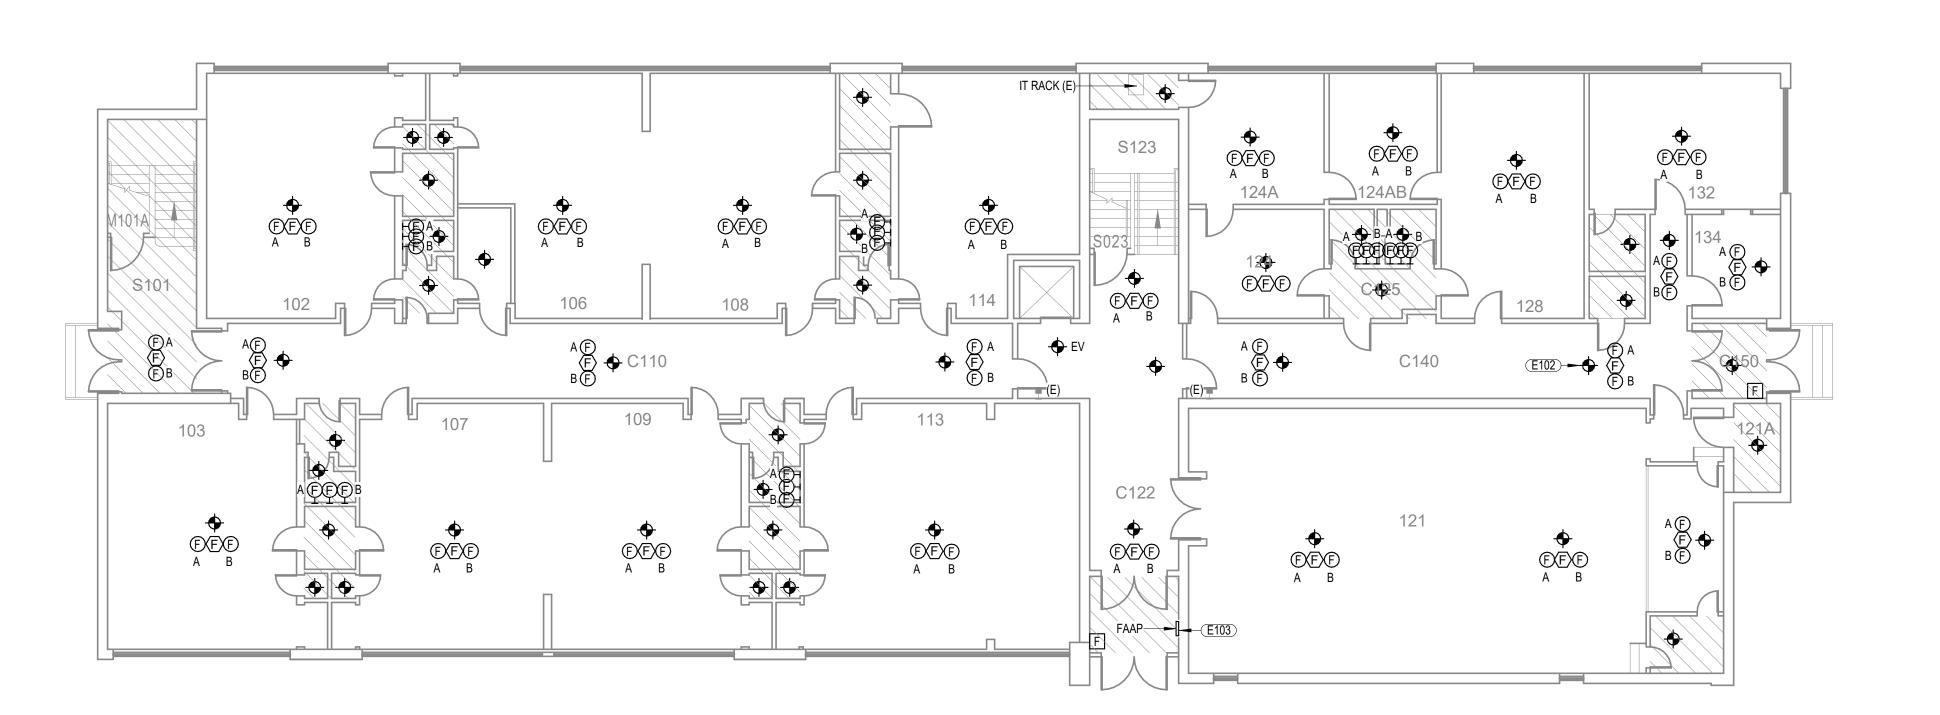

2 ELEMENTARY SCHOOL - FIRST FLOOR - FIRE ALARM 1/8" = 1'-0"

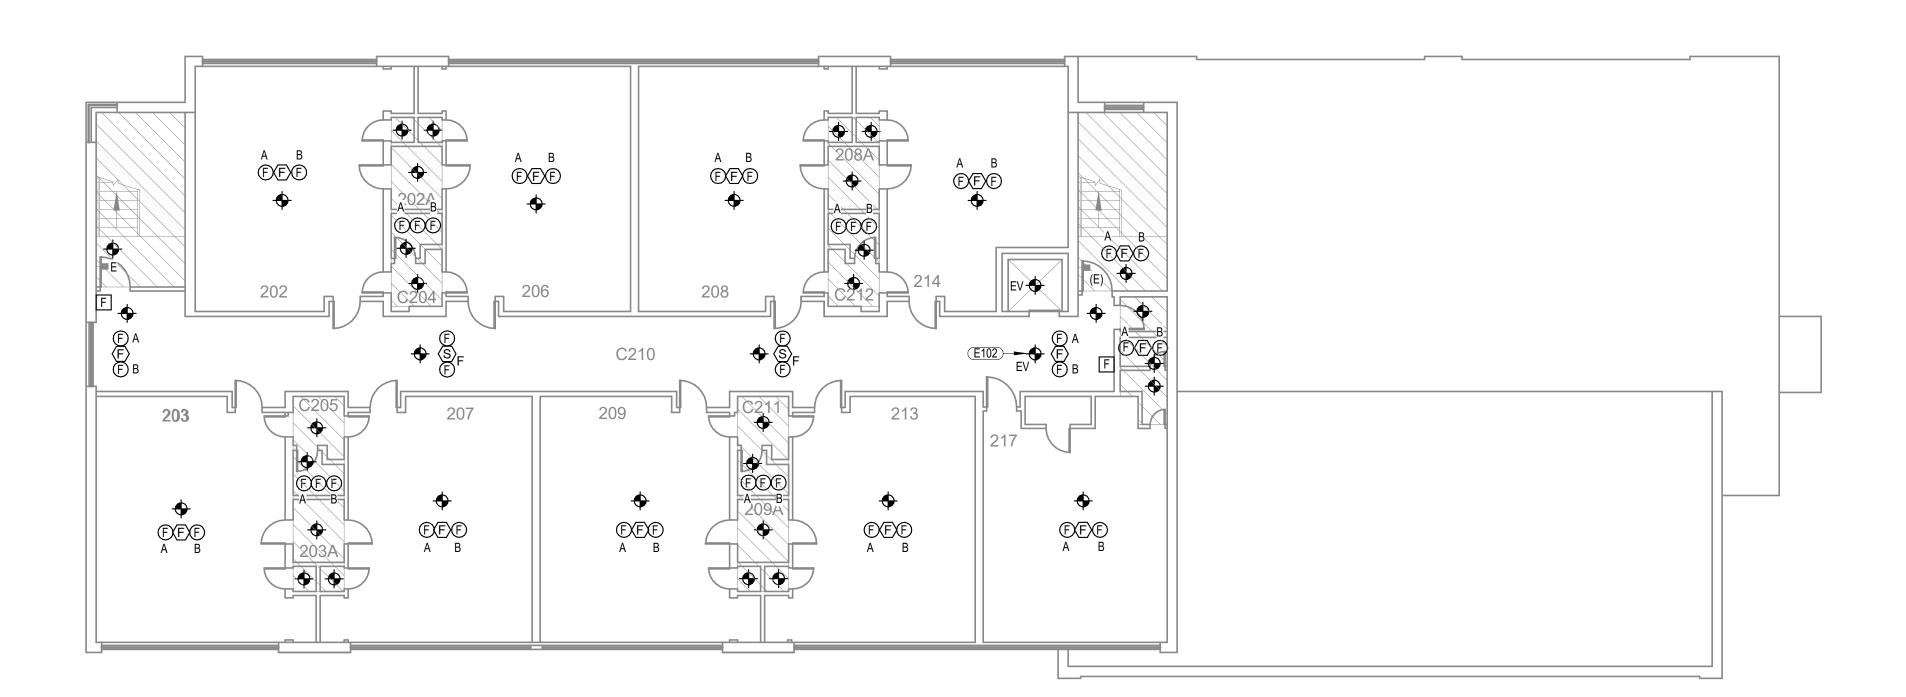

KEYNOTES

- E101 PROVIDE ONE CAT 6 DATA CABLE FROM FIRE ALARM CONTROL PANEL TO IT NETWORK FOR CONNECTION TO IP DIALER. COORDINATE DIALER CONNECTIONS AND NETWORK CONFIGURATIONS WITH OWNER'S IT REPRESENTATIVE.
- E102 LABEL 'EV' DENOTES CONNECTION TO ELEVATOR RECALL SYSTEM. PROGRAM FIRE ALARM SYSTEM TO INITIATE ELEVATOR RECALL UPON SMOKE DETECTION. DETECTORS AT LANDINGS SHALL CAUSE THE ELEVATOR TO RETURN TO AN ALTERNATE LEVEL. DESIGNATED AND ALTERNATE LEVELS TO BE DETEREMINED BY THE ELEVATOR INSPECTOR AND FIRE MARSHAL.

 E103 PROVIDE NEW FIRE ALARM ANNUNCIATOR AT LOCATION OF OLD FIRE ALARM
- PANEL. PATCH / REPAIR / PAINT WALL SURFACE WHERE OLD PANEL WAS LOCATED.


 E104 COORDINATE FIRE ALARM WITH ACCESS CONTROL SYSTEM TO RELEASE DOORS UPON ACTIVATION OF FIRE ALARM SYSTEM. COORDINATE REQUIREMENTS WITH AHJ.

©copyright
permission to reproduce all or part of this drawir hereby granted solely for the limited purpose of construction of this project or archiving, unauthocopying, disclosure or construction use without v permission of morrissey engineering, inc. is proby copyright law.

note:

do not scale drawings. verify all dimensions and clearances from architectural, structural, shop a other appropriate drawings or at site. Iay out an coordinate all work prior to installation to provide clearances required for operation, maintenance and codes and verify non-interference with othe work. do not fabricate prior to verification of clearance for all trades.

Engineering Incorporation of the corporation of the

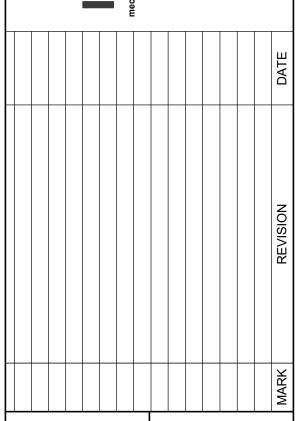

ELEMENTARY SCHOOL - FIRE ALARM PLA
IOWA SCHOOL FOR THE DEAF
FIRE ALARM REPLACEMENT

agency approval

date: 2/2/2024

project 23266

designed by: JRH

drawn by: DGM sheet

E201