


# DAS CC IDALS HOOVER 5TH FLOOR RENOVATION

DES MOINES, IOWA


DAS PROJECT #9426.00

RFP: 942600-01

ISG PROJECT # 24-31954

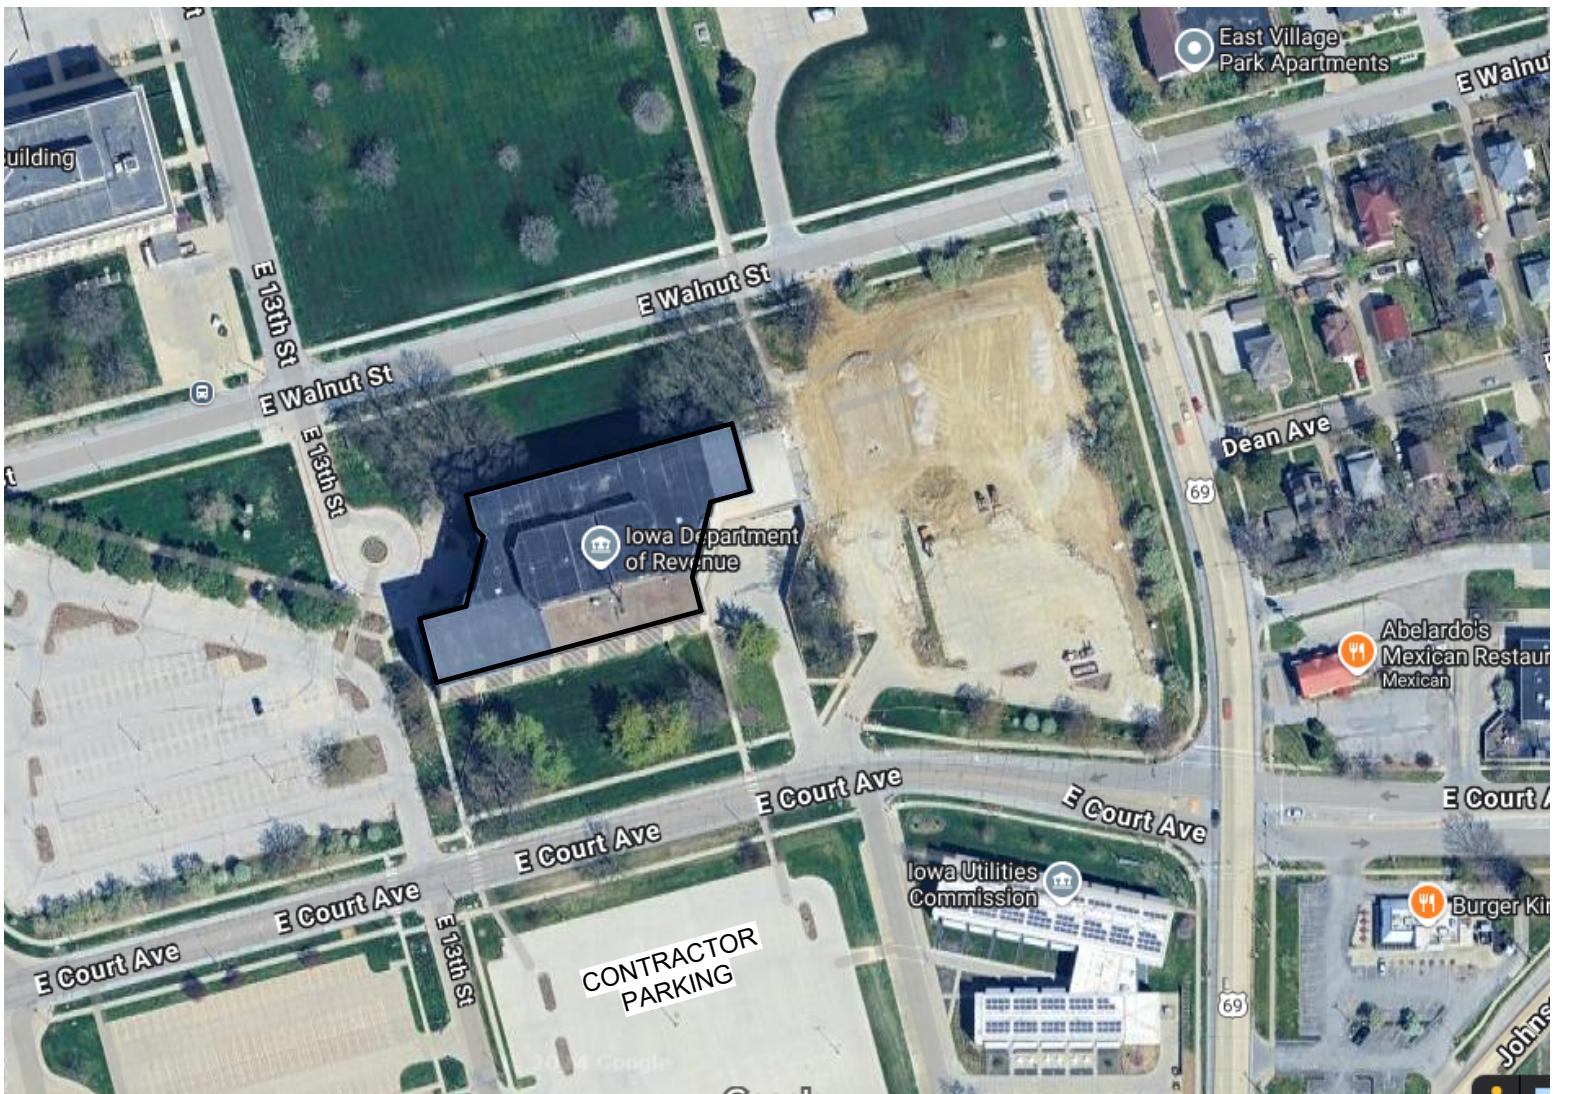

VICINITY MAP

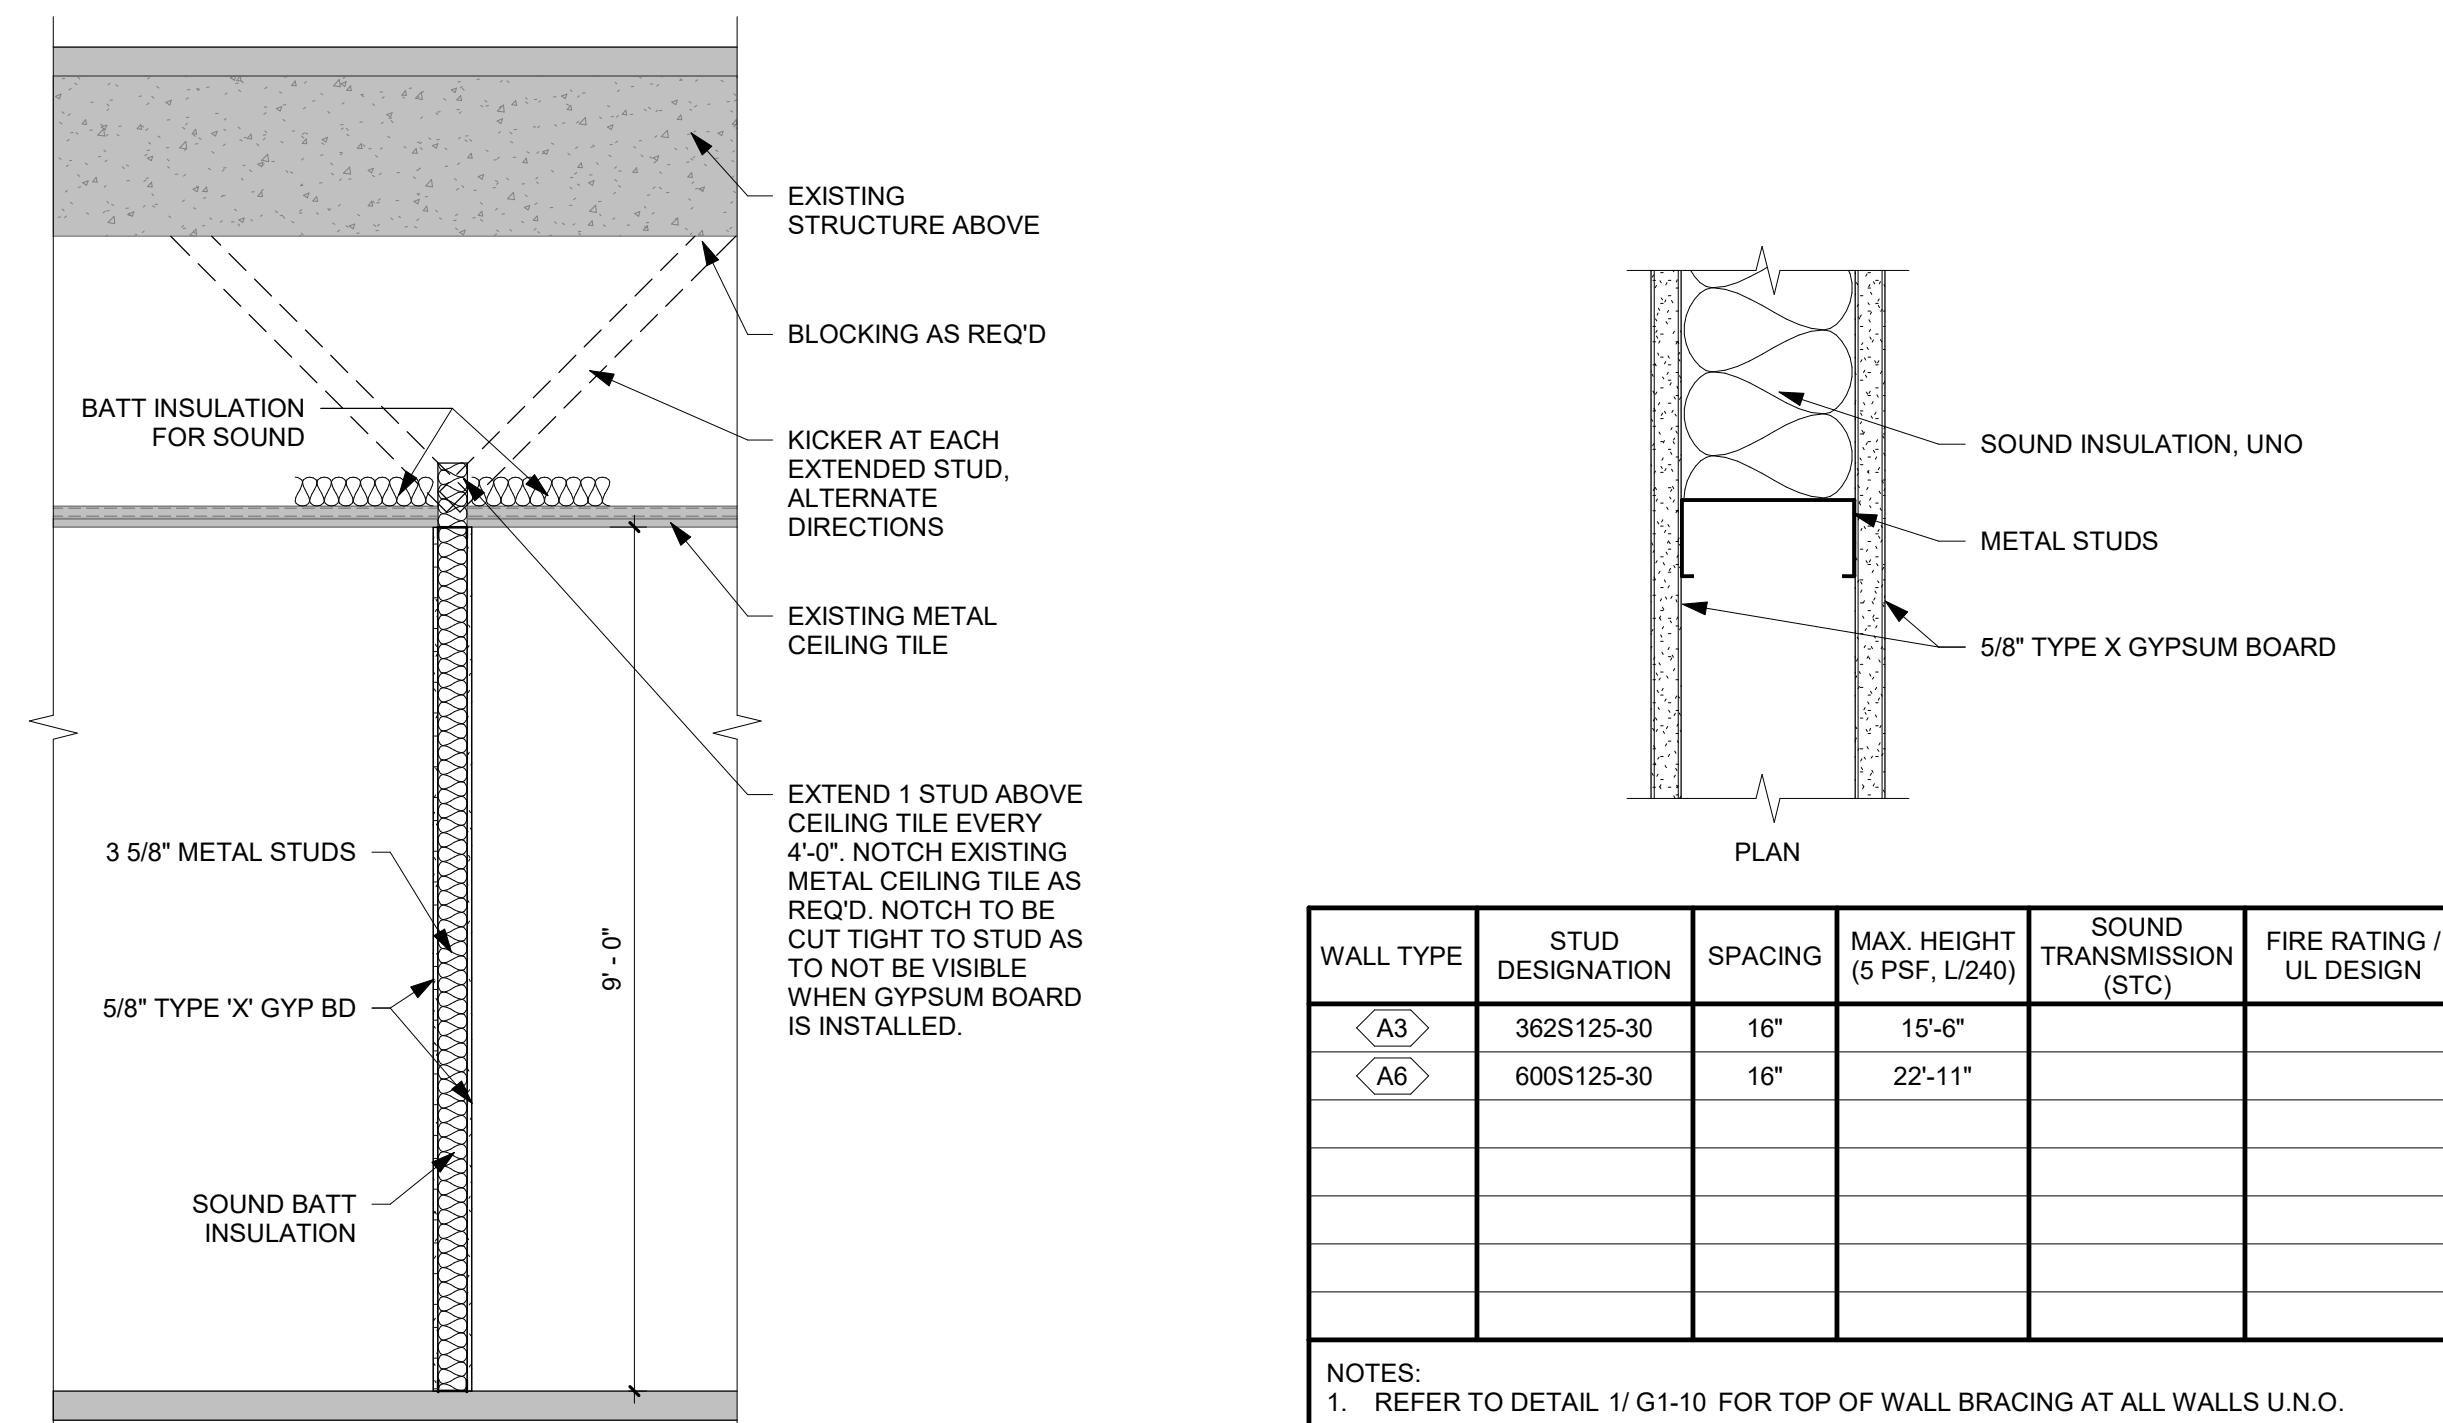

TYPICAL WALL CONNECTION TO EXISTING STRUCTURE  
1/2" = 1'-0"

(A) WALL TYPE A (METAL STUD PARTITION)

## PROJECT INDEX:

OWNER:  IOWA DEPT OF ADMINISTRATIVE SERVICES MICHAEL BRADBURY 1305 EAST WALNUT STREET DES MOINES, IOWA 50319 PHONE # FAX #	PROJECT ADDRESS:  HOOVER STATE OFFICE BUILDING 1305 EAST WALNUT STREET DES MOINES, IOWA 50319	MANAGING OFFICE:  ISG  DES MOINES OFFICE 217 EAST 2ND STREET SUITE 110 DES MOINES, IOWA 50309 PHONE: 515.243.9143 PROJECT MANAGER: PYLAR EATON EMAIL: PYLAR.EATON@ISGINC.COM
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REFERENCE SCALE  
1" = 1'-0"  
0 1/4" 1/2" 1" 2"

12/25/2025 3:21:56 PM

ISG

SHEET INDEX	
SHEET #	SHEET TITLE
GENERAL	
G1-10	TITLE SHEET, SHEET INDEX, PROJECT GENERAL NOTES
G1-21	CODE DATA AND CODE DATA PLAN
ARCHITECTURAL	
A1-11	LEVEL 5 DEMOLITION PLAN
A1-21	LEVEL 5 FLOOR PLAN
A1-31	LEVEL 5 REFLECTED CEILING PLAN AND DETAILS
A1-41	LEVEL 5 FINISH PLAN & SCHEDULE
PLUMBING	
MP0-01	DIV 21.2.23 SYMBOLS / ABBREVIATIONS
P1-11	FIFTH FLOOR PLUMBING DEMOLITION PLAN
P2-10	FOURTH FLOOR PLUMBING PLAN
P2-11	FIFTH FLOOR PLUMBING PLAN
P6-11	PLUMBING ISOMETRICS, DETAILS, SCHEDULES, AND SPECIFICATIONS
FIRE PROTECTION	
FP2-11	FIFTH FLOOR FIRE PROTECTION PLAN
MECHANICAL	
M1-11	FIFTH FLOOR MECHANICAL DEMOLITION PLAN
M2-11	FIFTH FLOOR MECHANICAL PLAN
M4-11	MECHANICAL DETAILS
M5-11	MECHANICAL SCHEDULES AND SPECIFICATIONS
ELECTRICAL	
E1-11	LEVEL 5 ELECTRICAL DEMOLITION PLAN
E2-11	LEVEL 5 POWER AND FIRE ALARM PLAN
E2-12	LEVEL 5 POWER DEVICE DIMENSIONS
E2-21	LEVEL 5 LIGHTING PLAN
E4-10	ELECTRICAL SYMBOLS, SCHEDULES, AND DETAILS
TECHNOLOGY	
T2-11	FIFTH FLOOR TECHNOLOGY PLAN
T2-21	LEVEL 5 SOUND MASKING FLOOR PLAN
T3-11	TECHNOLOGY ENLARGEMENTS AND DETAILS
T6-11	TECHNOLOGY DETAILS, RISERS, AND MATERIAL SCHEDULES
BID ALTERNATES:	
BID ALTERNATE #1	<ul style="list-style-type: none"> <li>BASE BID: NO SOUND MASKING IN WORK AREA.</li> <li>BID ALTERNATE: INSTALL SOUND MASKING IN WORK AREA.</li> </ul>
BID ALTERNATE #2	<ul style="list-style-type: none"> <li>BASE BID: REUSE EXISTING THERMOSTATS.</li> <li>BID ALTERNATE: REPLACE THERMOSTATS AS IDENTIFIED IN DRAWINGS.</li> </ul>
REFER TO ASSOCIATED PLANS FOR MORE INFORMATION ON EACH ALTERNATE.	

PROJECT GENERAL NOTES					
A. ALL WORK SHALL CONFORM TO THE CONTRACT DOCUMENTS WHICH INCLUDE, BUT ARE NOT LIMITED TO, THE OWNER-CONTRACTOR AGREEMENT, THE PROJECT MANUAL (WHICH INCLUDES GENERAL AND SUPPLEMENTARY CONDITIONS AND SPECIFICATIONS), DRAWINGS OF ALL DISCIPLINES AND ALL ADDITIONAL MODIFICATIONS AND CLARIFICATIONS ISSUED BY THE ARCHITECT/ENGINEER.					
B. CONTRACT DOCUMENTS SHALL BE ISSUED TO ALL SUBCONTRACTORS BY THE PRIME CONTRACTOR IN COMPLETE SETS IN ORDER TO ACHIEVE THE FULL EXTENT AND COMPLETE COORDINATION OF ALL WORK. CONTRACTOR IS RESPONSIBLE FOR COORDINATING AND CORRELATING QUANTITIES AND DIMENSIONS.					
C. WRITTEN DIMENSIONS TAKE PRIORITY OVER SCALED DIMENSIONS. NOTIFY ARCHITECT/ENGINEER OF ANY DISCREPANCIES OR CONDITIONS REQUIRING INFORMATION OR CLARIFICATION BEFORE PROCEEDING WITH THE WORK.					
D. FIELD VERIFICATION OF EXISTING CONDITIONS AND DIMENSIONS. NOTIFY ARCHITECT/ENGINEER OF ANY DISCREPANCIES OR CONDITIONS REQUIRING INFORMATION OR CLARIFICATION BEFORE PROCEEDING WITH THE WORK.					
E. DETAILS SHOWN ARE INTENDED TO BE INDICATIVE OF THE PROFILES AND TYPE OF DETAILING REQUIRED THROUGHOUT THE WORK. DETAILS NOT SHOWN ARE SIMILAR TO THOSE SHOWN. WHERE SPECIFIC DIMENSIONS, DETAILS OR DESIGN INTENT CANNOT BE DETERMINED, NOTIFY ARCHITECT/ENGINEER BEFORE PROCEEDING WITH THE WORK.					
F. ALL MANUFACTURED ARTICLES, MATERIALS AND EQUIPMENT SHALL BE APPLIED, INSTALLED, CONNECTED, ERECTED, ADDED AND CONDITIONED ACCORDING TO MANUFACTURER'S INSTRUCTIONS. IN CASE OF CONFLICTS BETWEEN MANUFACTURER'S INSTRUCTIONS AND THE CONTRACT DOCUMENTS, NOTIFY ARCHITECT/ENGINEER BEFORE PROCEEDING WITH THE WORK.					
G. LARGE-SCALE, MORE SPECIFIC DETAILS TAKE PRIORITY OVER SMALLER-SCALE, LESS SPECIFIC DETAILS AND INFORMATION. MAKE PRIORITY OVER LESS STRINGENT REQUIREMENTS. NOTIFY ARCHITECT/ENGINEER OF ANY DISCREPANCIES OR CONDITIONS REQUIRING INFORMATION OR CLARIFICATION BEFORE PROCEEDING WITH THE WORK.					
H. PROVIDE CONTINUOUS SEALANT AROUND ALL MATERIALS AT ALL INTERIOR AND EXTERIOR WALL PENETRATIONS. REFER TO SPECIFICATIONS FOR APPROPRIATE SEALANT.					
I. ALL DISSIMILAR METALS SHALL BE EFFECTIVELY ISOLATED FROM EACH OTHER TO AVOID GALVANIC CORROSION.					
J. SEAL ALL OPENINGS IN WALLS, FLOORS, CEILINGS, AND ROOFS AROUND DUCTS, PIPES, CONDUITS, TRUNKS, CONDUIT AND ALL OTHER PENETRATIONS WITH FIRE STOPPING AS SPECIFIED AND REQUIRED BY CODES. IF FIRE STOPPING IS NOT REQUIRED AT PENETRATIONS PER CODE, SEAL WITH CONTINUOUS SEALANT.					
K. PROVIDE TEMPORARY WALLS, ENCLOSURES, DUST SHIELDS AND WALK-OFF MATS AS REQUIRED FOR SEPARATE DEMOLITION AND CONSTRUCTION FROM EXISTING BUILDINGS.					
L. PROVIDE BRACING AND SHORING AS REQUIRED TO PROTECT EXISTING STRUCTURE TO REMAIN. PROVIDE SECURE AND WEATHERPROOF ENCLOSURE OF TEMPORARY OPENINGS IN EXTERIOR WALLS TO EJECT ALL BUILDING CONSTRUCTION MATERIALS AND TO PROTECT EXISTING CONSTRUCTION.					
M. RESTORE ALL EXISTING AREAS AFFECTED BY DEMOLITION AND RELATED NEW CONSTRUCTION TO THEIR ORIGINAL CONDITION, INCLUDING BUT NOT LIMITED TO WALLS, FLOORS, AND CEILINGS AND THEIR ASSOCIATED FINISHES.					
N. PROVIDE SOLID WALL BACKING WITH METAL OR FIRE-RETARDANT WOOD BOARDING BEHIND DOOR HARDWARE SUCH AS WALL STOPS, BUMPERS, HOLD OPENS, ETC. AND AT ALL ITEMS REQUIRING FASTENING THROUGH GYPSUM BD. TO BLOCKING.					
O. RENDERED IMAGES MAY NOT BE AN ACCURATE REPRESENTATION OF BUILDING CONDITIONS. REFER TO PLANS AND DETAILS CONTAINED WITHIN FOR SCOPE OF WORK.					

SEAL	ISG
I HEREBY CERTIFY THAT THE PORTION OF THIS TECHNICAL SUBMISSION DESCRIBED BELOW WAS PREPARED BY ME OR UNDER MY DIRECT SUPERVISION AND RESPONSIBLE CHARGE. I AM A DULY LICENSED ARCHITECT UNDER THE LAWS OF THE STATE OF IOWA.	
Erica Schaefer 01/21/2025	
SIGNATURE	
ERICA M. SCHAEFER	
PRINTED SIGNATURE	
07376 06/30/2026	
LICENSE NUMBER LICENSE RENEWAL DATE	
SHEETS COVERED BY THIS SEAL:	
G1-10 A1-11	
G1-21 A1-21	
A1-31	
A1-41	

SEAL	ISG
I HEREBY CERTIFY THAT THE PORTION OF THIS TECHNICAL SUBMISSION DESCRIBED BELOW WAS PREPARED BY ME OR UNDER MY DIRECT SUPERVISION AND RESPONSIBLE CHARGE. I AM A DULY LICENSED ENGINEER UNDER THE LAWS OF THE STATE OF IOWA.	
Brett Walker 01/21/2025	
SIGNATURE	
BRETT WALKER	
PRINTED SIGNATURE	
P28162 12/31/2026	
LICENSE NUMBER LICENSE RENEWAL DATE	
SHEETS COVERED BY THIS SEAL:	
A1-31	

SEAL	ISG
I HEREBY CERTIFY THAT THE PORTION OF THIS TECHNICAL SUBMISSION DESCRIBED BELOW WAS PREPARED BY ME OR UNDER MY DIRECT SUPERVISION AND RESPONSIBLE CHARGE. I AM A DULY LICENSED ENGINEER UNDER THE LAWS OF THE STATE OF IOWA.	
Adam W. Puls 01/21/2025	
SIGNATURE	
ADAM W. PULS	
PRINTED SIGNATURE	
P23206 12/31/2025	
LICENSE NUMBER LICENSE RENEWAL DATE	
SHEETS COVERED BY THIS SEAL:	
MP0-01 P1-11 FP2-11 M1-11	
P2-10 M2-11	
P2-11 M4-11	
P6-11 M5-11	

SEAL	ISG
I HEREBY CERTIFY THAT THE PORTION OF THIS TECHNICAL SUBMISSION DESCRIBED BELOW WAS PREPARED BY ME OR UNDER MY DIRECT SUPERVISION AND RESPONSIBLE CHARGE. I AM A DULY LICENSED ENGINEER UNDER THE LAWS OF THE STATE OF IOWA.	
Royal Streed 01/21/2025	
SIGNATURE	
ROYAL STREED	
PRINTED SIGNATURE	
P26593 12/31/2026	
LICENSE NUMBER LICENSE RENEWAL DATE	
SHEETS COVERED BY THIS SEAL:	
E1-11 E4-10 T2-11	
E2-11 T2-21	
E2-12 T3-11	
E2-21 T6-11	

## DAS CC IDALS HOOVER 5TH FLOOR RENOVATION



DES MOINES IOWA

REVISION SCHEDULE
DATE
DESCRIPTION
BY

PROJECT NO. 24-31954  
FILE NAME  
DRAWN BY KKT  
DESIGNED BY KKT  
REVIEWED BY EMS  
ORIGINAL ISSUE DATE 01/21/2025  
CLIENT PROJECT NO. 9426.00

TITLE  
TITLE SHEET,  
SHEET INDEX,  
PROJECT  
GENERAL NOTES  
SHEET  
G1-10

0 1/4" 1/2" 1"

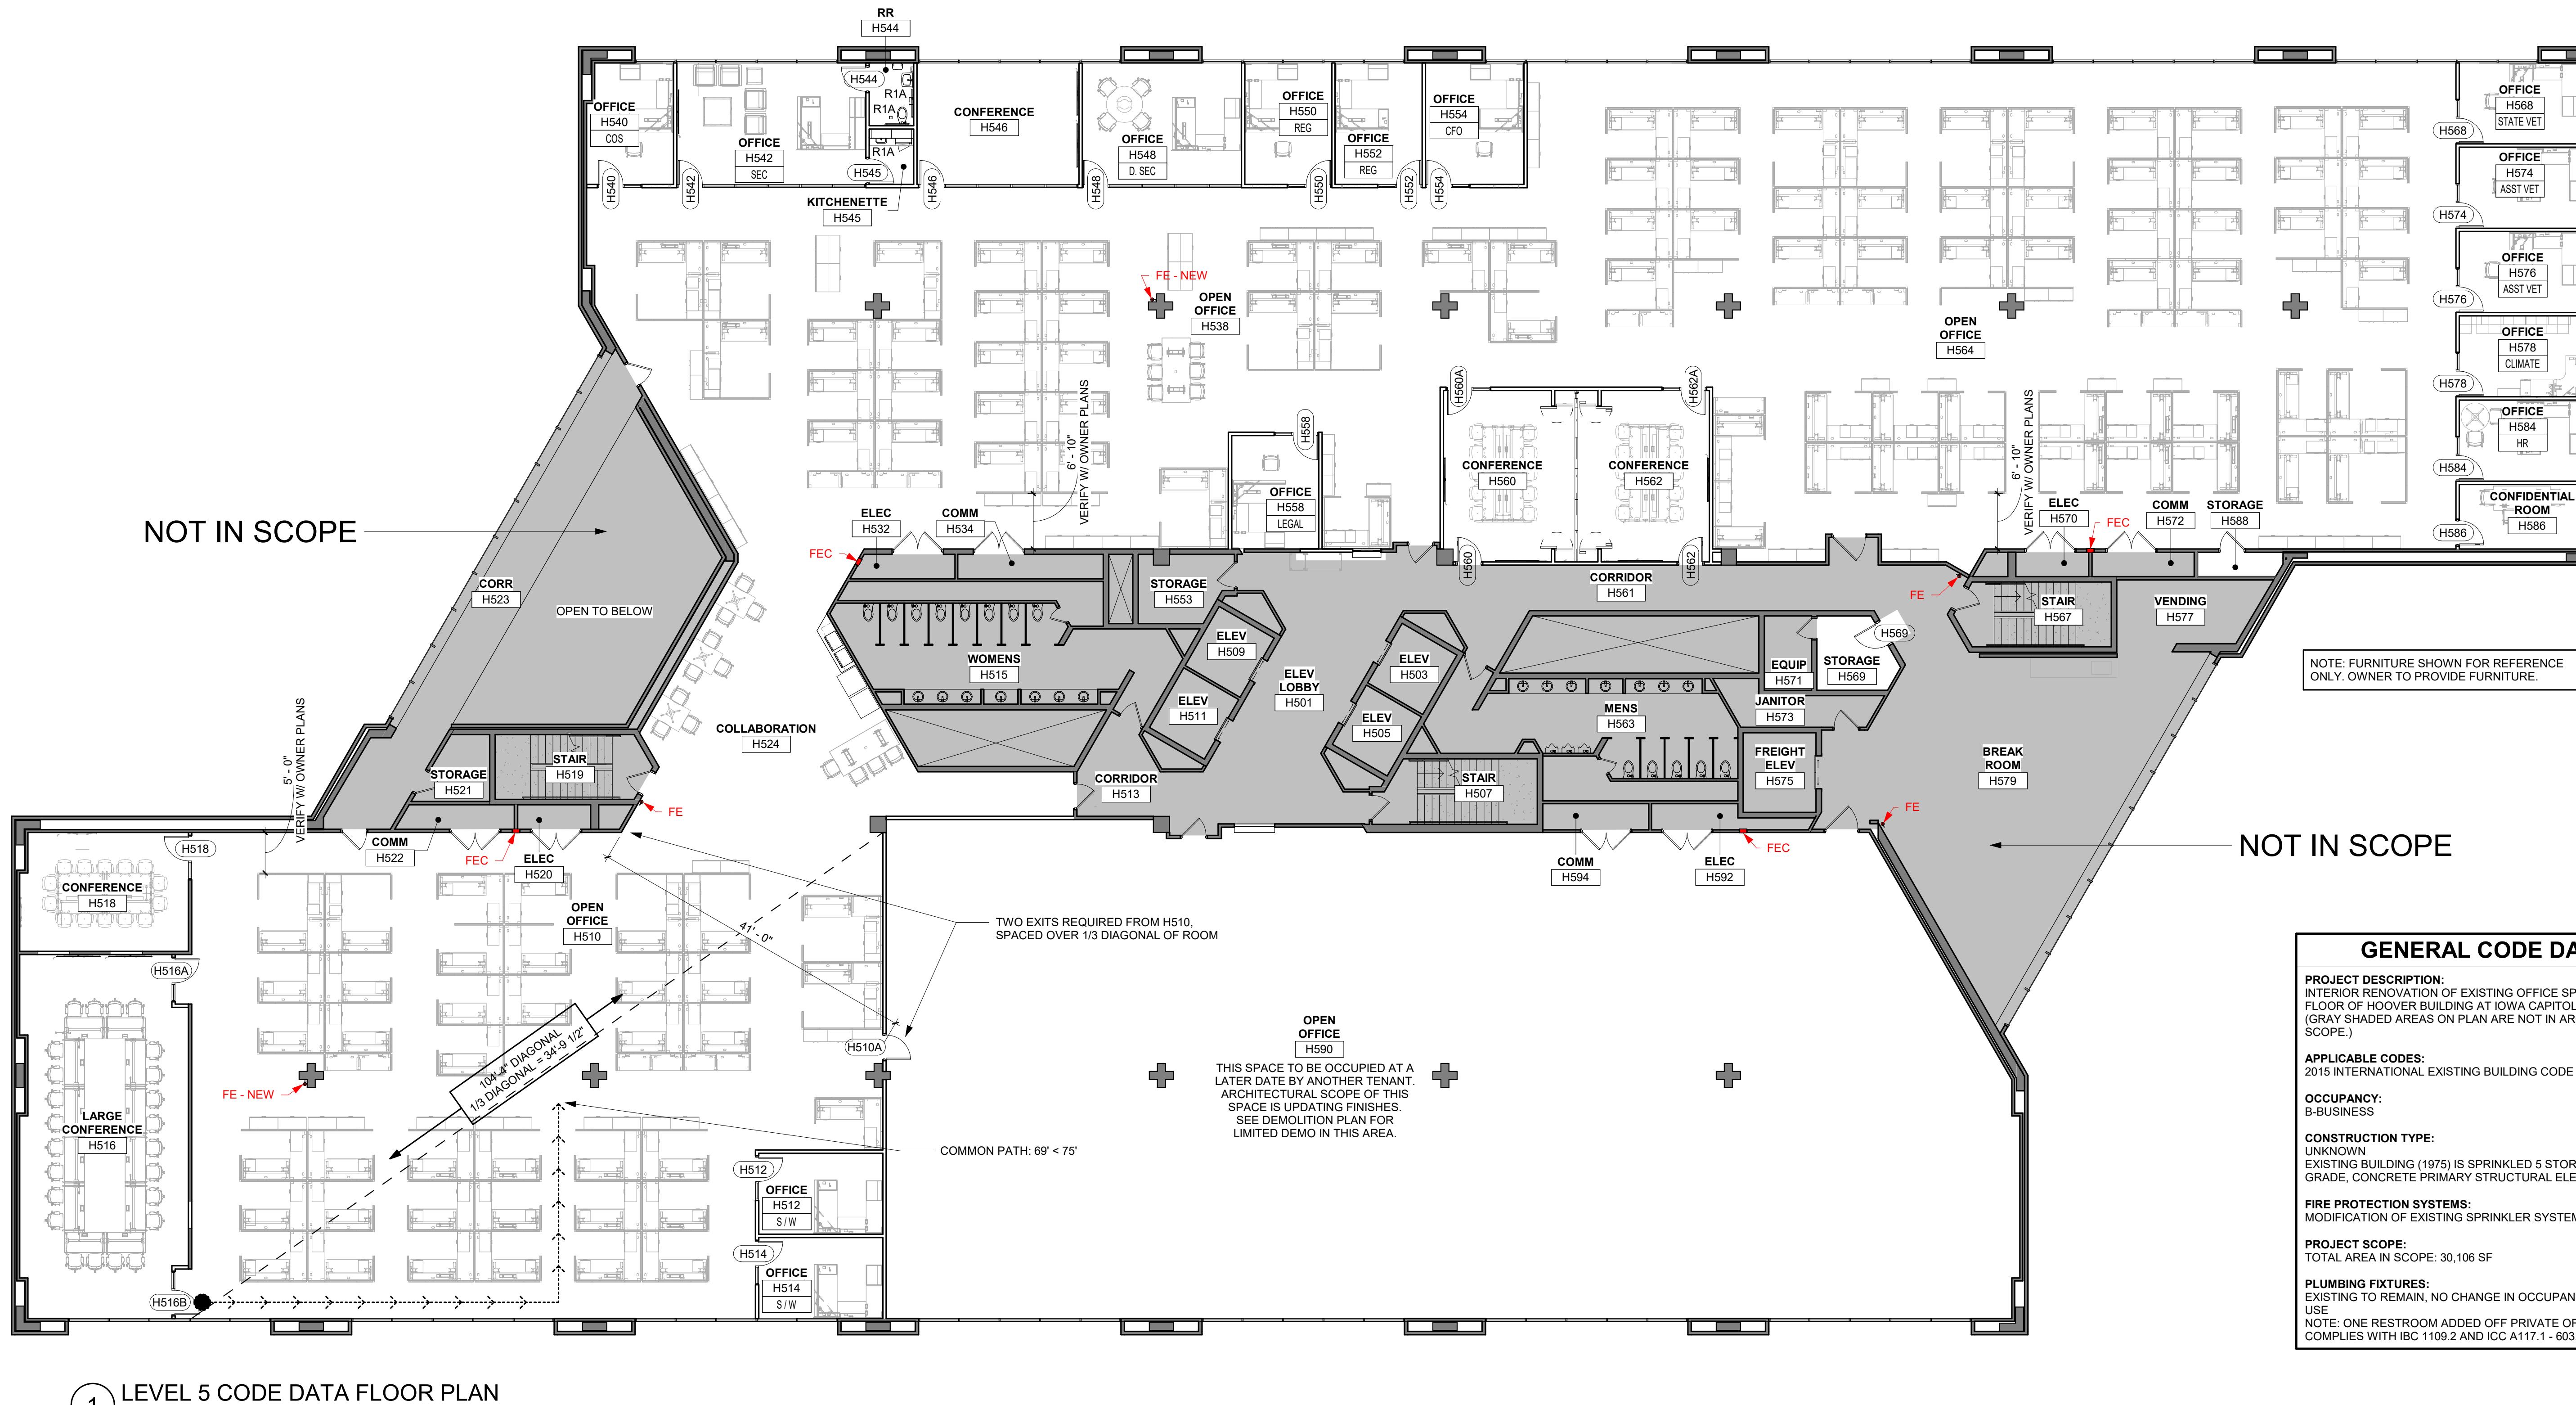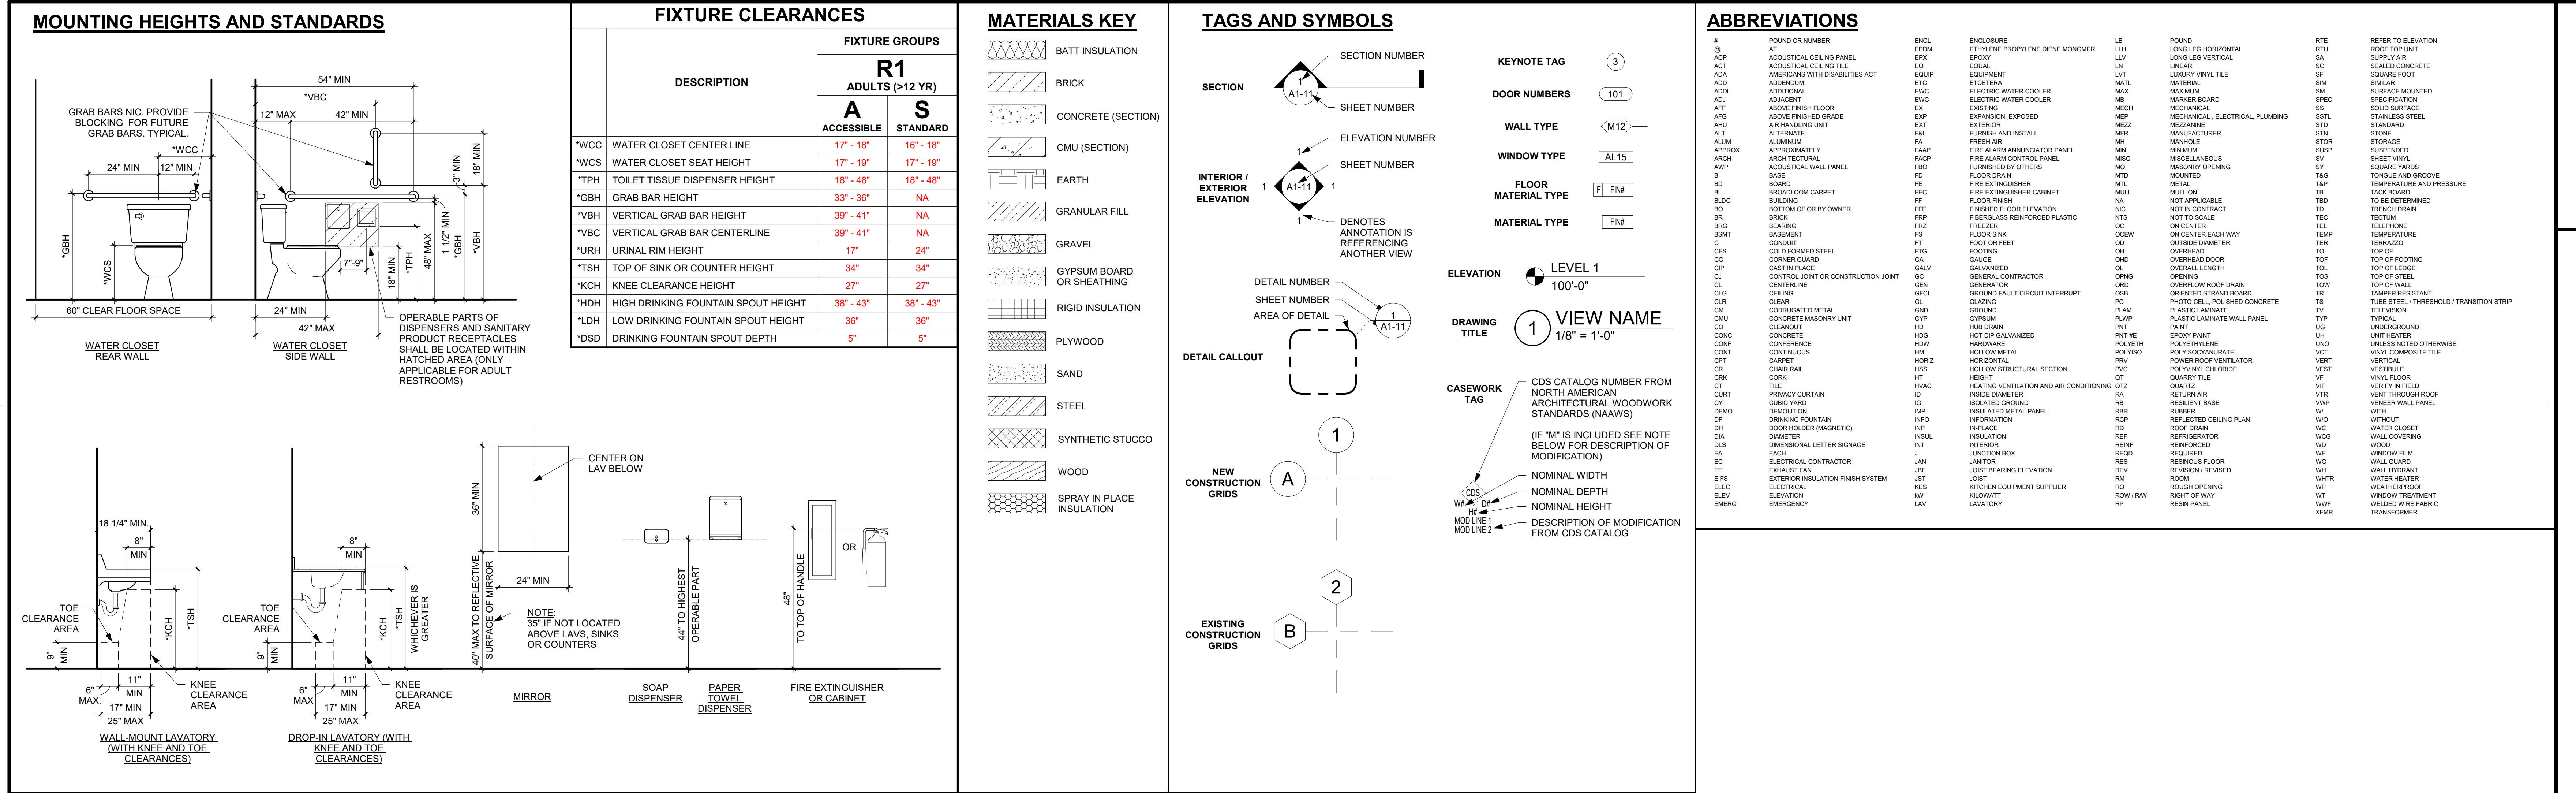

**FIRE SUPPRESSION NOTES**

(NOT VALID UNLESS THIS TEXT IS COLOR)

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DESIGN OF NEW / MODIFIED NFPA 13 SPRINKLER SYSTEM SHALL BE BASED ON, BUT NOT LIMITED TO THE FOLLOWING CRITERIA:

1. COMPLY WITH NFPA 13 AND ALL OTHER APPLICABLE CODES.
2. MODIFY EXISTING SPRINKLER HEAD LAYOUT TO PROVIDE ADEQUATE COVERAGE PER CODE REQUIREMENTS.
3. MODIFY EXISTING SPRINKLER HEAD LAYOUT AND PIPING LAYOUT IF NECESSARY TO AVOID CONCEALED SPACES, MECHANICAL ROOMS, PLUMBING WORK, ELECTRICAL WORK, DEMOLITION WORK, NEW CONSTRUCTION WORK AND ALL OTHER WORK AND CONDITIONS THAT THE CONTRACTOR MAY REASONABLY DETERMINE ARE NECESSARY FOR THE REMOVAL AND REPLACEMENT OF CEILING GRIDS, INCLUDING NEW CEILING GRIDS AND GRIDS REMOVED AND REPLACED ONLY TO COMPLETE OTHER WORK.
4. PROVIDE PROPER COVERAGE IN CONCEALED SPACES AS REQUIRED PER CODE.
5. WHERE INDICATED, NEW WORK ADJACENT TO EXISTING, WHICH NEW COMPONENTS TO EXISTING COMPONENTS WITHIN CODE LIMITATIONS.
6. ALL NEW AND RELOCATED SPRINKLER PIPING AND COMPONENTS SHALL BE CONCEALED ABOVE CEILINGS AND WHERE APPROPRIATE.
7. ALL SPRINKLER HEADS TO BE INSTALLED IN ACOUSTICAL CEILING TILE SHALL BE INSTALLED IN CENTER OF TILE.

**WALL LEGEND**

EXISTING CONSTRUCTION TO REMAIN
NEW CONSTRUCTION

CONTRACTOR TO VERIFY EXISTING RATED WALL CONSTRUCTION IN FIELD AND REPORT ANY DISCREPANCIES TO THE PROJECT ARCHITECT.

**CODE DATA PLAN KEY**

EXIT
FE FIRE EXTINGUISHER
FEC SEMI-RECESSED FIRE EXTINGUISHER CABINET
COMMON PATH OF TRAVEL

**CODE DATA AND CODE DATA PLAN**

**REFERENCE SCALE**

0' 0" 1' 0" 2' 0" 3' 0" 4' 0" 5' 0" 6' 0" 7' 0" 8' 0" 9' 0" 10' 0"

**PROJECT NO.** 24-31954

**FILE NAME**

**DRAWN BY** KKT

**DESIGNED BY** KKT

**REVIEWED BY** EMS

**ORIGINAL ISSUE DATE** 01/21/2025

**CLIENT PROJECT NO.** 9426.00

**TITLE**




DAS CC IDALS  
HOOVER  
5TH FLOOR  
RENOVATION

DES MOINES IOWA

REVISION SCHEDULE	DATE	DESCRIPTION	BY

PROJECT NO.	24-31954
FILE NAME	
DRAWN BY	KKT
DESIGNED BY	KKT
REVIEWED BY	EMS
ORIGINAL ISSUE DATE	01/21/2025
CLIENT PROJECT NO.	9426.00


TITLE

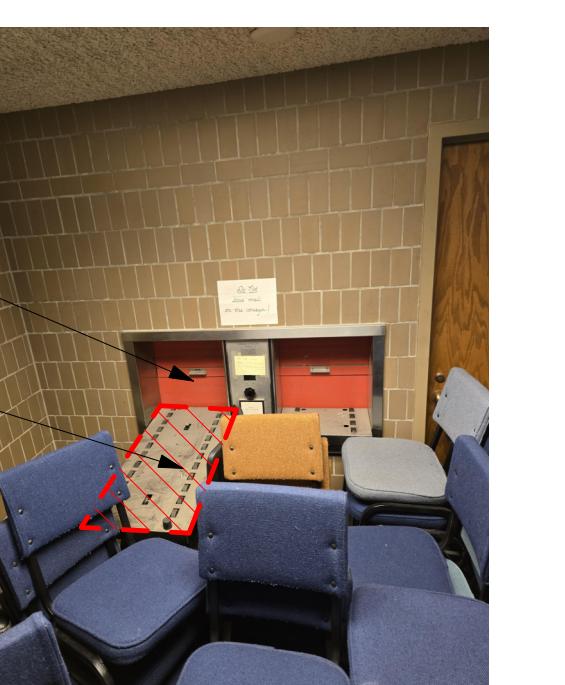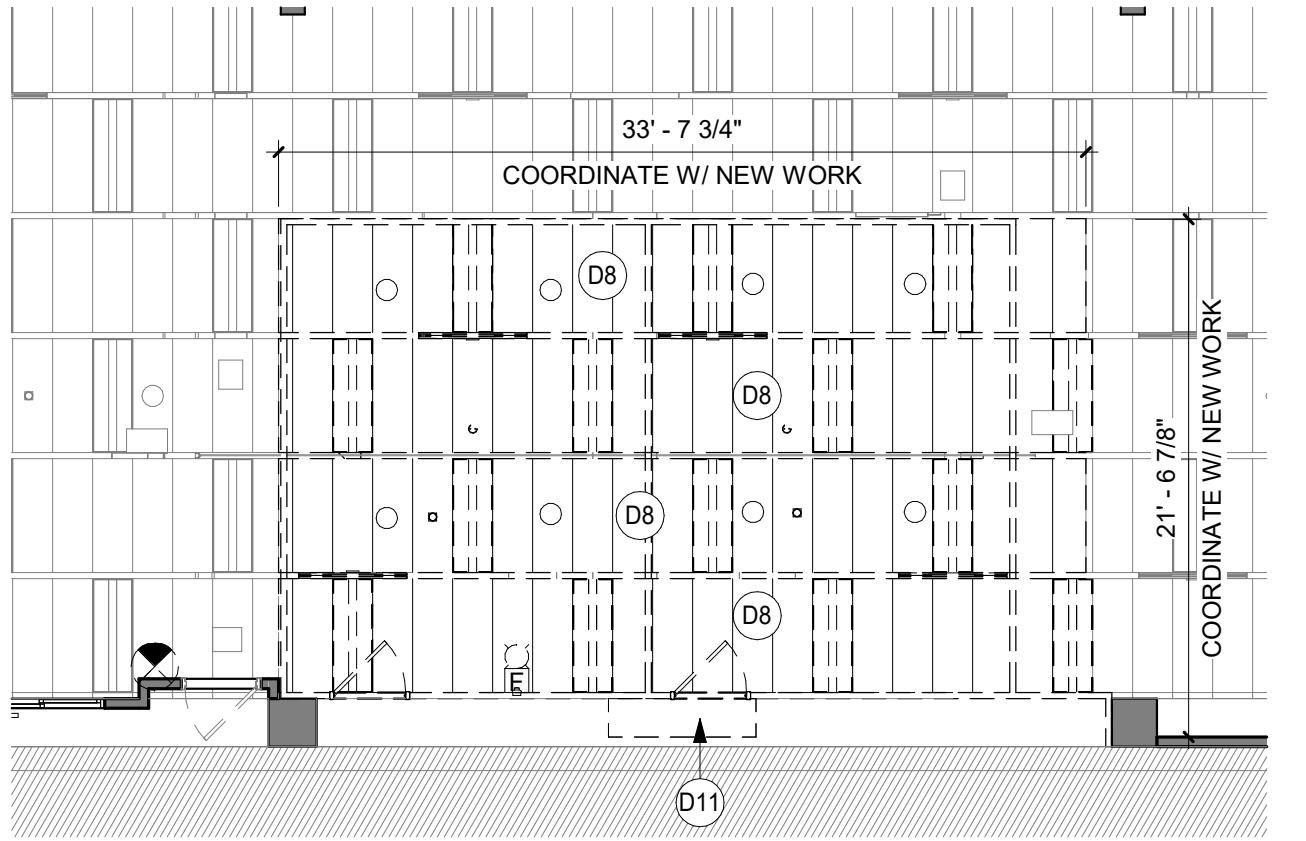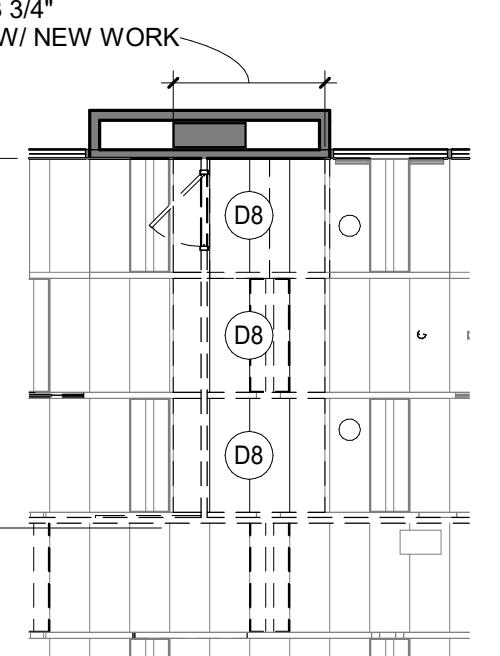LEVEL 5  
DEMOLITION  
PLAN

1 H544 AND H546 PARTIAL REFLECTED  
CEILING DEMO PLAN  
1/8" = 1'-0"

2 H560 AND H562 PARTIAL REFLECTED  
CEILING DEMO PLAN  
1/8" = 1'-0"

3 H569 DEMO PHOTO  
NOT TO SCALE

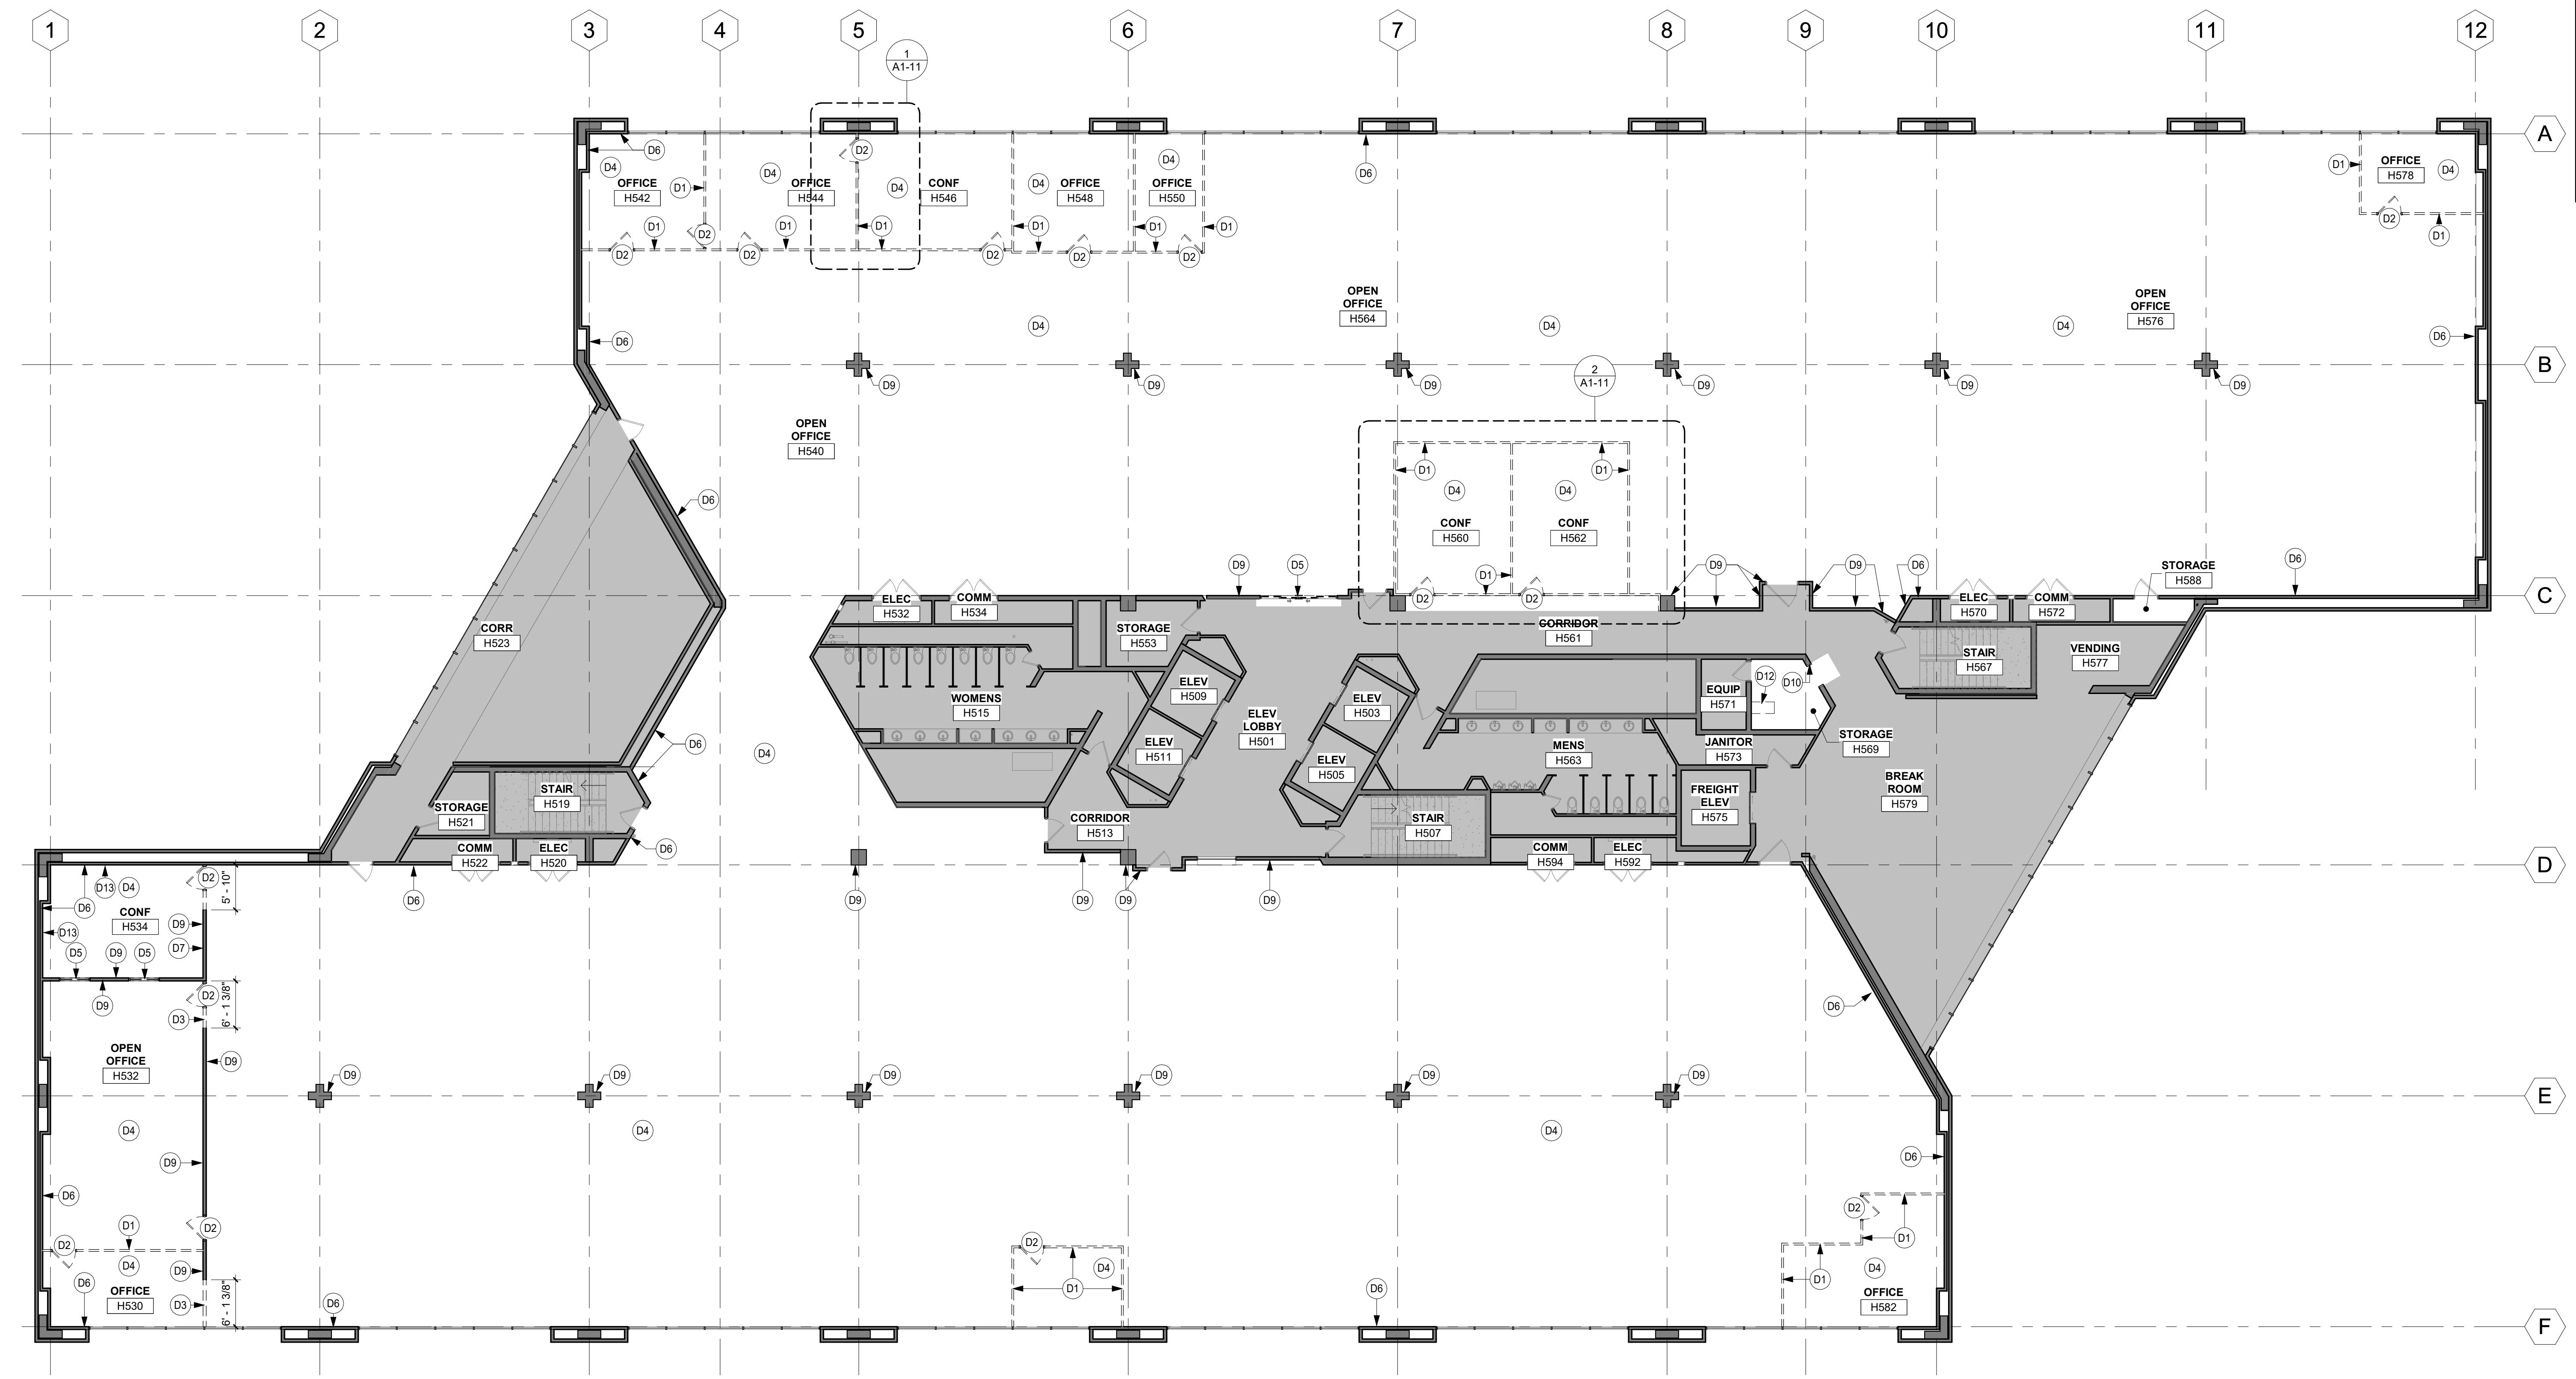

4 LEVEL 5 DEMOLITION PLAN  
3/32" = 1'-0"

WALL LEGEND	
—	EXISTING CONSTRUCTION TO REMAIN
—	DEMOLITION

## DEMOLITION SHEET NOTES

- A. EXISTING CONDITIONS SHOWN ON DRAWINGS REPRESENT CONDITIONS AS FOUND. IT IS THE RESPONSIBILITY OF THE CONTRACTOR TO EXAMINE THE DRAWINGS AND FIELD VERIFY EXISTING CONDITIONS TO DETERMINE SCOPE OF DEMOLITION WORK REQUIRED TO COMPLETE THE SCOPE OF DEMOLITION WORK AS SHOWN ON THE DRAWINGS PRIOR TO PERFORMING WORK. ADDITIONAL WORK THAT IS REQUIRED, WAS VISIBLE, AND COULD HAVE BEEN IDENTIFIED DURING BIDDING SHALL BE COMPLETED BY THE BIDDING TRADE CONTRACTOR(S) AT NO ADDITIONAL COST TO THE OWNER.
- B. REPORT ANY DISCREPANCIES TO THE ARCHITECT FOR REVIEW. WORK DONE WITHOUT RESOLUTION OF DISCREPANCIES MUST BE REDONE AT THE REQUEST OF THE ARCHITECT AND AT THE OWNER'S EXPENSE.
- C. DEMOLITION OF ANY EXISTING CONSTRUCTION SHALL INCLUDE WHAT IS NECESSARY AND REQUIRED TO ACCOMMODATE THE REQUIREMENTS OF NEW CONSTRUCTION.
- D. ALL LOOSE FURNISHINGS (CHAIRS, TABLES, DESKS, ETC.) SHALL BE REMOVED AND RE-INSTALLED BY THE OWNER UNLESS NOTED OTHERWISE.
- E. ALL WORK THRU EXISTING FLOORS, WALLS & CEILINGS SHALL BE PERFORMED BY THE CONTRACTOR REQUIRING THE SAME.
- F. ALL ROOF PENETRATIONS SHALL BE PERFORMED BY THE TRADING CONTRACTOR. ALL ROOFING AND ROOF SHEATHING SHALL BE PERFORMED BY THE ROOFING CONTRACTOR. VERIFY WITH OWNER FOR ITEMS TO BE SALVAGED BEFORE STARTING DEMOLITION WORK.
- G. CONSTRUCT DUST PROOF PARTITIONS TO SEPARATE AREAS OF CONSTRUCTION FROM ADJACENT OCCUPIED AREAS OR OTHER SOURCE OF DUST.
- H. CONSTRUCT DUST PROOF PARTITIONS TO SEPARATE AREAS OF CONSTRUCTION FROM ADJACENT OCCUPIED AREAS OR OTHER SOURCE OF DUST.
- I. AT OPENINGS IN EXISTING MASONRY WALLS, REMOVE EXISTING WALL TO NEAREST MASONRY JOINT. SEE FLOOR PLAN FOR OPENING SIZES. SAWTOOTH INTO EXISTING JAMB. MAKE SAWTOOTH CUT AS SHOWN ON FLOOR PLAN OTHERWISE.
- K. REQUIRED MEANS OF EGRESS FROM THE BUILDING SHALL BE MAINTAINED AT ALL TIMES DURING CONSTRUCTION WHEN THE BUILDING REMAINS OCCUPIED. IN THE EVENT THAT AN EXISTING MEANS OF EGRESS CANNOT BE MAINTAINED BY THE PRINCIPAL CONTRACTOR, SHELL PROVIDE AN APPROVED TEMPORARY MEANS OF EGRESS.
- L. MAINTAIN THE INTEGRITY OF ALL EXISTING RATED ELEMENTS, UNLESS ANY PENETRATIONS WITH U.L. APPROVAL ASSEMBLY.
- M. CONTRACTOR IS TO VERIFY THE EXACT LOCATION OF ALL EXISTING UTILITIES PRIOR TO DEMOLITION ACTIVITIES.
- N. DO NOT DAMAGE EXISTING UTILITIES. IF DAMAGE OCCURS IN WRITING B&H, PROVIDE TEMPORARY SERVICES DURING INTERRUPTIONS TO EXISTING UTILITIES, AS ACCEPTABLE TO GOVERNING AUTHORITIES.
- O. WHERE UTILITIES ARE LOCATED IN EXISTING CONSTRUCTION, REMOVE, RELOCATE OR ABANDON. PROVIDE BYPASS CONNECTIONS TO MAINTAIN CONTINUITY OF SERVICE BEFORE PROCEEDING WITH REMOVAL.
- P. WHERE EXISTING EXTERIOR PARTITIONS ARE REPLACED OR REMOVED, REMOVE EXISTING PARTITIONS BACK TO PANTRY OR MECHANICAL ROOM OR FARTHEST POSSIBLE POINT WITHOUT DISTURBING EXISTING CONSTRUCTION. REMOVE EXISTING MECHANICAL EQUIPMENT, RELOCATE POWER PER MECHANICAL CONTRACTOR.
- Q. ALL WALLS IN EXISTING ROOMS IN WHICH WORK IS OCCURRING: A) REPAIR HOLES, DEFECTS, ETC. IN EXISTING WALLS; B) AT REPAIRS AND UNPAINTED CMU, PROVIDE BULKHEAD AS REQUIRED FOR NEW PARTITION; C) PROVIDE ONE FINISH COAT OF PAINT OVER EXISTING PAINTED WALLS.
- R. PROTECT ALL DEVICES AND EQUIPMENT TO REMAIN OR BE SALVAGED. REFER TO MECHANICAL AND ELECTRICAL DRAWINGS.

## KEYNOTE LEGEND




- D1 REMOVE/DEMOLISH EXISTING WALL AS INDICATED, PATCH AND REPAIR ADJACENT WALL AND CEILING TO REMAIN.
- D2 REMOVE/DEMOLISH EXISTING DOOR AND FRAME.
- D3 CUT HOLE IN EXISTING WALL TO INCORPORATE NEW WORK.
- D4 REMOVE EXISTING FLOOR COVERING, PREP SURFACE FOR NEW FINISH.
- D5 REMOVE/DEMOLISH EXISTING WINDOW GLAZING AND FRAME.
- D6 REMOVE/DEMOLISH EXISTING STONE BASE THROUGHOUT WORK AREA (INC), PATCH AND REPAIR WALL AND PREPARE FOR NEW FINISH.
- D7 REMOVE/DEMOLISH EXISTING WHITEBOARD, PATCH AND REPAIR WALL.
- D8 REMOVE AND SALVAGE EXISTING CEILING GRID, TILES, AND ACCESSORIES - TURN OVER TO OWNER. REFER TO ELECTRICAL FOR EXISTING LIGHT FIXTURES.
- D9 REMOVE / DEMOLISH EXISTING VINYL BASE THROUGHOUT WORK AREA, PATCH AND REPAIR FOR NEW BASE.
- D10 REMOVE EXISTING HOLLOW METAL FRAME AND PREPARE OPENING FOR NEW DOOR AND FRAME.
- D11 DEMOLISH PORTION OF BULKHEAD AS REQUIRED FOR NEW OPERABLE PARTITION WALL AND POCKET INSTALLATION. COORDINATE WITH PARTITION WALL MFR REQ'S FOR POCKET SIZE.
- D12 REMOVE TRAY THAT EXTENDS INTO H569 FROM EQUIP H571. REFER TO H569 DEMO PHOTO ON THIS SHEET.
- D13 COORDINATE WITH OWNER FOR REMOVAL OF EXISTING WALL-MOUNTED EQUIPMENT.

MARK	ROOM NAME	WIDTH	HEIGHT	DOOR TYPE	DOOR MATERIAL	FRAME TYPE	FRAME MATERIAL	FIRE RATING	POWER REQUIRED	ACCESS CONTROL	AUTO OPERATOR (ADA)	HOLD OPEN	EGRESS	HARDWARE GROUP	COMMENTS			
															1	2	3	
H510A	OPEN OFFICE	3'-0"	7'-0"	FL	ALUMINUM	HOLLOW METAL	ALUMINUM							7.0	PANIC BAR W/ LOCAL ALARM.	1.0		
H512	OFFICE	3'-0"	7'-0"	FL	ALUMINUM	HOLLOW METAL	ALUMINUM							10.0	SINGLE ACTION OFFICE HARDWARE.	1.0		
H514	OFFICE	3'-0"	7'-0"	FL	ALUMINUM	HOLLOW METAL	ALUMINUM							3.1	SINGLE ACTION OFFICE HARDWARE.	1.0		
H516A	LARGE CONFERENCE	3'-0"	7'-0"	FL	ALUMINUM	HOLLOW METAL	ALUMINUM							3.1	PASSAGE HARDWARE.	1.0		
H516B	LARGE CONFERENCE	3'-0"	7'-0"	FL	ALUMINUM	HOLLOW METAL	ALUMINUM							3.0	PASSAGE HARDWARE. FIELD VERIFY WALL THICKNESS FOR FRAME DEPTH.	1.0		
H518	CONFERENCE	3'-0"	7'-0"	FL	WOOD	HOLLOW METAL	ALUMINUM							1.1	SINGLE ACTION OFFICE HARDWARE.	1.0		
H540	OFFICE	3'-0"	7'-0"	FL	ALUMINUM	HOLLOW METAL	ALUMINUM							1.0	SINGLE ACTION OFFICE HARDWARE.	1.0		
H542	OFFICE	3'-0"	7'-0"	FL	ALUMINUM	HOLLOW METAL	ALUMINUM							2.0	SINGLE ACTION PRIVACY HARDWARE.	1.0		
H544	RR	3'-0"	7'-0"	FL	WOOD	HOLLOW METAL	ALUMINUM							4.0	PASSAGE HARDWARE.	1.0		
H546	CONFERENCE	3'-0"	7'-0"	FL	WOOD	HOLLOW METAL	ALUMINUM							3.0	PASSAGE HARDWARE.	1.0		
H548	OFFICE	3'-0"	7'-0"	FL	ALUMINUM	HOLLOW METAL	ALUMINUM							1.0	SINGLE ACTION OFFICE HARDWARE.	1.0		
H550	OFFICE	3'-0"	7'-0"	FL	ALUMINUM	HOLLOW METAL	ALUMINUM							1.0	SINGLE ACTION OFFICE HARDWARE.	1.0		
H552	OFFICE	3'-0"	7'-0"	FL	ALUMINUM	HOLLOW METAL	ALUMINUM							1.0	SINGLE ACTION OFFICE HARDWARE.	1.0		
H554	OFFICE	3'-0"	7'-0"	FL	ALUMINUM	HOLLOW METAL	ALUMINUM							1.0	SINGLE ACTION OFFICE HARDWARE.	1.0		
H558	OFFICE	3'-0"	7'-0"	FL	ALUMINUM	HOLLOW METAL	ALUMINUM							1.0	SINGLE ACTION OFFICE HARDWARE.	1.0		
H560	CONFERENCE	3'-0"	7'-0"	NL	WOOD	HOLLOW METAL		•	•					6.1	LOCK W/ CARD READER.	1.0		
H560A	CONFERENCE	3'-0"	7'-0"	FL	ALUMINUM	HOLLOW METAL		•	•					6.0	LOCK W/ CARD READER.	1.0		
H562	CONFERENCE	3'-0"	7'-0"	NL	WOOD	HOLLOW METAL		•	•					6.0	LOCK W/ CARD READER.	1.0		
H562A	CONFERENCE	3'-0"	7'-0"	FL	ALUMINUM	HOLLOW METAL								6.0	LOCK W/ CARD READER.	1.0		
H568	OFFICE	3'-0"	7'-0"	FL	ALUMINUM	HOLLOW METAL								5.0	STOREROOM HARDWARE. FIELD VERIFY EXISTING OPENING.	1.0		
H569	STORAGE	3'-0"	6'-9 3/4"	FL	WOOD	HOLLOW METAL												
H574	OFFICE	3'-0"	7'-0"	FL	ALUMINUM	HOLLOW METAL								1.0	SINGLE ACTION OFFICE HARDWARE.	1.0		
H576	OFFICE	3'-0"	7'-0"	FL	ALUMINUM	HOLLOW METAL								1.0	SINGLE ACTION OFFICE HARDWARE.	1.0		
H578	OFFICE	3'-0"	7'-0"	FL	ALUMINUM	HOLLOW METAL								1.0	SINGLE ACTION OFFICE HARDWARE.	1.0		
H584	OFFICE	3'-0"	7'-0"	FL	ALUMINUM	HOLLOW METAL								1.0	SINGLE ACTION OFFICE HARDWARE.	1.0		
H586	CONFIDENTIAL ROOM	3'-0"	7'-0"	NL	WOOD	HOLLOW METAL												

DOOR SCHEDULE GENERAL NOTES:

1. CARD READER PROVIDED AND INSTALLED BY OWNER. ROUGH IN FOR CARD READER BY CONTRACTOR.
2. DOOR HARDWARE STYLE AND FINISH TO MATCH EXISTING HARDWARE TO REMAIN. COORDINATE WITH SPEC AND OWNER.

## FRAME TYPES

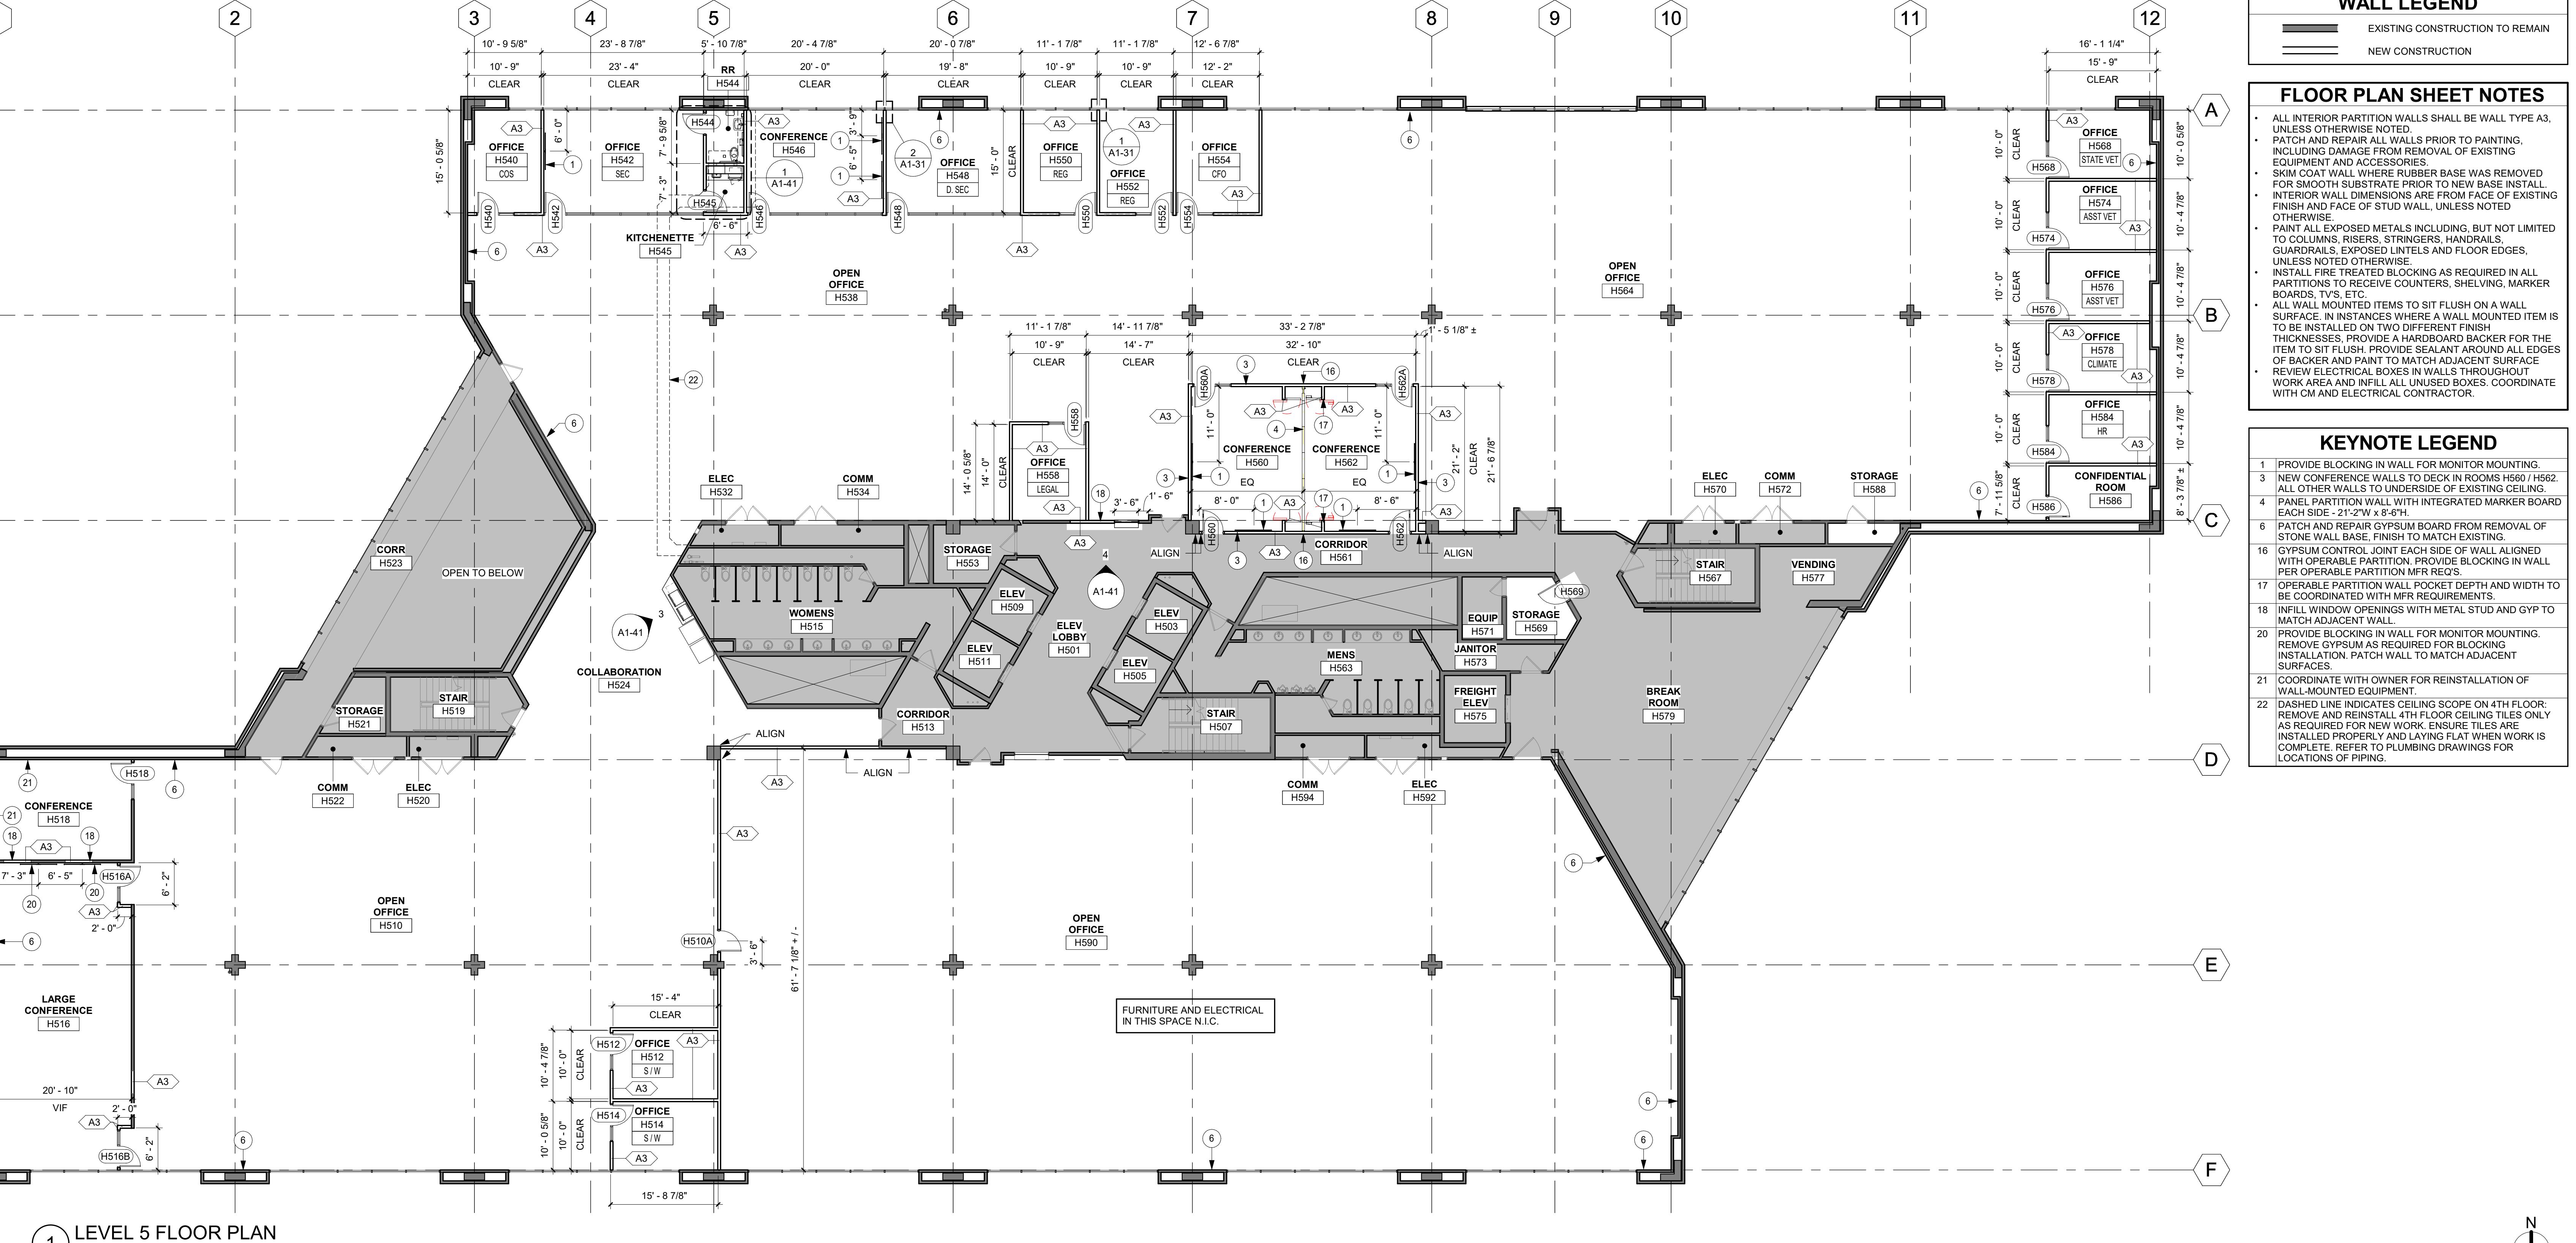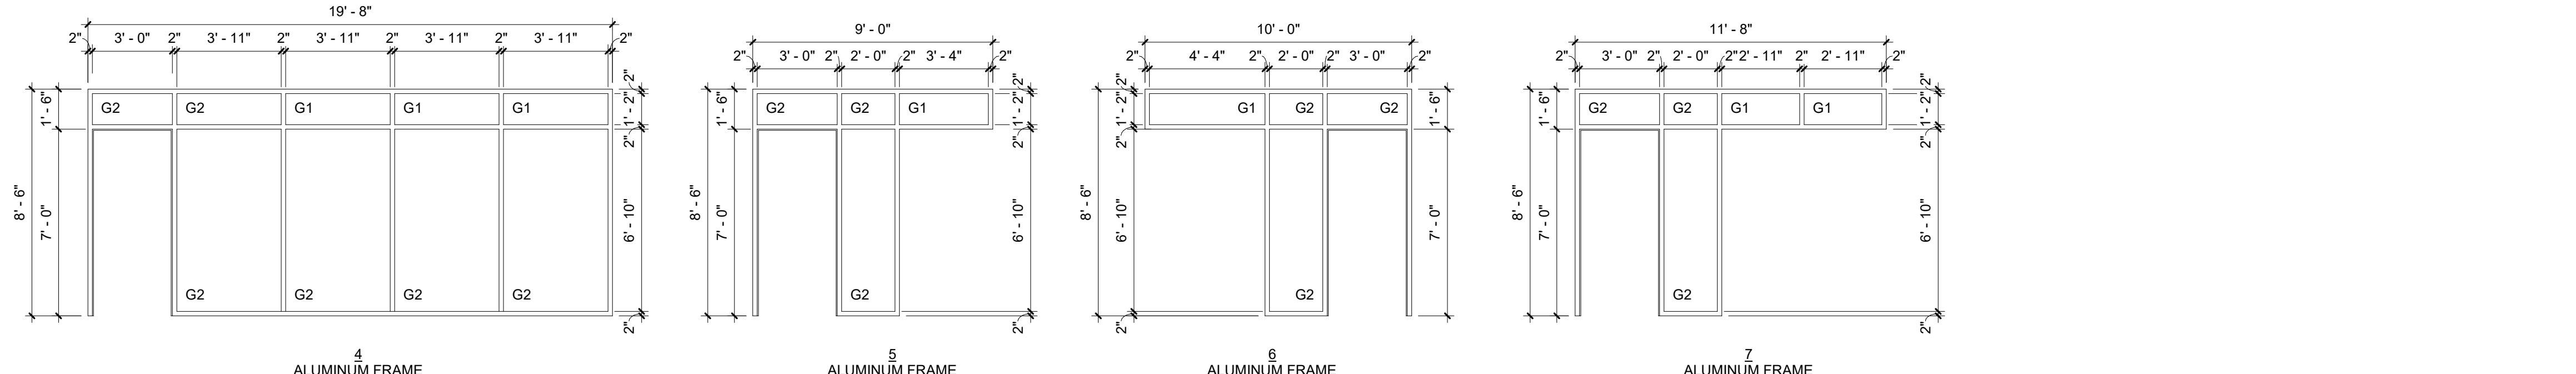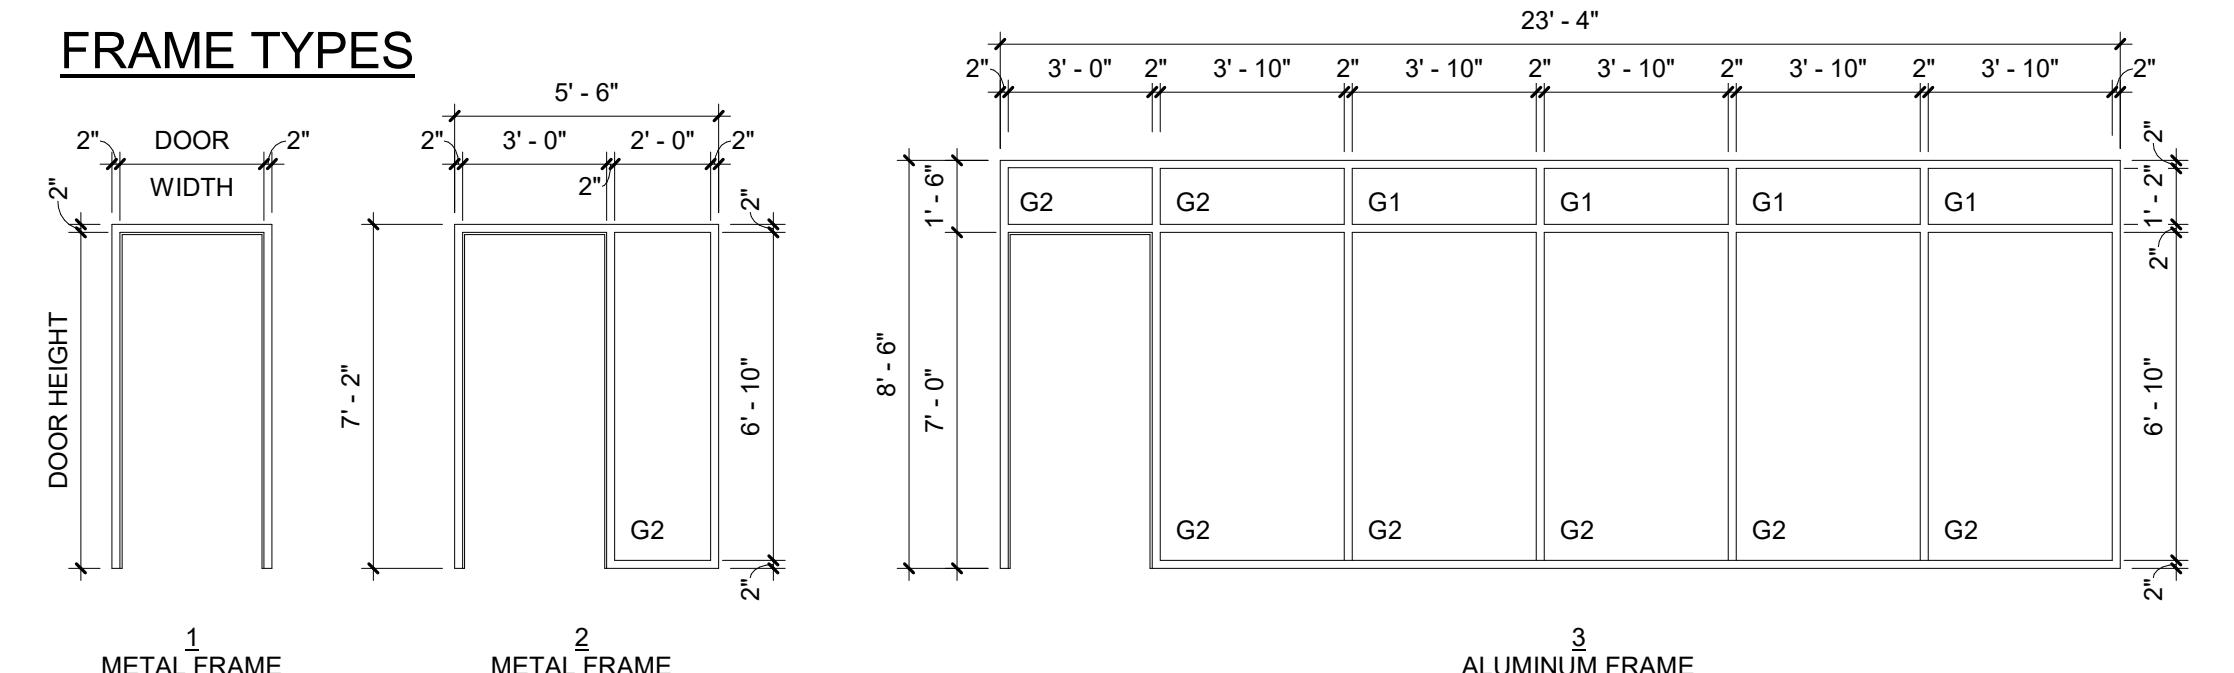

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**1 INTERIOR WALL TO GLAZING**  
3" = 1'-0"

**2 INTERIOR WALL TO MULLION**  
3" = 1'-0"

**3 FOLDING PANEL PARTITION HEAD**  
1 1/2" = 1'-0"

**4 PARTITION SUPPORT DETAIL**  
1 1/2" = 1'-0"

**5 HM LITE JAMB AT METAL STUDS**  
1 1/2" = 1'-0"

**6 HM LITE HEAD AT METAL STUDS**  
1 1/2" = 1'-0"

**7 HM DOOR JAMB AT METAL STUDS**  
1 1/2" = 1'-0"

**8 LEVEL 5 REFLECTED CEILING PLAN**  
3/32" = 1'-0"

**9 HM DOOR HEAD AT METAL STUDS**  
1 1/2" = 1'-0"

**10 TOP OF WALL AT CONF ROOMS H560 & H562**  
3/4" = 1'-0"

**11 ALUM HEAD AT METAL STUDS**  
1 1/2" = 1'-0"

**12 KEYNOTE LEGEND**

5 NEW 24"x24" ACCESS PANEL IN CEILING. LOCATE PIPES PRIOR TO INSTALLATION. COORDINATE FINAL ACCESS PANEL LOCATION WITH PIPES. ALIGN ACCESS PANEL WITH CEILING GRID.

8 MODIFY CEILING GRID AND TILES AS REQUIRED FOR NEW WALL INSTALLATION WITH CLEAN CUTS AND TRANSITIONS FOR A FINISHED END PRODUCT. REUSE COMPONENTS WHERE POSSIBLE. PROVIDE NEW COMPONENTS AS NECESSARY.

19 ALIGN NORTH FACE OF POCKET WITH EXISTING NORTH FACE OF BULKHEAD.

**13 RCP SHEET NOTES**

- COORDINATE WITH MECHANICAL, PLUMBING, FIRE PROTECTION AND ELECTRICAL FOR EXACT LOCATIONS OF CEILING FIXTURES, DIFFUSERS, SPRINKLER HEADS, ETC.
- REFER TO HVAC PLANS FOR THE LOCATION OF ANY AND ALL PLUMED CEILING SPACES. ALL WALLS AND SOFFITS CREATING THE PLUMED SHALL EXTEND TO THE UNDERSIDE OF STRUCTURE ABOVE AND BE SEALED.
- ENSURE ALL CEILING TILES ARE LAYING FLAT PRIOR TO PAINTING.

**14 DAS CC IDALS HOOVER 5TH FLOOR RENOVATION**

DES MOINES IOWA

REVISION SCHEDULE

DATE	DESCRIPTION	BY

PROJECT NO. 24-31954

FILE NAME KKT

DRAWN BY KKT

DESIGNED BY EMS

REVIEWED BY EMS

ORIGINAL ISSUE DATE 01/21/2025

CLIENT PROJECT NO. 9426.00

TITLE








**15 LEVEL 5 REFLECTED CEILING PLAN AND DETAILS**

REFERENCE SCALE  
1" = 1'-0"

0 1/4" 1/2" 1" 2"

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A1-31

1 ENLARGED RR H544 / KITCHENETTE H545  
1 1/4" = 1'-0"2 KITCHENETTE H545  
2 3/8" = 1'-0"3 COLLABORATION H524  
3 3/8" = 1'-0"4 CORRIDOR H561  
4 3/8" = 1'-0"8 FLOATING SHELF  
8 1 1/2" = 1'-0"9 UPPER CABINET  
9 1" = 1'-0"10 BASE CABINET  
10 1" = 1'-0"11 ADA SINK CABINET DETAIL  
11 1" = 1'-0"

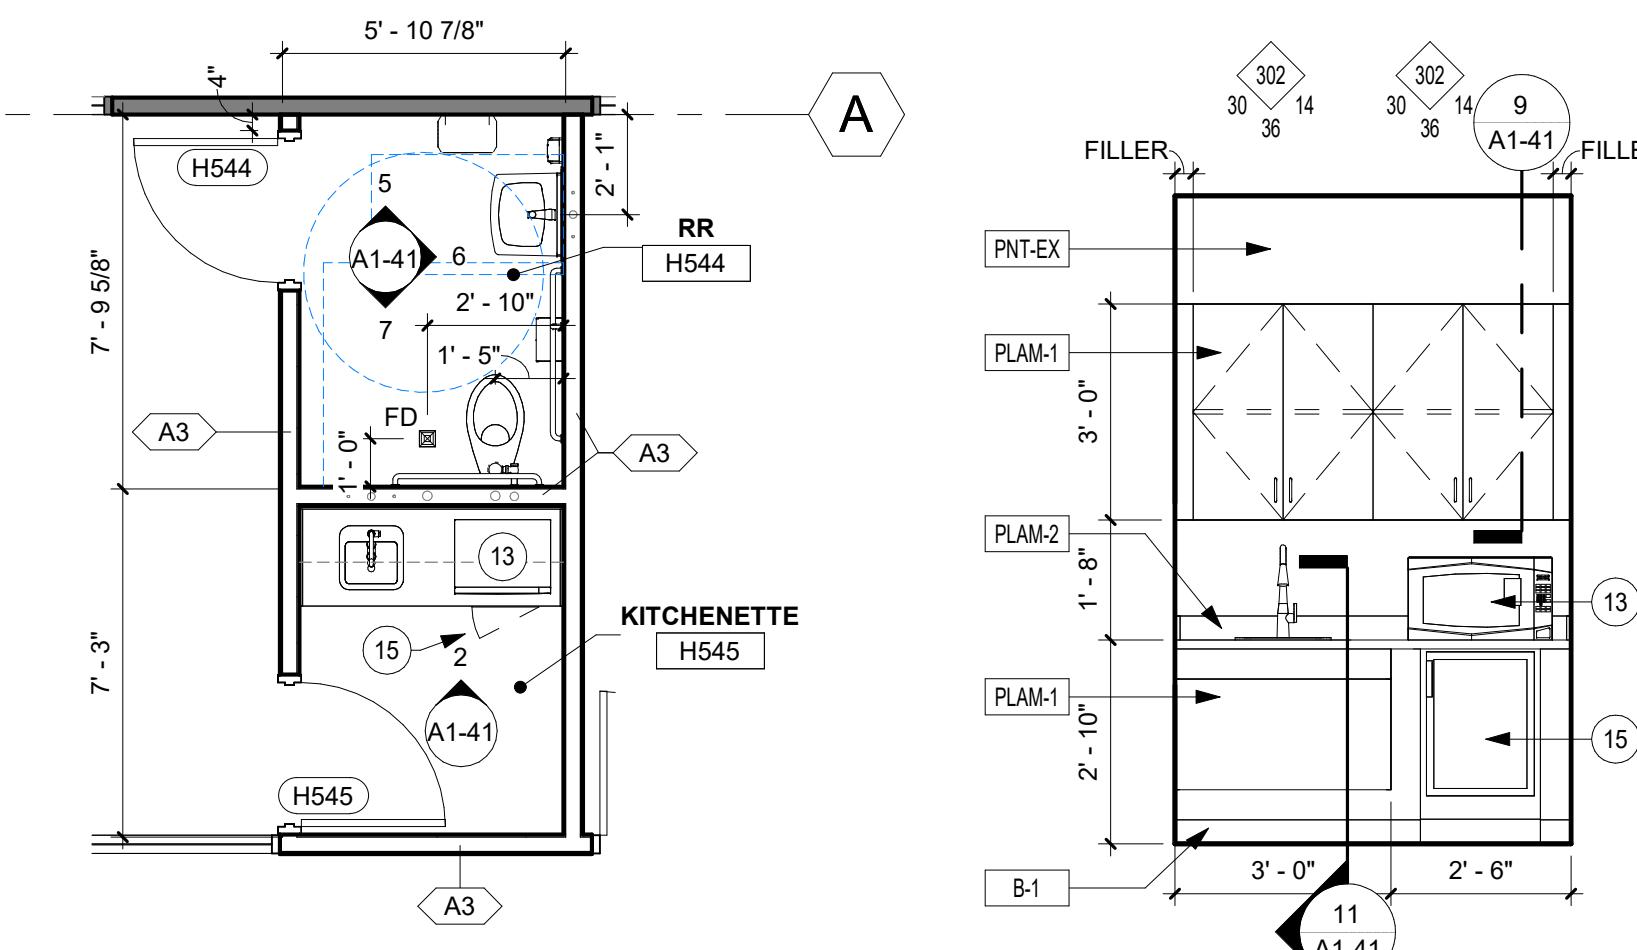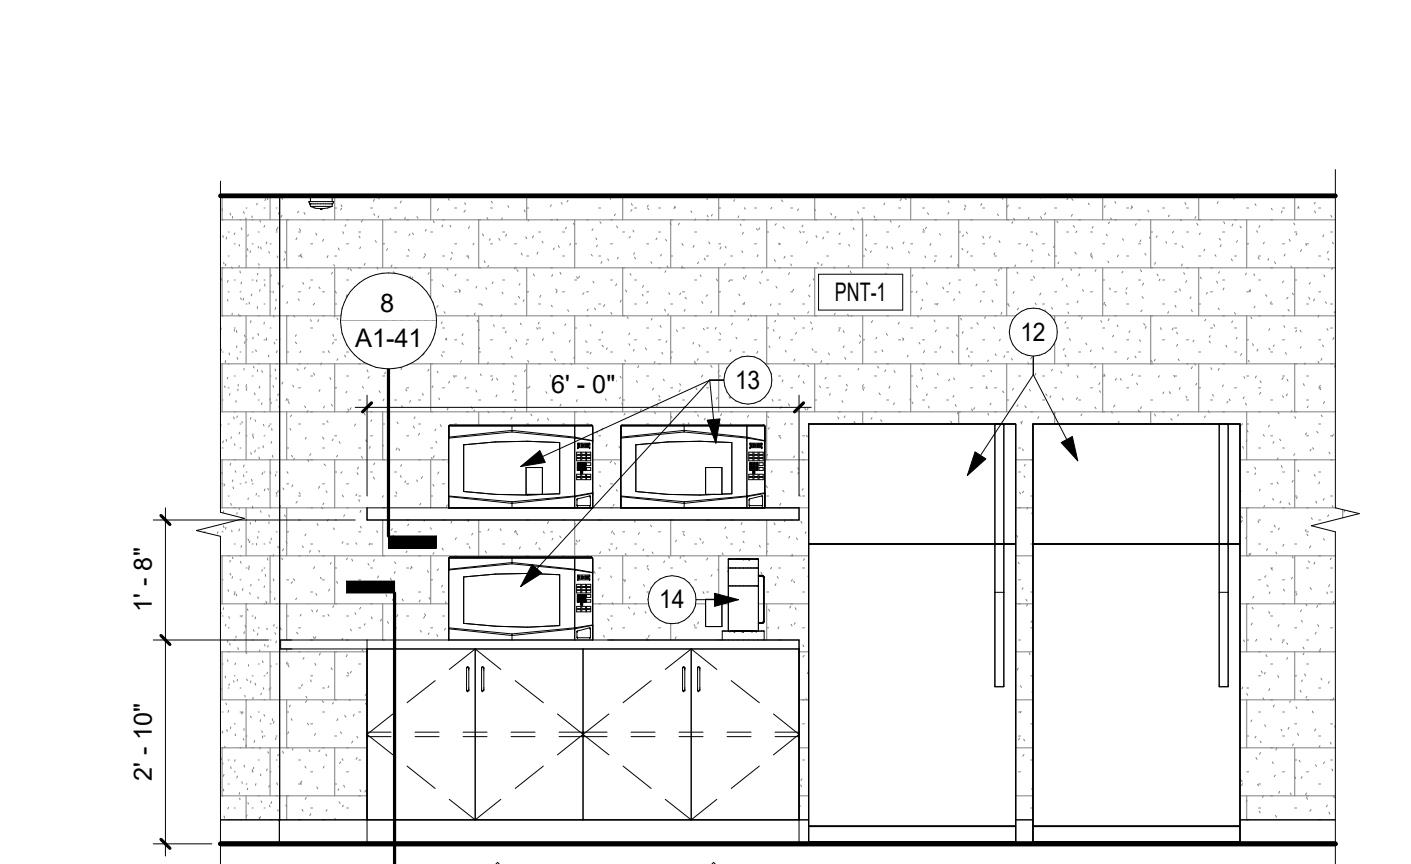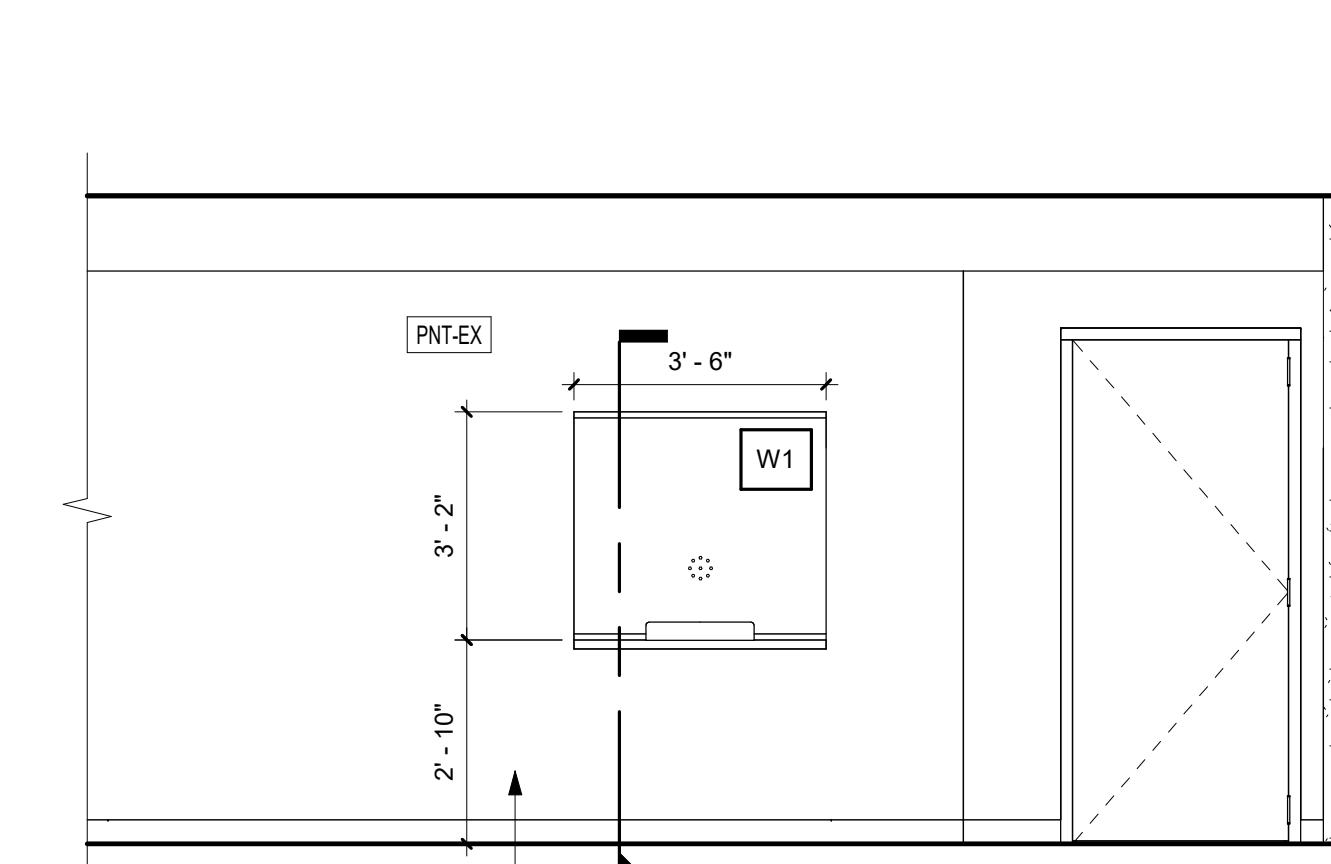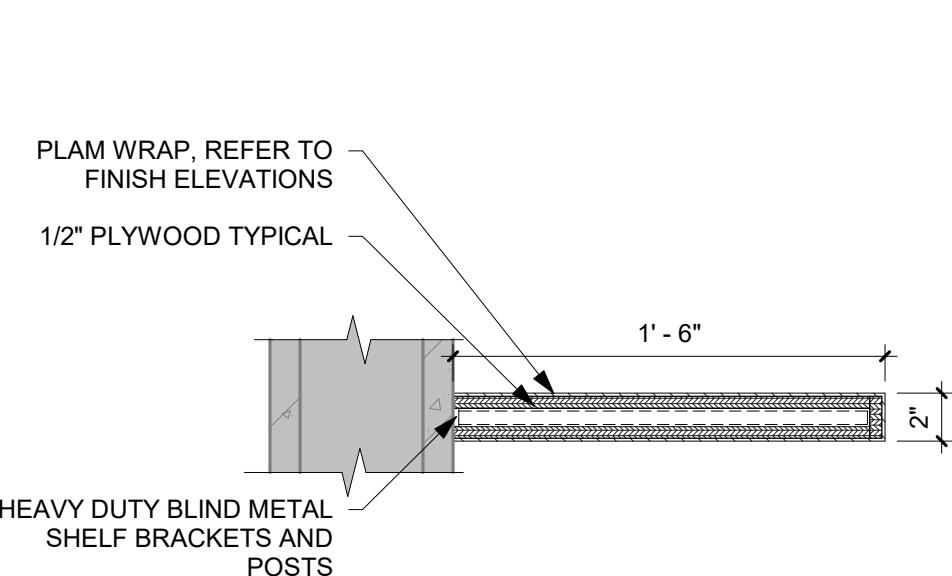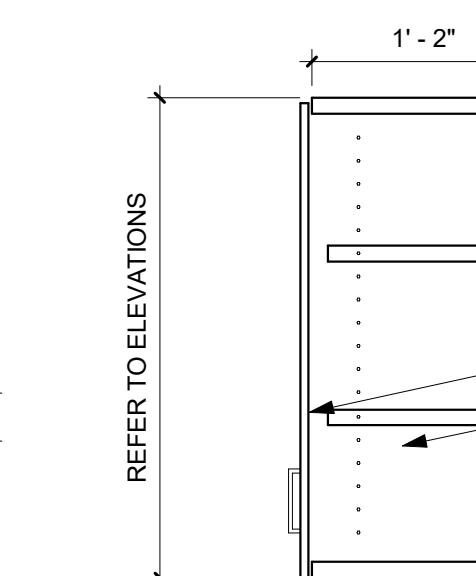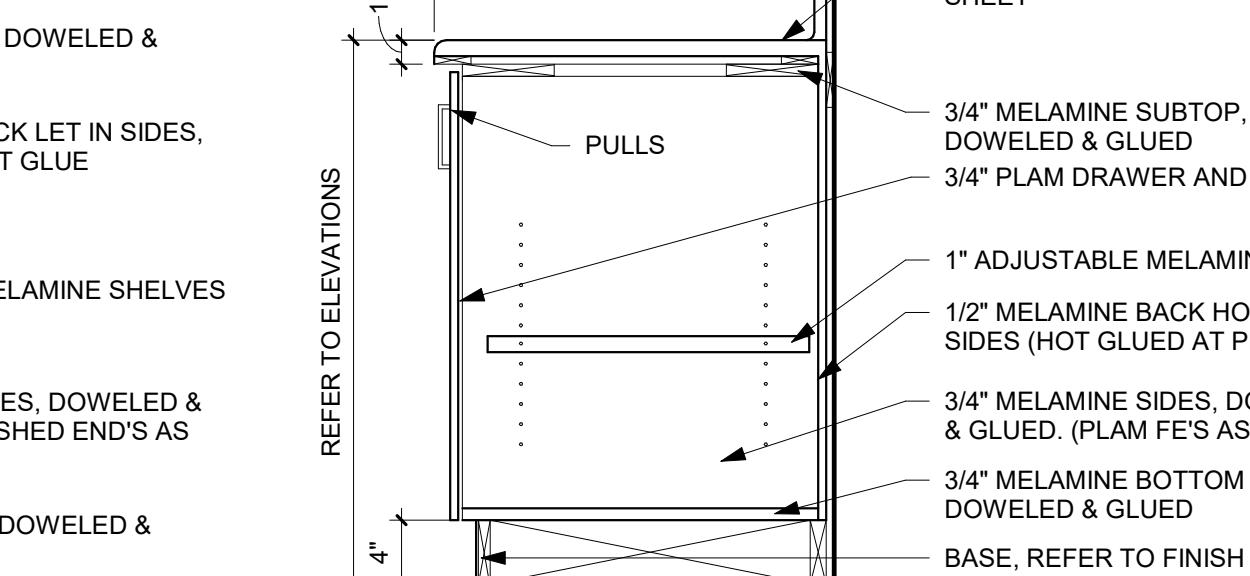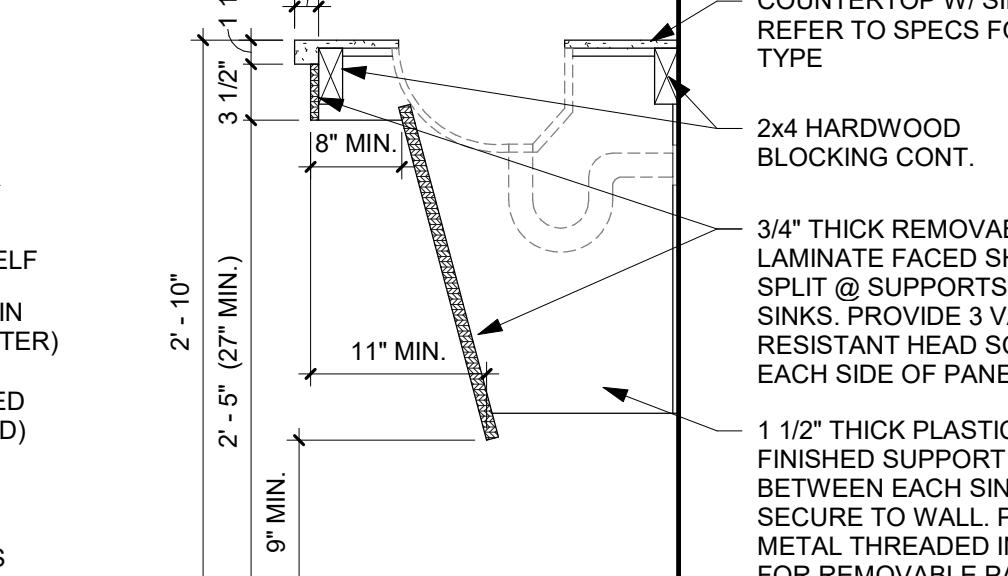INTERIOR FINISH SCHEDULE					
MARK	MATERIAL TYPE	MANUFACTURER	MODEL / SIZE	COLOR	ADDITIONAL INFORMATION / COMMENTS
CEILING	ACOUSTIC CEILING TILE	ARMSTRONG	584B HUMIGUARD PLUS 24"x24"x1/8"		TO MATCH EXISTING CORRIDOR H561 ACT
DOORS	WOOD		WHITE OAK	ALPINE, AL18	MATCH EXISTING WOOD DOORS.
FLOOR	CPT-1 CARPET TILE	SHAW CONTRACT	DIFFUSE COLOR 24x24 ECOWORK	78721 WARM BLUE	STYLE #57478 COORDINATE PATTERN / DIRECTION WITH OWNER. PROVIDE TRANSITIONS TO DIFFERENT MATERIALS UNDER DOORS.
	LVT-1 LUXURY VINYL TILE	MOHAWK	REFORESTATION	862 MARION	COORDINATE PATTERN / DIRECTION WITH OWNER. PROVIDE TRANSITIONS TO DIFFERENT MATERIALS UNDER DOORS.
	SC SEALED CONCRETE	LATICRETE INTERNATIONAL	L&M DRESS & SEAL		CLEAN AND SEAL EXISTING CONCRETE
PLASTIC LAMINATE	PLAM-1 PLASTIC LAMINATE	ARBORITE	W449 EV	RIFT NATURAL OAK	MILLWORK
	PLAM-2 PLASTIC LAMINATE	ARBORITE	P396 VL	ARCTIC TUNDRA	COUNTERTOPS
WALL	PNT-1 PAINT	SHERWIN WILLIAMS	SW7015	REPOSE GRAY	WALLS & PILLARS
	PNT-2 PAINT	SHERWIN WILLIAMS	SW6230	RAINSTORM	ACCENT PAINT
	PNT-3 PAINT	SHERWIN WILLIAMS	B42W02181	WHITE	PRO INDUSTRIAL WATERBORNE ACRYLIC DRYFALL FLAT
	PNT-4 PAINT	SHERWIN WILLIAMS	SW7019	GAUNTLET GRAY	DOOR FRAMES
	PNT-EX PAINT	SHERWIN WILLIAMS		MATCH ADJACENT WALLS	WALLS
WALL BASE	B-1 VINYL BASE	JOHNSONITE	#48	GREY	INSTALL ON ALL CASEWORK TOE KICKS, U.N.O.

KEYNOTE LEGEND

2 PAINT SIDE OF DOOR FRAMES WITHIN THE NEW WORK AREA ON EXISTING DOORS. TRANSITION COLOR AT NEW DOOR STOP SO ONLY ONE FRAME COLOR IS VISIBLE FROM EACH SIDE.

7 PAINT BOTH SIDES OF DOOR FRAME.

10 PAINT WALL TO MATCH EXISTING.

11 CLEAN AND PAINT EXPOSED MASONRY.

12 FRIGERATOR BY OWNER.

13 ICEMAKER BY OWNER.

14 COFFEE MAKER BY OWNER.

15 UNDER-COUNTER REFRIGERATOR BY OWNER.

ROOM / FINISH TAG

ROOM NAME  
ROOM #  
G CEILING  
W WALL  
B BASE  
F FLOOR

FINISHES LISTED IN ROOM TAG ARE FOR ELEMENTS IN ROOM, UNLESS NOTED OTHERWISE.

THE FOLLOWING SYMBOL APPLIED TO FINISHES IS DIFFERENT FROM THOSE NOTED IN ROOM TAG:  
[FIN]

THE FOLLOWING SYMBOL INDICATES "REFER TO ELEVATIONS" FOR ADDITIONAL FINISH INFORMATION  
[FIN]

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## DAS CC IDALS HOOVER 5TH FLOOR RENOVATION

DES MOINES IOWA

REVISION SCHEDULE	DATE	DESCRIPTION	BY


PROJECT NO.	24-31954
FILE NAME	
DRAWN BY	KKT
DESIGNED BY	KKT
REVIEWED BY	EMS
ORIGINAL ISSUE DATE	01/21/2025
CLIENT PROJECT NO.	9426.00

TITLE

## LEVEL 5 FINISH PLAN & SCHEDULE

MARK	DESCRIPTION	COMMENTS	PROVIDED BY	INSTALLED BY
GB1	36" HORIZONTAL GRAB BAR	INSTALL BLOCKING FOR GRAB BAR. GRAB BAR TO BE INSTALLED IN FUTURE.	CONTRACTOR	CONTRACTOR
GB2	42" HORIZONTAL GRAB BAR	INSTALL BLOCKING FOR GRAB BAR. GRAB BAR TO BE INSTALLED IN FUTURE.	CONTRACTOR	CONTRACTOR
GB3	18" VERTICAL GRAB BAR	INSTALL BLOCKING FOR GRAB BAR. GRAB BAR TO BE INSTALLED IN FUTURE.	CONTRACTOR	CONTRACTOR
MR1	Mirror	24"x36"	CONTRACTOR	CONTRACTOR
PTD	Touchless Paper Towel Dispenser	GP-59462A	OWNER	CONTRACTOR
SD	Automated Touchless Soap Dispenser	GJ-P19190	OWNER	CONTRACTOR
TPD	2-Roll Side-by-Side Toilet Paper Dispenser	56784	OWNER	CONTRACTOR

EQUIPMENT SCHEDULE GENERAL NOTES:  
1. COORDINATE FINAL INSTALLATION LOCATIONS WITH OWNER.

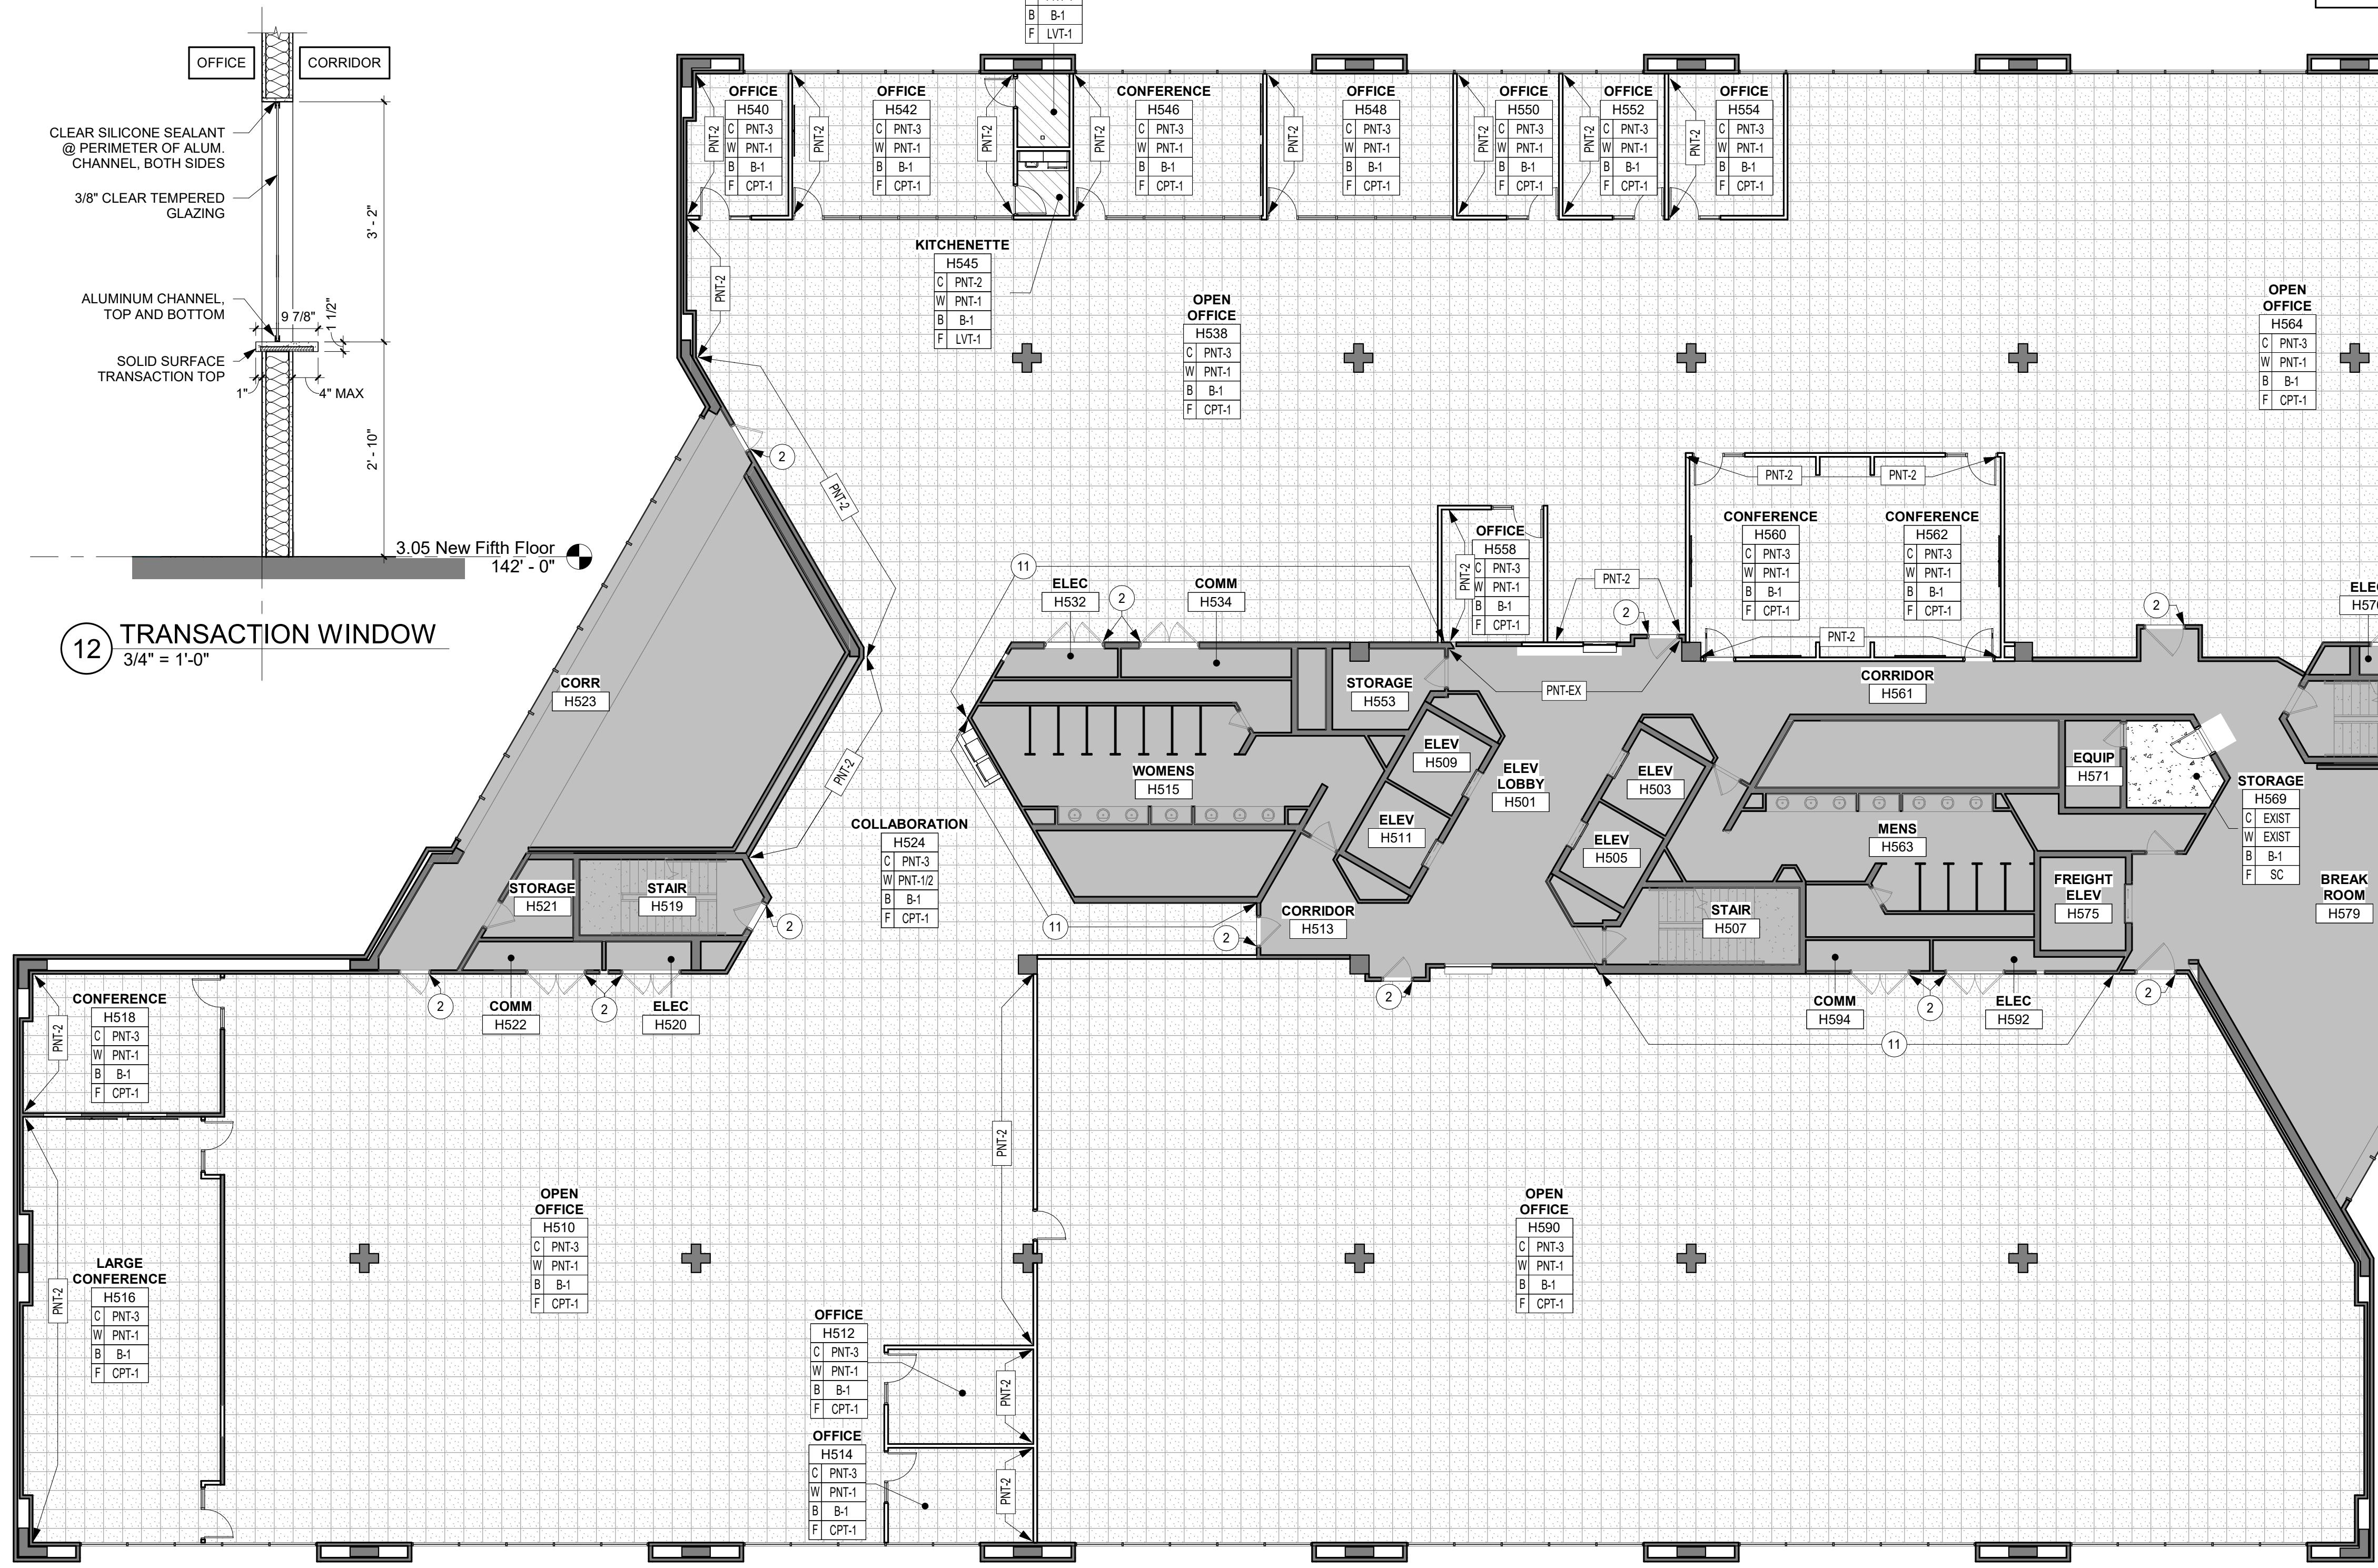13 LEVEL 5 FINISH PLAN  
3/32" = 1'-0"

**TYPICAL ANNOTATIONS**

**HVAC PIPING LEGEND**

**DUCTWORK SYMBOLS**

**DUCTWORK LEGEND**

**NOTES:**

- THIS DRAWING IS FOR INFORMATIONAL PURPOSES ONLY. ITEMS SHOWN ARE NOT NECESSARILY USED ON THIS PROJECT.
- DUCT SIZES SHOWN ARE SIDE DIMENSION OF SIDE SHOWN, THE SECOND NUMBER INDICATES SIDE NOT SHOWN.

**PIPING / EQUIPMENT LINE STYLES**

- EXISTING
- DEMOLISHED
- NEW

**SYMBOL LEGEND**

- CONNECT TO EXISTING
- (T) — THERMOSTAT
- (S) — TEMPERATURE SENSOR (DCC)
- (H) — HUMIDITY SENSOR
- (SD) — DUCT SMOKE DETECTOR
- (CO) — CARBON MONOXIDE SENSOR
- (CO<sub>2</sub>) — CARBON DIOXIDE SENSOR
- (NO<sub>2</sub>) — NITROGEN DIOXIDE SENSOR
- (P) — PRESSURE SENSOR

**GRILLE, REGISTER, DIFFUSER TAG**

GRILLE, REGISTER, DIFFUSER TYPE: **A-XX/XX** — DUCT INLET SIZE  
**CFM** — DESIGN CFM  
**EX / CFM** — DESIGN CFM

**PIPING TAGS**

NOMINAL PIPE SIZE  
**##"-XXX** — PIPE SYSTEM ABBREVIATION  
**##"-XXX (#)** — FIXTURE UNITS / FLOW

**PLUMBING PIPING LEGEND**

**DUCTWORK**

**DUCTWORK LEGEND**

**NOTES:**

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2. DO NOT SCALE DRAWINGS TO OBTAIN DIMENSIONS. WRITTEN DIMENSIONS GOVERN. NOTIFY ARCHITECT/ENGINEER OF ANY CHANGES.
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8. EXISTING CONDITIONS: A. CONDITIONS SHOWN ON THE DRAWINGS ARE AS ACCURATE AS COULD BE DETERMINED. THE CONTRACTOR SHALL OBTAIN EXACT LOCATIONS, SIZES, ELEVATIONS, ETC. AND SHALL SATISFACTORILY ADAPT THE NEW WORK TO THE EXISTING SITE CONDITIONS AS REQUIRED.
- B. SINGLE LINE (LIGHT GRAY) LINEWORK AS SHOWN REPRESENTS EXISTING FROM PREVIOUS CONSTRUCTION PROJECTS.
- C. OTHER UTILITIES, EQUIPMENT, AND ELEMENTS WHICH ARE NOT SHOWN AS EXISTING ARE NOT DRAWN. THIS INCLUDES BUT IS NOT LIMITED TO, PIPING AND DUCTWORK INSULATION, CONTROLS OF EQUIPMENT TO REMAIN IN OPERATION, ETC.
- D. ANY EXISTING CONSTRUCTION OR UTILITIES THAT ARE DAMAGED BY THE CONTRACTOR OR SUBCONTRACTORS SHALL BE REPAIRED OR REPLACED BY THE CONTRACTOR TO THE SATISFACTION OF THE OWNER AT NO ADDITIONAL COST. PATCH REPAIRS ARE NOT TO EXCEED 10% OF THE SURFACES AFFECTED BY THE NEW WORK.
- E. COORDINATE ALL FLOOR DRAIN LOCATIONS, ELEVATIONS AND FLOOR SLOPES WITH PRIME CONTRACTOR BEFORE BEGINNING WORK.
- F. EQUIPMENT AND MATERIALS MUST BE REMOVED FROM THE JOB SITE UNLESS WANTED FOR SALVAGE BY THE OWNER. OWNER RETAINS THE RIGHT TO KEEP ANY EQUIPMENT/MATERIALS UNMOVED FROM SITE WITH OWNER'S PERMISSION.
9. ANY PAINTED SURFACES AFFECTED BY NEW WORK THAT REQUIRES PATCHING OR REPAIR SHALL BE REPAINTED WITH A MINIMUM OF TWO COATS OF PAINT TO MATCH EXISTING ADJACENT COLOR. THIS WORK BY PRIME CONTRACTOR.
10. OTHER:
  - A. PATCH ALL WALL AND FLOOR OPENINGS LEFT BY ANY REMOVAL OF MECHANICAL ELEMENTS, INCLUDING PIPING AND DUCTWORK, FINISH TO MATCH ADJACENT OR EXISTING.
  - B. ANY HOLES OR OPENINGS CREATED IN THE ROOFING STRUCTURE AS A RESULT OF DEMOLITION OR NEW WORK SHALL BE REPAIRED OR REINFORCED BY THE CONTRACTOR TO THE SATISFACTION OF THE OWNER.
  - C. PROVIDE CONTINUOUS SEALANT AROUND ALL MATERIALS AT EXTERIOR WALL PENETRATIONS. SEAL ALL OPENINGS IN WALLS, FLOORS, CEILINGS AND ROOFS AROUND DUCTS, PIPES, VENTS, TRAPS, CONDUIT AND ALL OTHER PENETRATIONS.
  - D. MECHANICAL CONTRACTOR IS RESPONSIBLE FOR ALL SLEEVES AND/OR OPENINGS WHERE REQUIRED TO RUN NEW PIPING DUCTWORK, OR OTHER MECHANICAL ELEMENTS, EXCEPT WHERE OTHERWISE INDICATED. PENETRATION SEALANT RATING SHALL MATCH STRUCTURE RATING. COORDINATE WITH PRIME CONTRACTOR TO REPAIR/RESTORE AFFECTED OCCUPIED AREAS.
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  - F. WHERE OPENINGS ARE CUT THRU WALL PROVIDE STEEL ANGLE REINFORCING TO STABILIZE THE STRUCTURE.
  - G. OPENINGS FOR DUCTS AND ROUND DUCT THROUGH WALLS AND FLOORS SHALL BE NEATLY CUT AND GRUDED LARGE ENOUGH FOR INSULATION TO PASS THROUGH, SLEEVES AND GRUDED. PROVIDE FIRE CAULKING AND/OR F-S. DAMPERS AT RATED FLOORS AND WALLS.
  - 11. AREA OF EXPOSED MECHANICAL SYSTEMS SHALL BE PAINTED TO MATCH EXISTING CEILING, JOIST, AND DUCTWORK. PAINT CLEAN SURFACES THOROUGHLY. COLOR MATCHES PROVIDED TO COATING APPLICATIONS. UNPAINTED UNFINISHED LOUVERS, GRILLES, COVERS, AND ACCESS PANELS ON MECHANICAL AND ELECTRICAL COMPONENTS AND PAINT SEPARATELY. APPLY PRODUCTS IN ACCORDANCE WITH MANUFACTURER'S INSTRUCTIONS. REINSTALL ELECTRICAL COVER PLATES, HARDWARE, LIGHT FIXTURE, TRUE ESCUTCHEONS, AND FITTINGS REMOVED PRIOR TO FINISHING.
  - 12. PIPING:
    - A. ROUTE PIPING IN ORDERLY MANNER AND MAINTAIN GRADIENT. ROUTE PARALLEL AND PERPENDICULAR TO WALLS. INSTALL PIPING TO ALLOW FOR EXPANSION AND CONTRACTION WITHOUT STRESSING PIPE, JOINTS, OR CONNECTED EQUIPMENT. PROVIDE ACCESS WHEN VALVES AND FITTINGS ARE EXPOSED. PROVIDE PIPING SUPPORTS IN ACCORDANCE WITH LOW AMBIENT TEMPERATURE INSULATION SYSTEMS, INCLUDING FITTINGS, VALVES, UNIONS, FLANGES, STRAINERS, FLEXIBLE CONNECTIONS, PUMP BODIES, AND EXPANSION JOINTS. CONTINUE INSULATION THROUGH WALLS, SLEEVES, PIPE HANGERS, AND OTHER PIPE PENETRATIONS.
    - B. PIPING ABOVE SUSPENDED CEILINGS SHALL BE INSTALLED A MINIMUM OF 6" ABOVE THE CEILING LEVEL.
    - C. PROVIDE PIPING SUPPORT, AND EQUIPMENT SUPPORTS SHALL BE VERIFIED AND ADJUSTED TO MATCH THE ACTUAL EQUIPMENT PROVIDED.
    - D. ALL DISSIMILAR METALS SHALL BE EFFECTIVELY ISOLATED FROM EACH OTHER TO AVOID GALVANIC CORROSION.
  - 13. DUCTWORK:
    - A. PROVIDE METAL SUPPORT, AND SEAL DUCTS IN ACCORDANCE WITH SMACNA HVAC DUCT CONSTRUCTION STANDARDS - METAL AND FLEXIBLE, FLEXIBLE DUCTS: CONNECT TO METAL DUCTS WITH LIQUID ADHESIVE PLUS TAPE. VERIFY THAT DUCTS HAVE BEEN TESTED BEFORE APPLYING INSULATION MATERIALS.
    - B. PROVIDE DUCT ACCESS DOORS FOR INSPECTION AND CLEANING BEFORE AND AFTER FILTERS, COILS, FANS, AUTOMATIC VALVES, AND OTHER EQUIPMENT.
    - C. AT FANS AND MOTORIZED EQUIPMENT ASSOCIATED WITH DUCTS, PROVIDE FLEXIBLE DUCT CONNECTIONS IMMEDIATELY ADJACENT TO THE EQUIPMENT.
    - D. PROVIDE BALANCING DAMPERS ON DUCTWORK CONNECTED TO DIFFUSERS, GRILLES, AND REGISTERS, REGARDLESS OF WHETHER THE DUCTWORK IS CONNECTED TO THE DIFFUSER, GRILLE, OR REGISTER ASSEMBLY. PROVIDE ADDITIONAL BALANCING DAMPERS WHERE NECESSARY TO BALANCE DIFFUSER AIR FLOWS.
  - 14. PROVIDE PHASING SCHEDULE TO OWNERS SHOWING AREAS OF WORK AND HVAC INTERRUPTIONS TO MINIMIZE DOWNTIME.
  - 15. SEAL AND FIRE CAULK ALL PENETRATIONS AS NECESSARY TO MAINTAIN FIRE RATING.
  - 16. ALL TRADES SHALL HAVE PRE-WORK CONFERENCE AND COORDINATION TO SCHEDULE WORK, PLAN WORK, DETAIL WORK TO PROVIDE CLEAN, COMPACT, AND THOUGHTFUL CONSIDERED LAYOUT OF EQUIPMENT, DUCT, CONDUIT, PIPE, ETC.
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**PIPING SYMBOLS**

**PIPING TAGS**

**KEYNOTE**

**REVISION NUMBER**

**DETAIL NUMBER ON SHEET**

**SPOT ELEVATION (BOTTOM OF ELEMENT)**

**NOTES:**

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  - 11. AREA OF EXPOSED MECHANICAL SYSTEMS SHALL BE PAINTED TO MATCH EXISTING CEILING, JOIST, AND DUCTWORK. PAINT CLEAN SURFACES THOROUGHLY. COLOR MATCHES PROVIDED TO COATING APPLICATIONS. UNPAINTED UNFINISHED LOUVERS, GRILLES, COVERS, AND ACCESS PANELS ON MECHANICAL AND ELECTRICAL COMPONENTS AND PAINT SEPARATELY. APPLY PRODUCTS IN ACCORDANCE WITH MANUFACTURER'S INSTRUCTIONS. REINSTALL ELECTRICAL COVER PLATES, HARDWARE, LIGHT FIXTURE, TRUE ESCUTCHEONS, AND FITTINGS REMOVED PRIOR TO FINISHING.
  - 12. PIPING:
    - A. ROUTE PIPING IN ORDERLY MANNER AND MAINTAIN GRADIENT. ROUTE PARALLEL AND PERPENDICULAR TO WALLS. INSTALL PIPING TO ALLOW FOR EXPANSION AND CONTRACTION WITHOUT STRESSING PIPE, JOINTS, OR CONNECTED EQUIPMENT. PROVIDE ACCESS WHEN VALVES AND FITTINGS ARE EXPOSED. PROVIDE PIPING SUPPORTS IN ACCORDANCE WITH LOW AMBIENT TEMPERATURE INSULATION SYSTEMS, INCLUDING FITTINGS, VALVES, UNIONS, FLANGES, STRAINERS, FLEXIBLE CONNECTIONS, PUMP BODIES, AND EXPANSION JOINTS. CONTINUE INSULATION THROUGH WALLS, SLEEVES, PIPE HANGERS, AND OTHER PIPE PENETRATIONS.
    - B. PIPING ABOVE SUSPENDED CEILINGS SHALL BE INSTALLED A MINIMUM OF 6" ABOVE THE CEILING LEVEL.
    - C. PROVIDE PIPING SUPPORT, AND EQUIPMENT SUPPORTS SHALL BE VERIFIED AND ADJUSTED TO MATCH THE ACTUAL EQUIPMENT PROVIDED.
    - D. ALL DISSIMILAR METALS SHALL BE EFFECTIVELY ISOLATED FROM EACH OTHER TO AVOID GALVANIC CORROSION.
  - 13. DUCTWORK:
    - A. PROVIDE METAL SUPPORT, AND SEAL DUCTS IN ACCORDANCE WITH SMACNA HVAC DUCT CONSTRUCTION STANDARDS - METAL AND FLEXIBLE, FLEXIBLE DUCTS: CONNECT TO METAL DUCTS WITH LIQUID ADHESIVE PLUS TAPE. VERIFY THAT DUCTS HAVE BEEN TESTED BEFORE APPLYING INSULATION MATERIALS.
    - B. PROVIDE DUCT ACCESS DOORS FOR INSPECTION AND CLEANING BEFORE AND AFTER FILTERS, COILS, FANS, AUTOMATIC VALVES, AND OTHER EQUIPMENT.
    - C. AT FANS AND MOTORIZED EQUIPMENT ASSOCIATED WITH DUCTS, PROVIDE FLEXIBLE DUCT CONNECTIONS IMMEDIATELY ADJACENT TO THE EQUIPMENT.
    - D. PROVIDE BALANCING DAMPERS ON DUCTWORK CONNECTED TO DIFFUSERS, GRILLES, AND REGISTERS, REGARDLESS OF WHETHER THE DUCTWORK IS CONNECTED TO THE DIFFUSER, GRILLE, OR REGISTER ASSEMBLY. PROVIDE ADDITIONAL BALANCING DAMPERS WHERE NECESSARY TO BALANCE DIFFUSER AIR FLOWS.
  - 14. PROVIDE PHASING SCHEDULE TO OWNERS SHOWING AREAS OF WORK AND HVAC INTERRUPTIONS TO MINIMIZE DOWNTIME.
  - 15. SEAL AND FIRE CAULK ALL PENETRATIONS AS NECESSARY TO MAINTAIN FIRE RATING.
  - 16. ALL TRADES SHALL HAVE PRE-WORK CONFERENCE AND COORDINATION TO SCHEDULE WORK, PLAN WORK, DETAIL WORK TO PROVIDE CLEAN, COMPACT, AND THOUGHTFUL CONSIDERED LAYOUT OF EQUIPMENT, DUCT, CONDUIT, PIPE, ETC.
  - 17. ALL TRADES SHALL HAVE PRE-WORK CONFERENCE AND COORDINATION TO SCHEDULE WORK, PLAN WORK, DETAIL WORK TO PROVIDE CLEAN, COMPACT, AND THOUGHTFUL CONSIDERED LAYOUT OF EQUIPMENT, DUCT, CONDUIT, PIPE, ETC.

**PIPING SYMBOLS**

**PIPING TAGS**

**KEYNOTE**

**REVISION NUMBER**

**DETAIL NUMBER ON SHEET**

**SPOT ELEVATION (BOTTOM OF ELEMENT)**

**NOTES:**

**GENERAL MECHANICAL / PLUMBING NOTES:**

1. CONTRACT DOCUMENTS SHALL BE ISSUED TO ALL SUBCONTRACTORS BY THE PRIME CONTRACTOR IN COMPLETE SETS IN ORDER TO ACHIEVE THE FULL EXTENT AND COMPLETE COORDINATION OF ALL WORK.
2. DO NOT SCALE DRAWINGS TO OBTAIN DIMENSIONS. WRITTEN DIMENSIONS GOVERN. NOTIFY ARCHITECT/ENGINEER OF ANY CHANGES.
3. ALL WORK SHALL CONFORM TO THE REQUIREMENTS OF ALL APPLICABLE LOCAL, STATE, AND NATIONAL LAWS, CODES, ORDINANCES, AND REGULATIONS, AS WELL AS LOCAL UTILITY REQUIREMENTS. PROVIDE ALL ADDITIONAL ACCESSORIES EQUIPMENT AND OTHER WORK NECESSARY FOR A PROPER AND OPERATIONAL INSTALLATION, TO SATISFY WARRANTY REQUIREMENTS, CONTRACTOR STANDARDS, VERIFIED THAT EQUIPMENT PROVIDED IS SUITABLE FOR INTENDED USE. INSTALL ALL EQUIPMENT IN ACCORDANCE WITH MANUFACTURER'S INSTRUCTIONS.
4. MECHANICAL/PLUMBING DRAWINGS ARE DIAGRAMMATIC IN NATURE. VERIFY EXISTING CONDITIONS AND COORDINATE WITH OTHER TRADES. ARCHITECTURAL DRAWINGS AND STRUCTURAL DRAWINGS.
5. WORK NOT SPECIFICALLY SHOWN IN DETAIL, INCLUDING REINFORCING, SHALL BE PROVIDED IN ACCORDANCE WITH THE TRADE OR INDUSTRY BEST STANDARD PRACTICE TO PROVIDE A COMPLETE INSTALLATION.
6. COORDINATE CLOSELY BETWEEN MECHANICAL AND PLUMBING CONTRACTORS TO UTILIZE THE SAME SUPPORTS WHERE POSSIBLE.
7. ALL EQUIPMENT, PIPING, AND DUCTWORK SHALL BE ROUTED TO AVOID CONFLICTS WITH STRUCTURE, OTHER PIPING, ETC. UNLESS SPECIFICALLY DIMENSIONED, THE PIPE AND DUCTWORK SHOWN INDICATES GENERAL LOCATION ONLY. CONTRACTOR SHALL COORDINATE.
8. EXISTING CONDITIONS: A. CONDITIONS SHOWN ON THE DRAWINGS ARE AS ACCURATE AS COULD BE DETERMINED. THE CONTRACTOR SHALL OBTAIN EXACT LOCATIONS, SIZES, ELEVATIONS, ETC. AND SHALL SATISFACTORILY ADAPT THE NEW WORK TO THE EXISTING SITE CONDITIONS AS REQUIRED.
- B. SINGLE LINE (LIGHT GRAY) LINEWORK AS SHOWN REPRESENTS EXISTING FROM PREVIOUS CONSTRUCTION PROJECTS.
- C. OTHER UTILITIES, EQUIPMENT, AND ELEMENTS WHICH ARE NOT SHOWN AS EXISTING ARE NOT DRAWN. THIS INCLUDES BUT IS NOT LIMITED TO, PIPING AND DUCTWORK INSULATION, CONTROLS OF EQUIPMENT TO REMAIN IN OPERATION, ETC.
- D. ANY EXISTING CONSTRUCTION OR UTILITIES THAT ARE DAMAGED BY THE CONTRACTOR OR SUBCONTRACTORS SHALL BE REPAIRED OR REPLACED BY THE CONTRACTOR TO THE SATISFACTION OF THE OWNER AT NO ADDITIONAL COST. PATCH REPAIRS ARE NOT TO EXCEED 10% OF THE SURFACES AFFECTED BY THE NEW WORK.
- E. COORDINATE ALL FLOOR DRAIN LOCATIONS, ELEVATIONS AND FLOOR SLOPES WITH PRIME CONTRACTOR BEFORE BEGINNING WORK.
- F. EQUIPMENT AND MATERIALS MUST BE REMOVED FROM THE JOB SITE UNLESS WANTED FOR SALVAGE BY THE OWNER. OWNER RETAINS THE RIGHT TO KEEP ANY EQUIPMENT/MATERIALS UNMOVED FROM SITE WITH OWNER'S PERMISSION.
9. ANY PAINTED SURFACES AFFECTED BY NEW WORK THAT REQUIRES PATCHING OR REPAIR SHALL BE REPAINTED WITH A MINIMUM OF TWO COATS OF PAINT TO MATCH EXISTING ADJACENT COLOR. THIS WORK BY PRIME CONTRACTOR.
10. OTHER:
  - A. PATCH ALL WALL AND FLOOR OPENINGS LEFT BY ANY REMOVAL OF MECHANICAL ELEMENTS, INCLUDING PIPING AND DUCTWORK, FINISH TO MATCH ADJACENT OR EXISTING.
  - B. ANY HOLES OR OPENINGS CREATED IN THE ROOFING STRUCTURE AS A RESULT OF DEMOLITION OR NEW WORK SHALL BE REPAIRED OR REINFORCED BY THE CONTRACTOR TO THE SATISFACTION OF THE OWNER.
  - C. PROVIDE CONTINUOUS SEALANT AROUND ALL MATERIALS AT EXTERIOR WALL PENETRATIONS. SEAL ALL OPENINGS IN WALLS, FLOORS, CEILINGS AND ROOFS AROUND DUCTS, PIPES, VENTS, TRAPS, CONDUIT AND ALL OTHER PENETRATIONS.
  - D. MECHANICAL CONTRACTOR IS RESPONSIBLE FOR ALL SLEEVES AND/OR OPENINGS WHERE REQUIRED TO RUN NEW PIPING DUCTWORK, OR OTHER MECHANICAL ELEMENTS, EXCEPT WHERE OTHERWISE INDICATED. PENETRATION SEALANT RATING SHALL MATCH STRUCTURE RATING. COORDINATE WITH PRIME CONTRACTOR TO REPAIR/RESTORE AFFECTED OCCUPIED AREAS.
  - E. OPENINGS FOR DUCTWORK THROUGH WALLS AND FLOORS SHALL BE NEATLY SAW-CUT WITH A MAXIMUM OVER CUT OF 1" AROUND REQUIRED DUCT OPENINGS. REPAIR ALL AREAS AROUND PENETRATIONS WITH BACK-UP WALL AND FINISH TO MATCH EXISTING. DO NOT REDUCE INSULATION THICKNESS WHERE DUCT PASSES THROUGH OPENINGS.
  - F. WHERE OPENINGS ARE CUT THRU WALL PROVIDE STEEL ANGLE REINFORCING TO STABILIZE THE STRUCTURE.
  - G. OPENINGS FOR DUCTS AND ROUND DUCT THROUGH WALLS AND FLOORS SHALL BE NEATLY CUT AND GRUDED LARGE ENOUGH FOR INSULATION TO PASS THROUGH, SLEEVES AND GRUDED. PROVIDE FIRE CAULKING AND/OR F-S. DAMPERS AT RATED FLOORS AND WALLS.
  - 11. AREA OF EXPOSED MECHANICAL SYSTEMS SHALL BE PAINTED TO MATCH EXISTING CEILING, JOIST, AND DUCTWORK. PAINT CLEAN SURFACES THOROUGHLY. COLOR MATCHES PROVIDED TO COATING APPLICATIONS. UNPAINTED UNFINISHED LOUVERS, GRILLES, COVERS, AND ACCESS PANELS ON MECHANICAL AND ELECTRICAL COMPONENTS AND PAINT SEPARATELY. APPLY PRODUCTS IN ACCORDANCE WITH MANUFACTURER'S INSTRUCTIONS. REINSTALL ELECTRICAL COVER PLATES, HARDWARE, LIGHT FIXTURE, TRUE ESCUTCHEONS, AND FITTINGS REMOVED PRIOR TO FINISHING.
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5. WORK NOT SPECIFICALLY SHOWN IN DETAIL,


**SHEET NOTES**

1. FIELD VERIFY ALL SITE CONDITIONS BEFORE STARTING CONSTRUCTION.
2. ALL EXISTING DUCTWORK, PIPING, EQUIPMENT, ETC. INDICATED ON PLANS ARE BASED ON INFORMATION FROM CONSTRUCTION DOCUMENTS AND FIELD VERIFICATION OF EXISTING BUILDING.
3. COORDINATE INSTALLATION OF ALL NEW DUCTWORK, PIPING, EQUIPMENT, ETC. WITH OTHER TRADES.

**ISG**

**KEYNOTE LEGEND**

D1 REMOVE AND DISPOSE OF EXISTING CONNECTION BETWEEN DOMESTIC HOT WATER MAIN AND DOMESTIC HOT WATER RECIRCULATION PIPING. PREPARE FOR NEW CONNECTION.

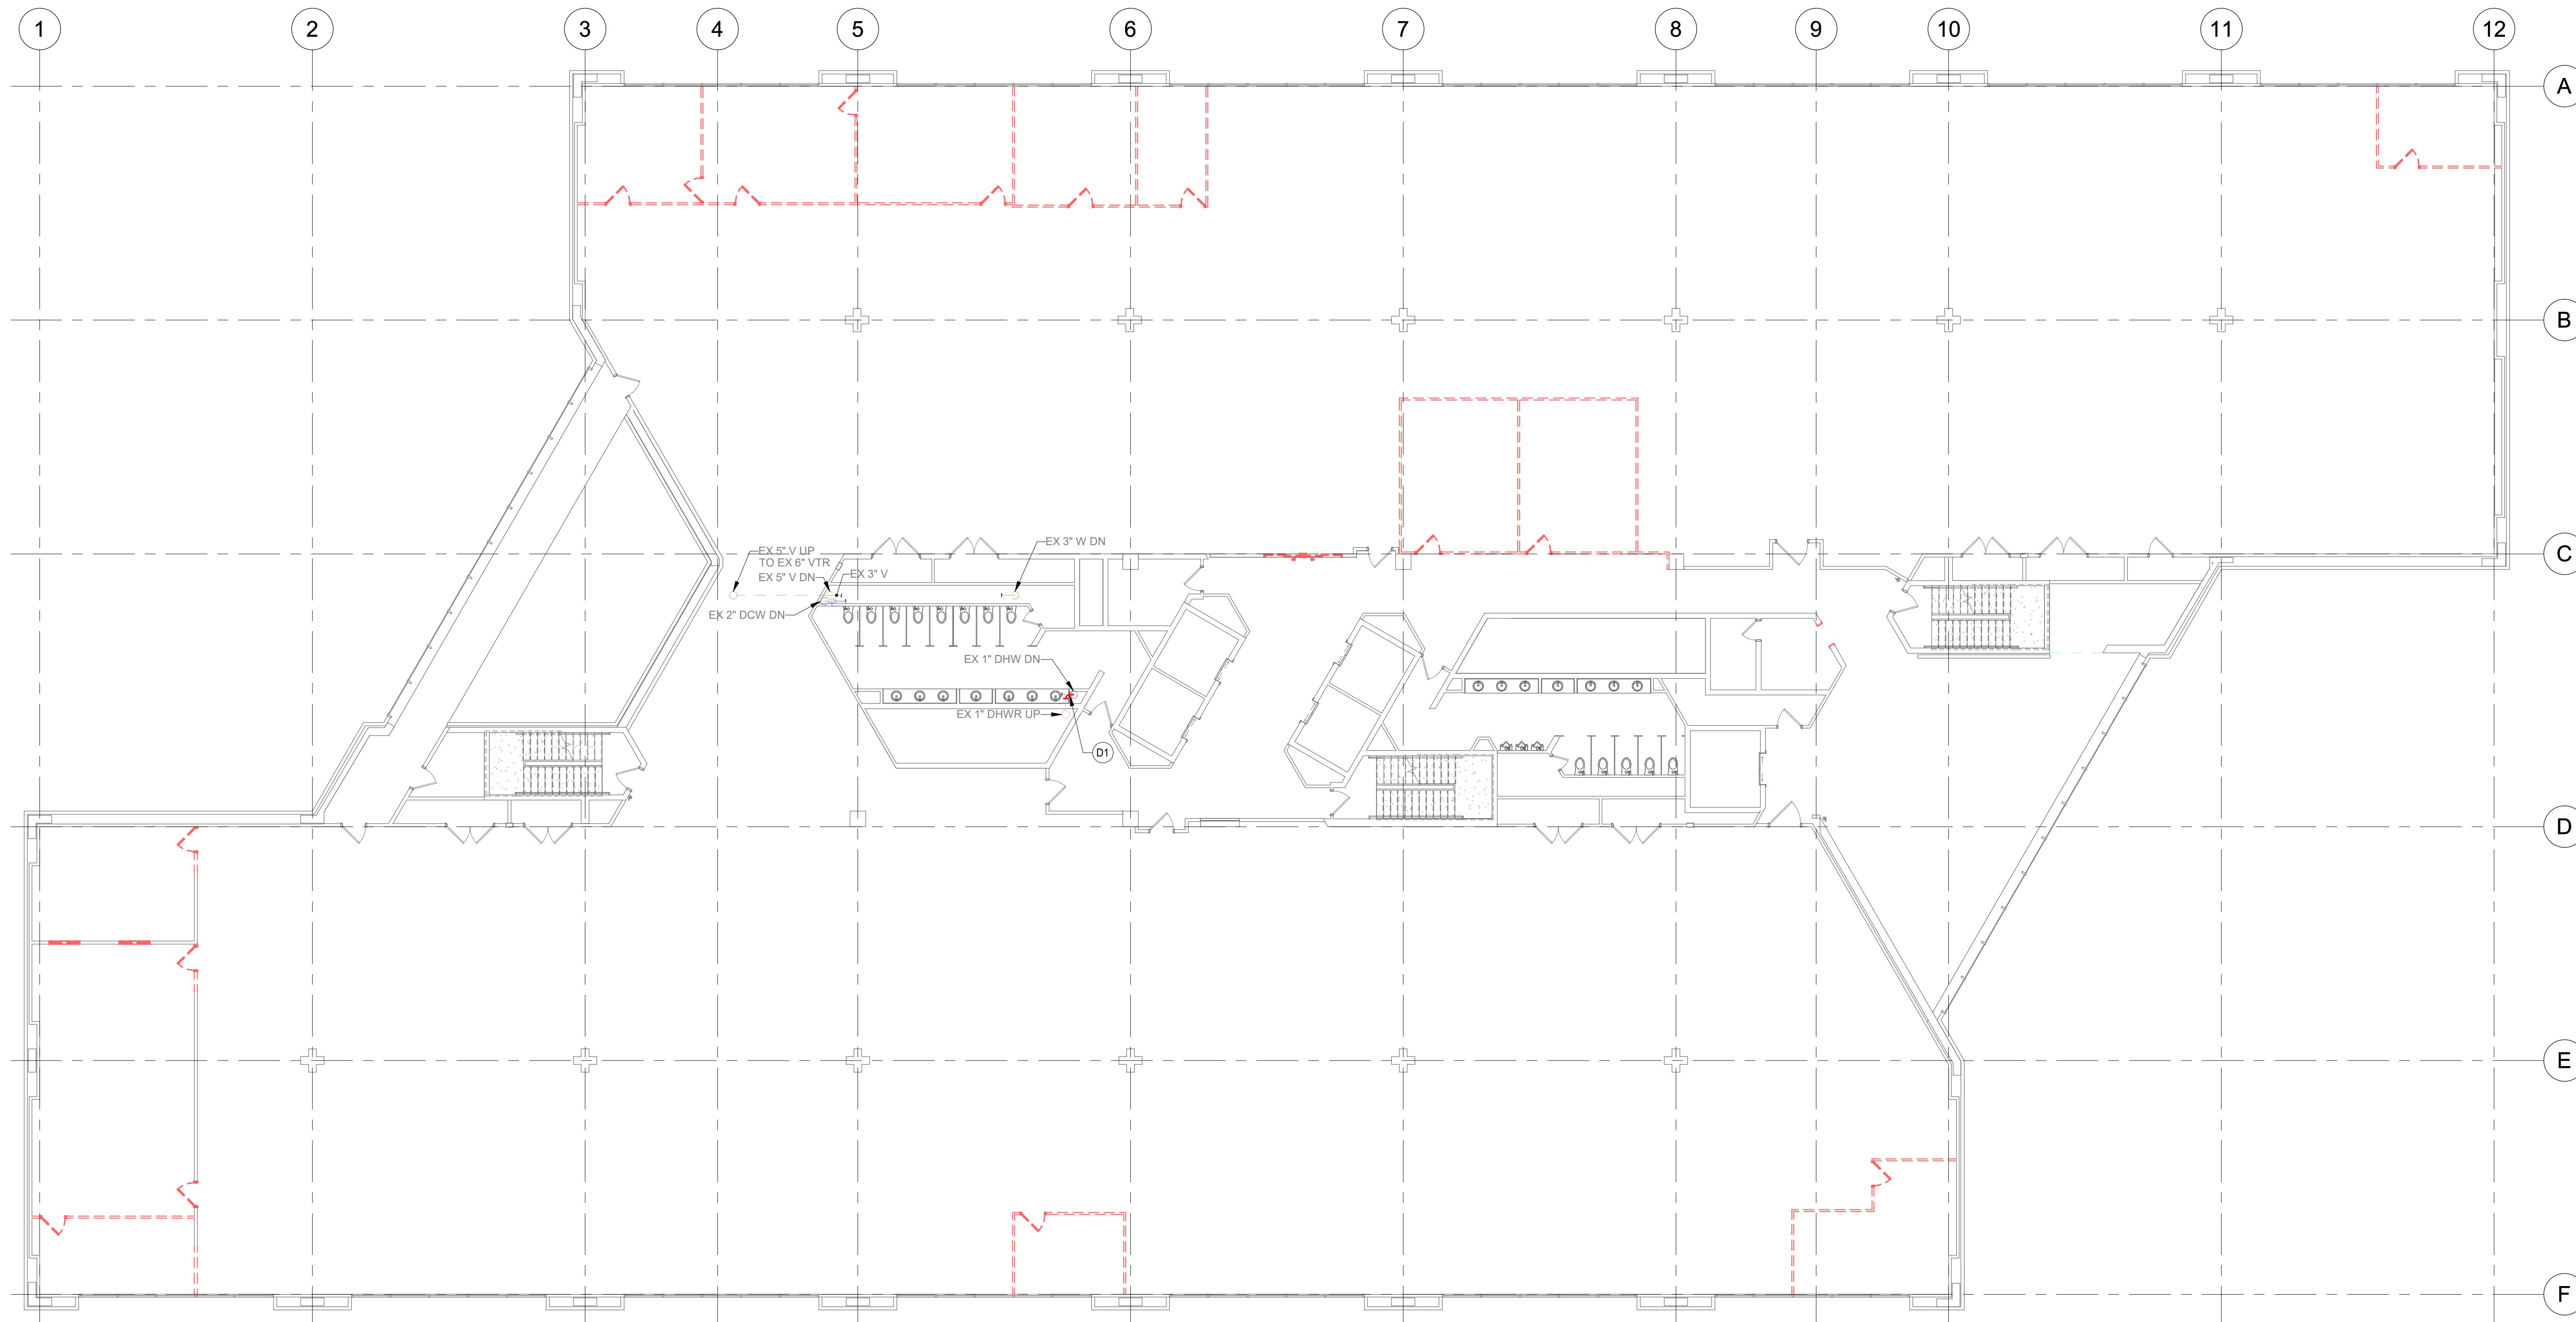

1 FIFTH FLOOR PLUMBING DEMOLITION PLAN  
3/32" = 1'-0"

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PROJECT

**DAS CC IDALS  
HOOVER  
5TH FLOOR  
RENOVATION**

DES MOINES IOWA

REVISION SCHEDULE		
DATE	DESCRIPTION	BY

PROJECT NO. 24-31954  
FILE NAME 31954 Mech R24  
DRAWN BY JKS  
DESIGNED BY JKS  
REVIEWED BY AWP  
ORIGINAL ISSUE DATE 01/21/25  
CLIENT PROJECT NO. 9426.00

TITLE


**FIFTH FLOOR  
PLUMBING  
DEMOLITION  
PLAN**

SHEET

**P1-11**

SHEET NOTES	
1.	FIELD VERIFY ALL SITE CONDITIONS BEFORE STARTING CONSTRUCTION.
2.	ALL EXISTING DUCTWORK, PIPING, EQUIPMENT, ETC. INDICATED ON PLANS ARE BASED ON INFORMATION FROM CONSTRUCTION DOCUMENTS AND FIELD VERIFICATION OF EXISTING BUILDING.
3.	DO NOT START CONSTRUCTION OF ALL NEW DUCTWORK, PIPING, EQUIPMENT, ETC. WITH OTHER TRADES.
4.	ALL WORK ON FOURTH FLOOR SHALL BE DONE AT NIGHT OR JOURNEYS WEEKEND TO AVOID DISTURBING OFFICE COORDINATE WITH OWNER AND PRIME CONTRACTOR.
5.	REMOVE AND REINSTALL 4TH FLOOR CEILING TILES ONLY AS REQUIRED FOR NEW WORK. ENSURE TILES ARE INSTALLED PROPERLY AND LAYING FLAT WHEN WORK IS COMPLETE.

KEYNOTE LEGEND	
P5	CONNECT NEW 4" SANITARY WASTE INTO EXISTING 4" SANITARY WASTE.

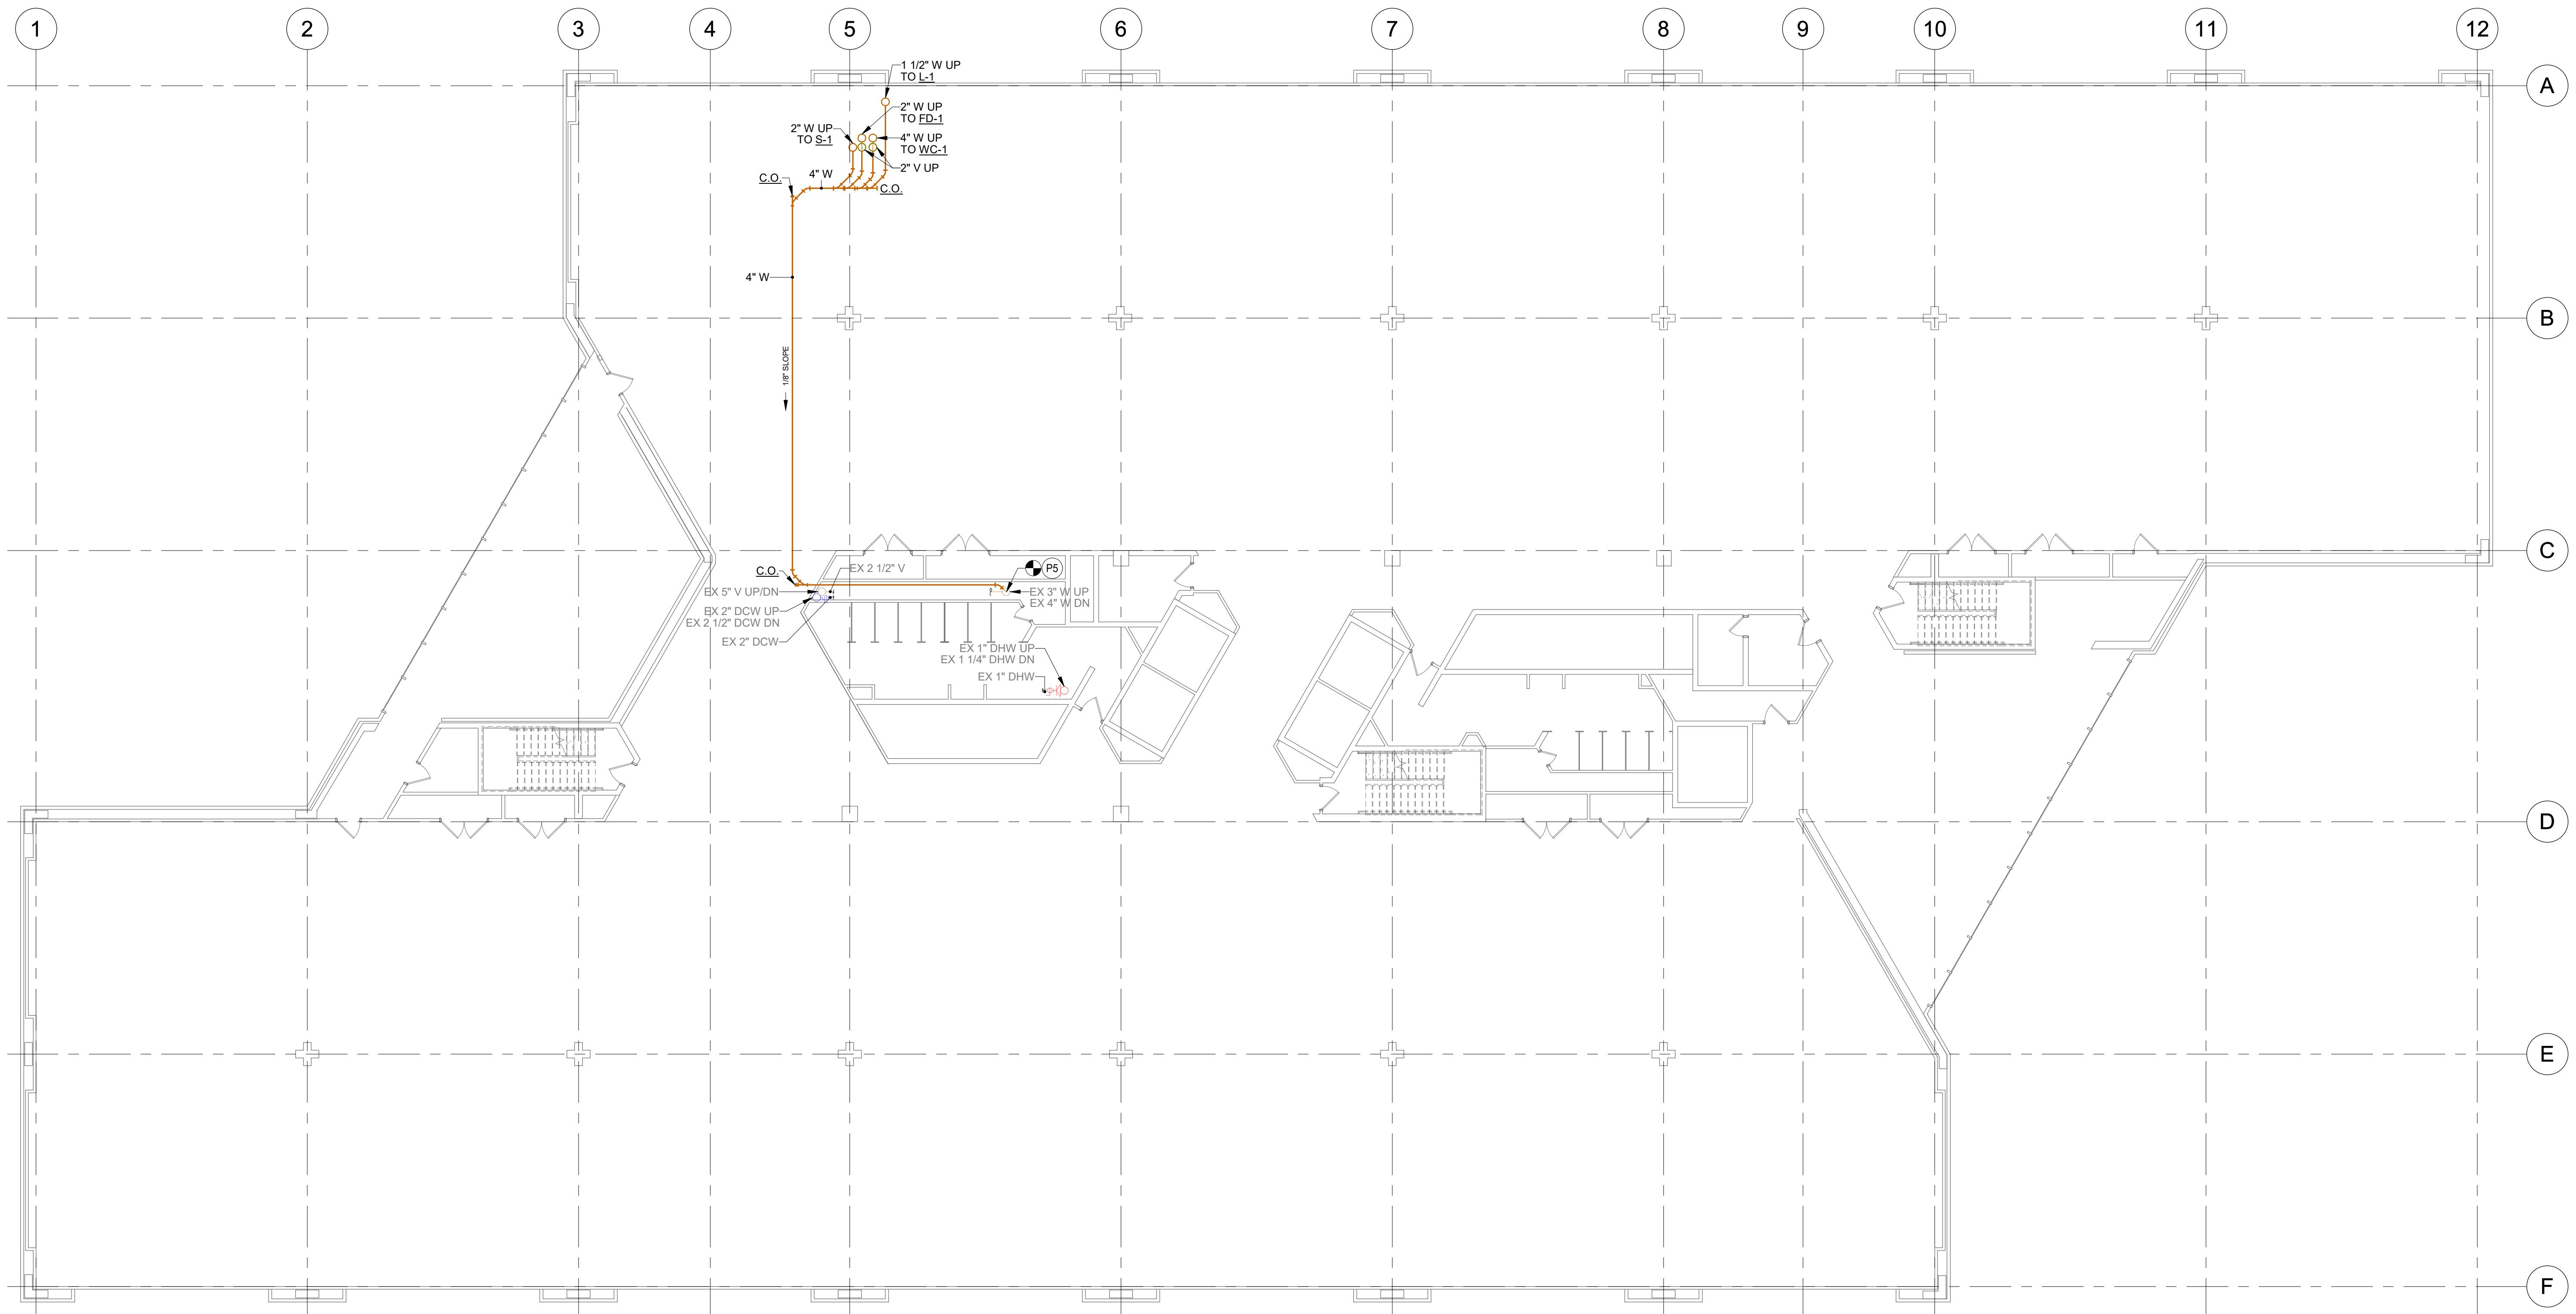

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PROJECT  
**DAS CC IDALS  
HOOVER  
5TH FLOOR  
RENOVATION**  
DES MOINES IOWA

REVISION SCHEDULE  
DATE DESCRIPTION BY

PROJECT NO. 24-31954  
FILE NAME 31954 Mech R24  
DRAWN BY JKS  
DESIGNED BY JKS  
REVIEWED BY AWP  
ORIGINAL ISSUE DATE 01/21/25  
CLIENT PROJECT NO. 9426.00

TITLE

**FOURTH FLOOR  
PLUMBING PLAN**

N  
SHEET  
**P2-10**




## **SHEET NOTES**


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2. ALL EXISTING DUCTWORK, PIPING, EQUIPMENT, ETC. INDICATED ON PLANS ARE BASED ON INFORMATION FROM CONSTRUCTION DOCUMENTS AND FIELD VERIFICATION OF EXISTING BUILDING.
3. COORDINATE INSTALLATION OF ALL NEW DUCTWORK, PIPING, EQUIPMENT, ETC. WITH OTHER TRADES.

# KEYNOTE LEGEND

CONNECT NEW 2" VENT INTO EXISTING 5" VENT.
CONNECT NEW 2" DOMESTIC COLD WATER INTO EXISTING 2" DOMESTIC COLD WATER.
CONNECT NEW 1" DOMESTIC HOT WATER TO EXISTING 1" DOMESTIC HOT WATER.
CONNECT NEW 1" DOMESTIC HOT WATER RETURN TO EXISTING 1" DOMESTIC HOT WATER RETURN.
COORDINATE FINAL LOCATION TO AVOID EXISTING STRUCTURE.

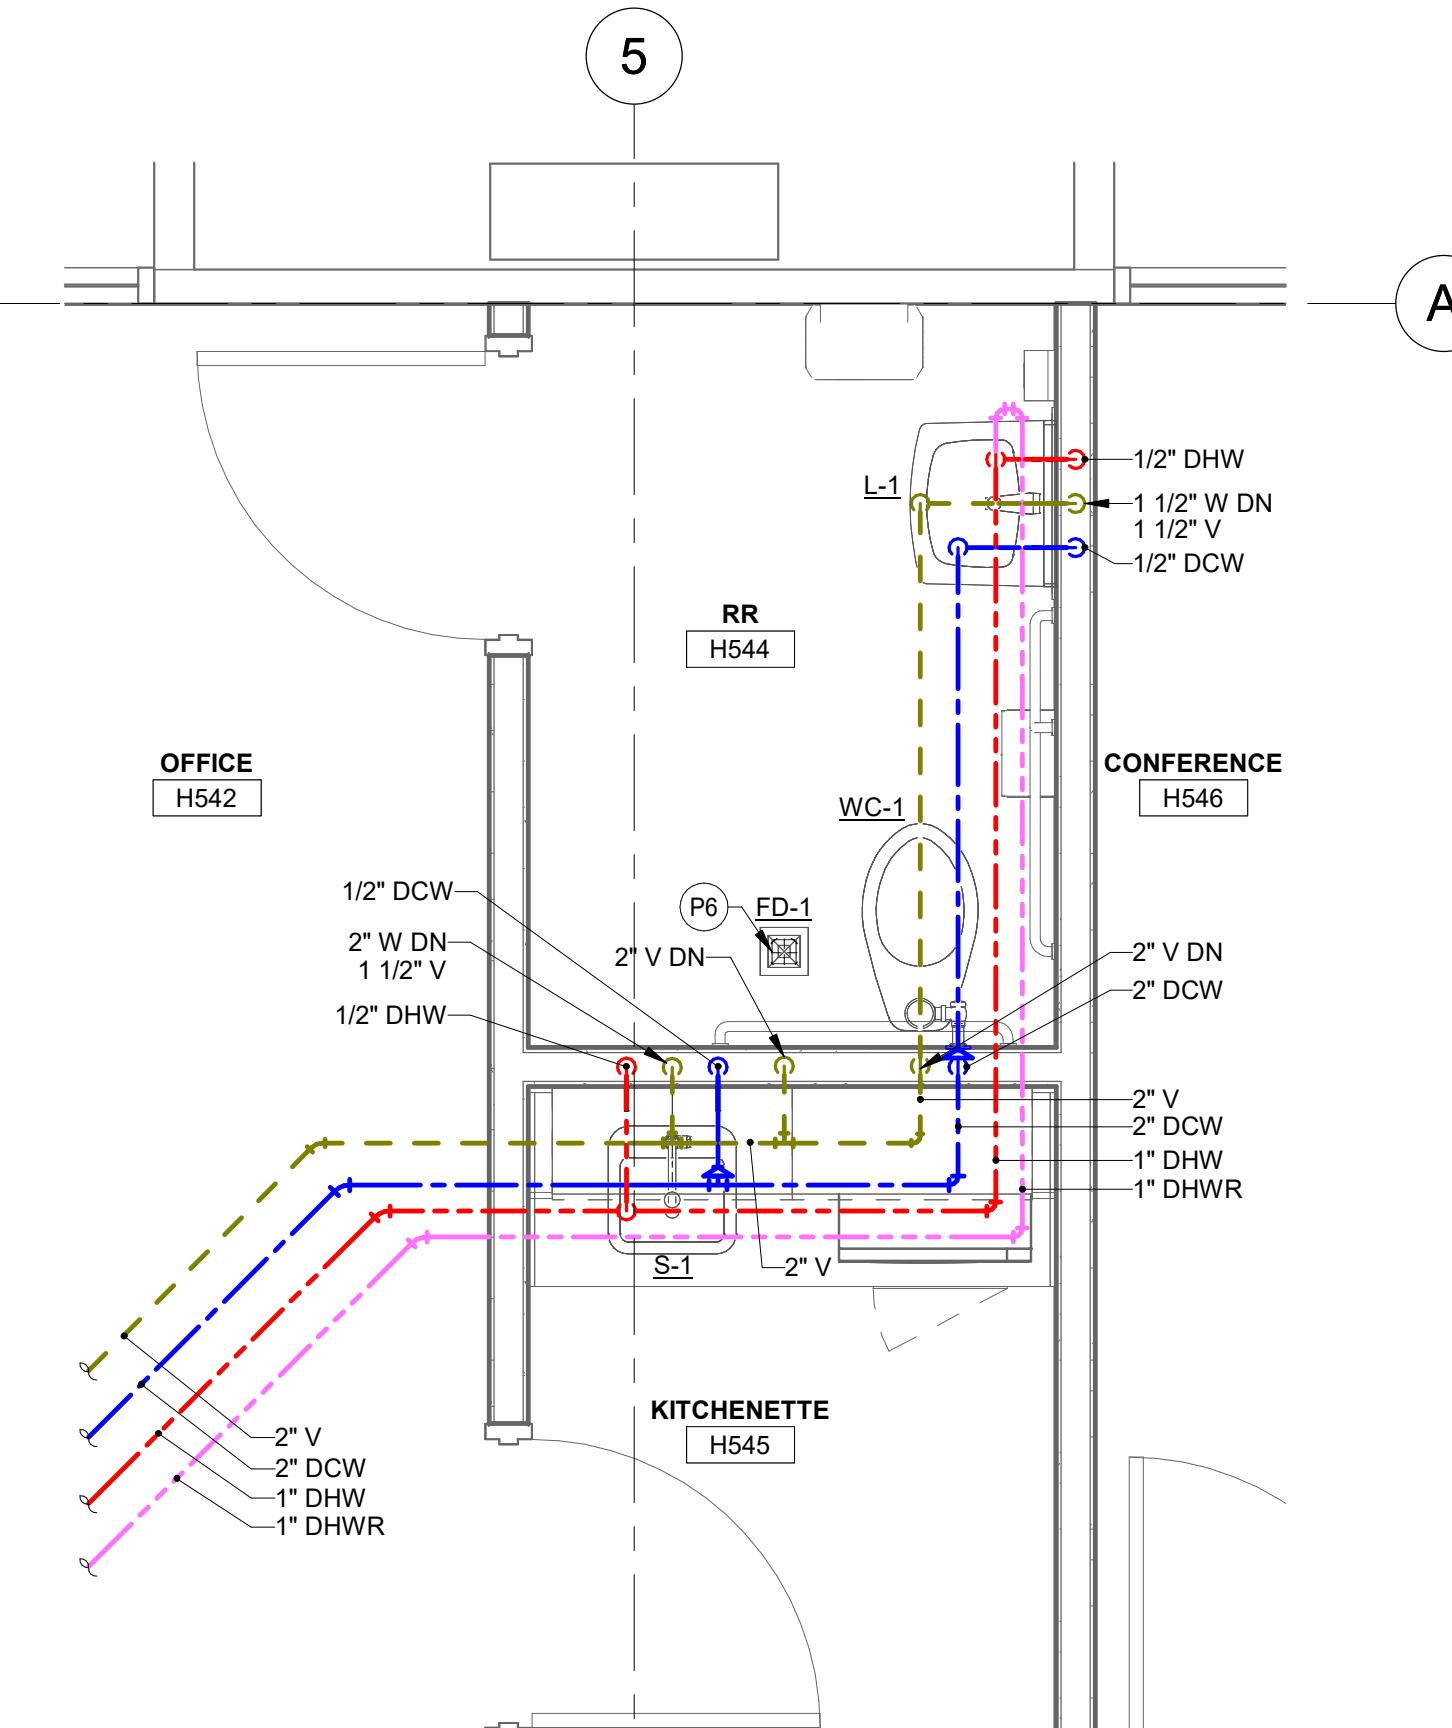

**2** FIFTH FLOOR ENLARGED PLUMBING PLAN  
1/2" = 1'-0"

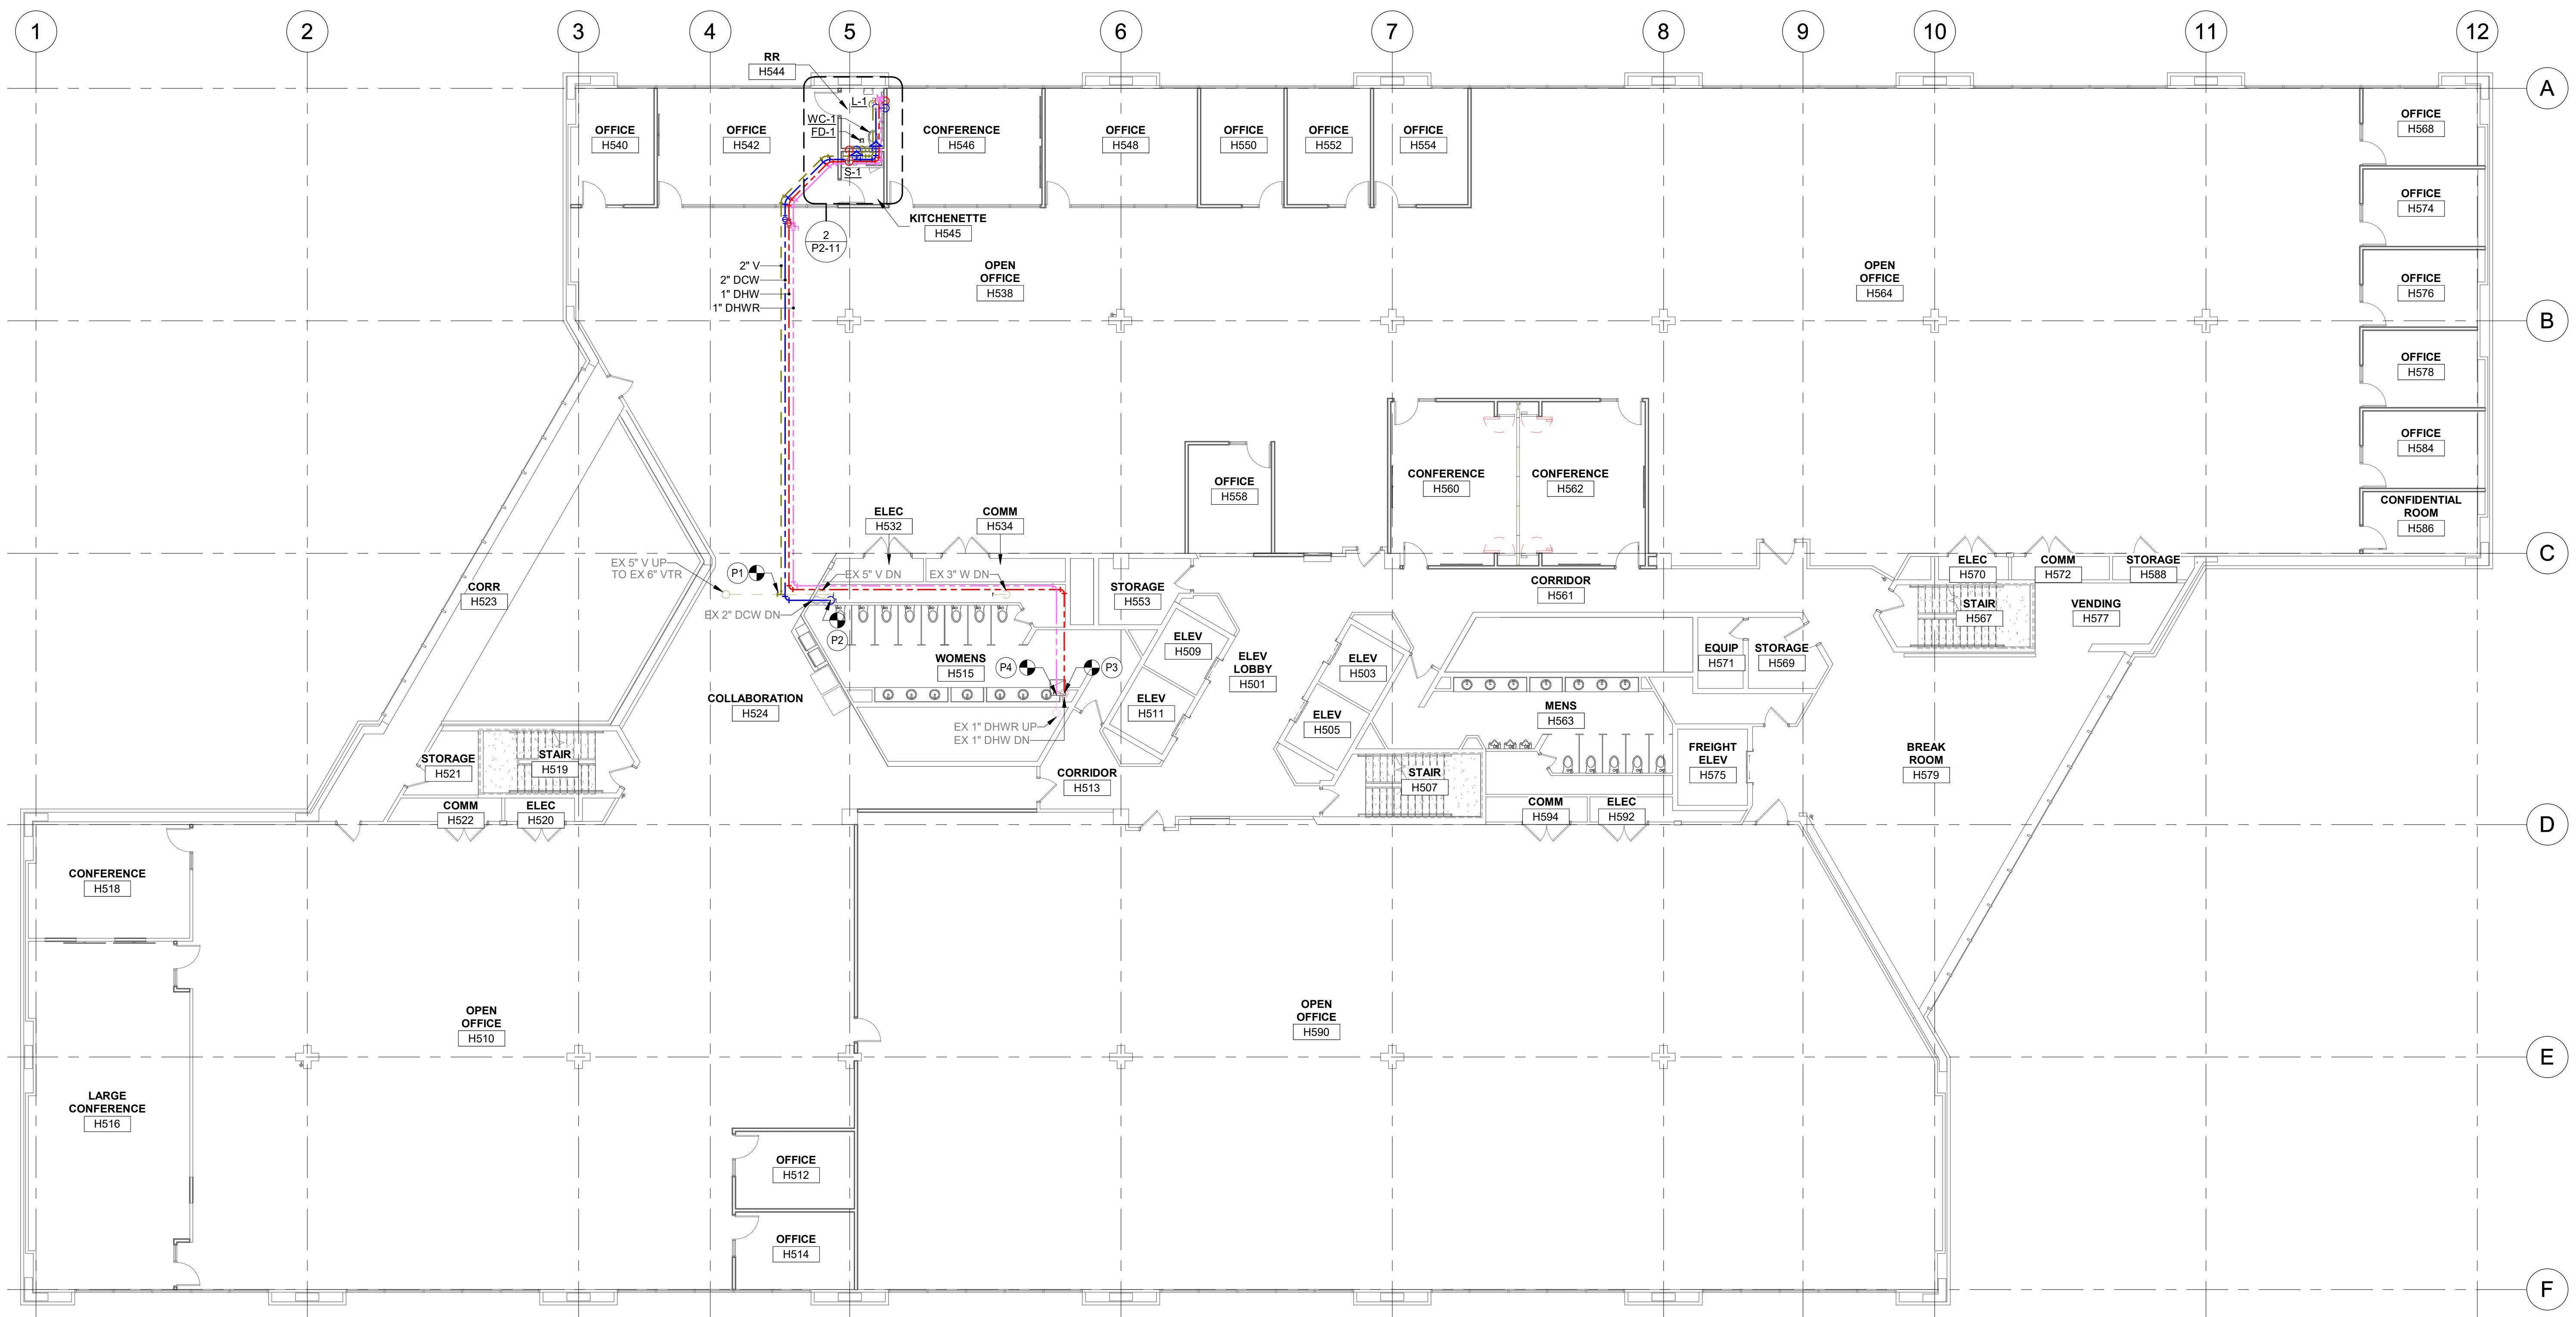

1 FIFTH FLOOR PLUMBING PLAN  
3/32" = 1'-0"

**SHEET NOT VALID UNLESS THIS TEXT IS COLOR.**

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# **DAS CC IDALS HOOVER 5TH FLOOR RENOVATION**


DES MOINES IOWA

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DRAWN BY	JKS
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## TITLE

# **FIFTH FLOOR PLUMBING PLAN**


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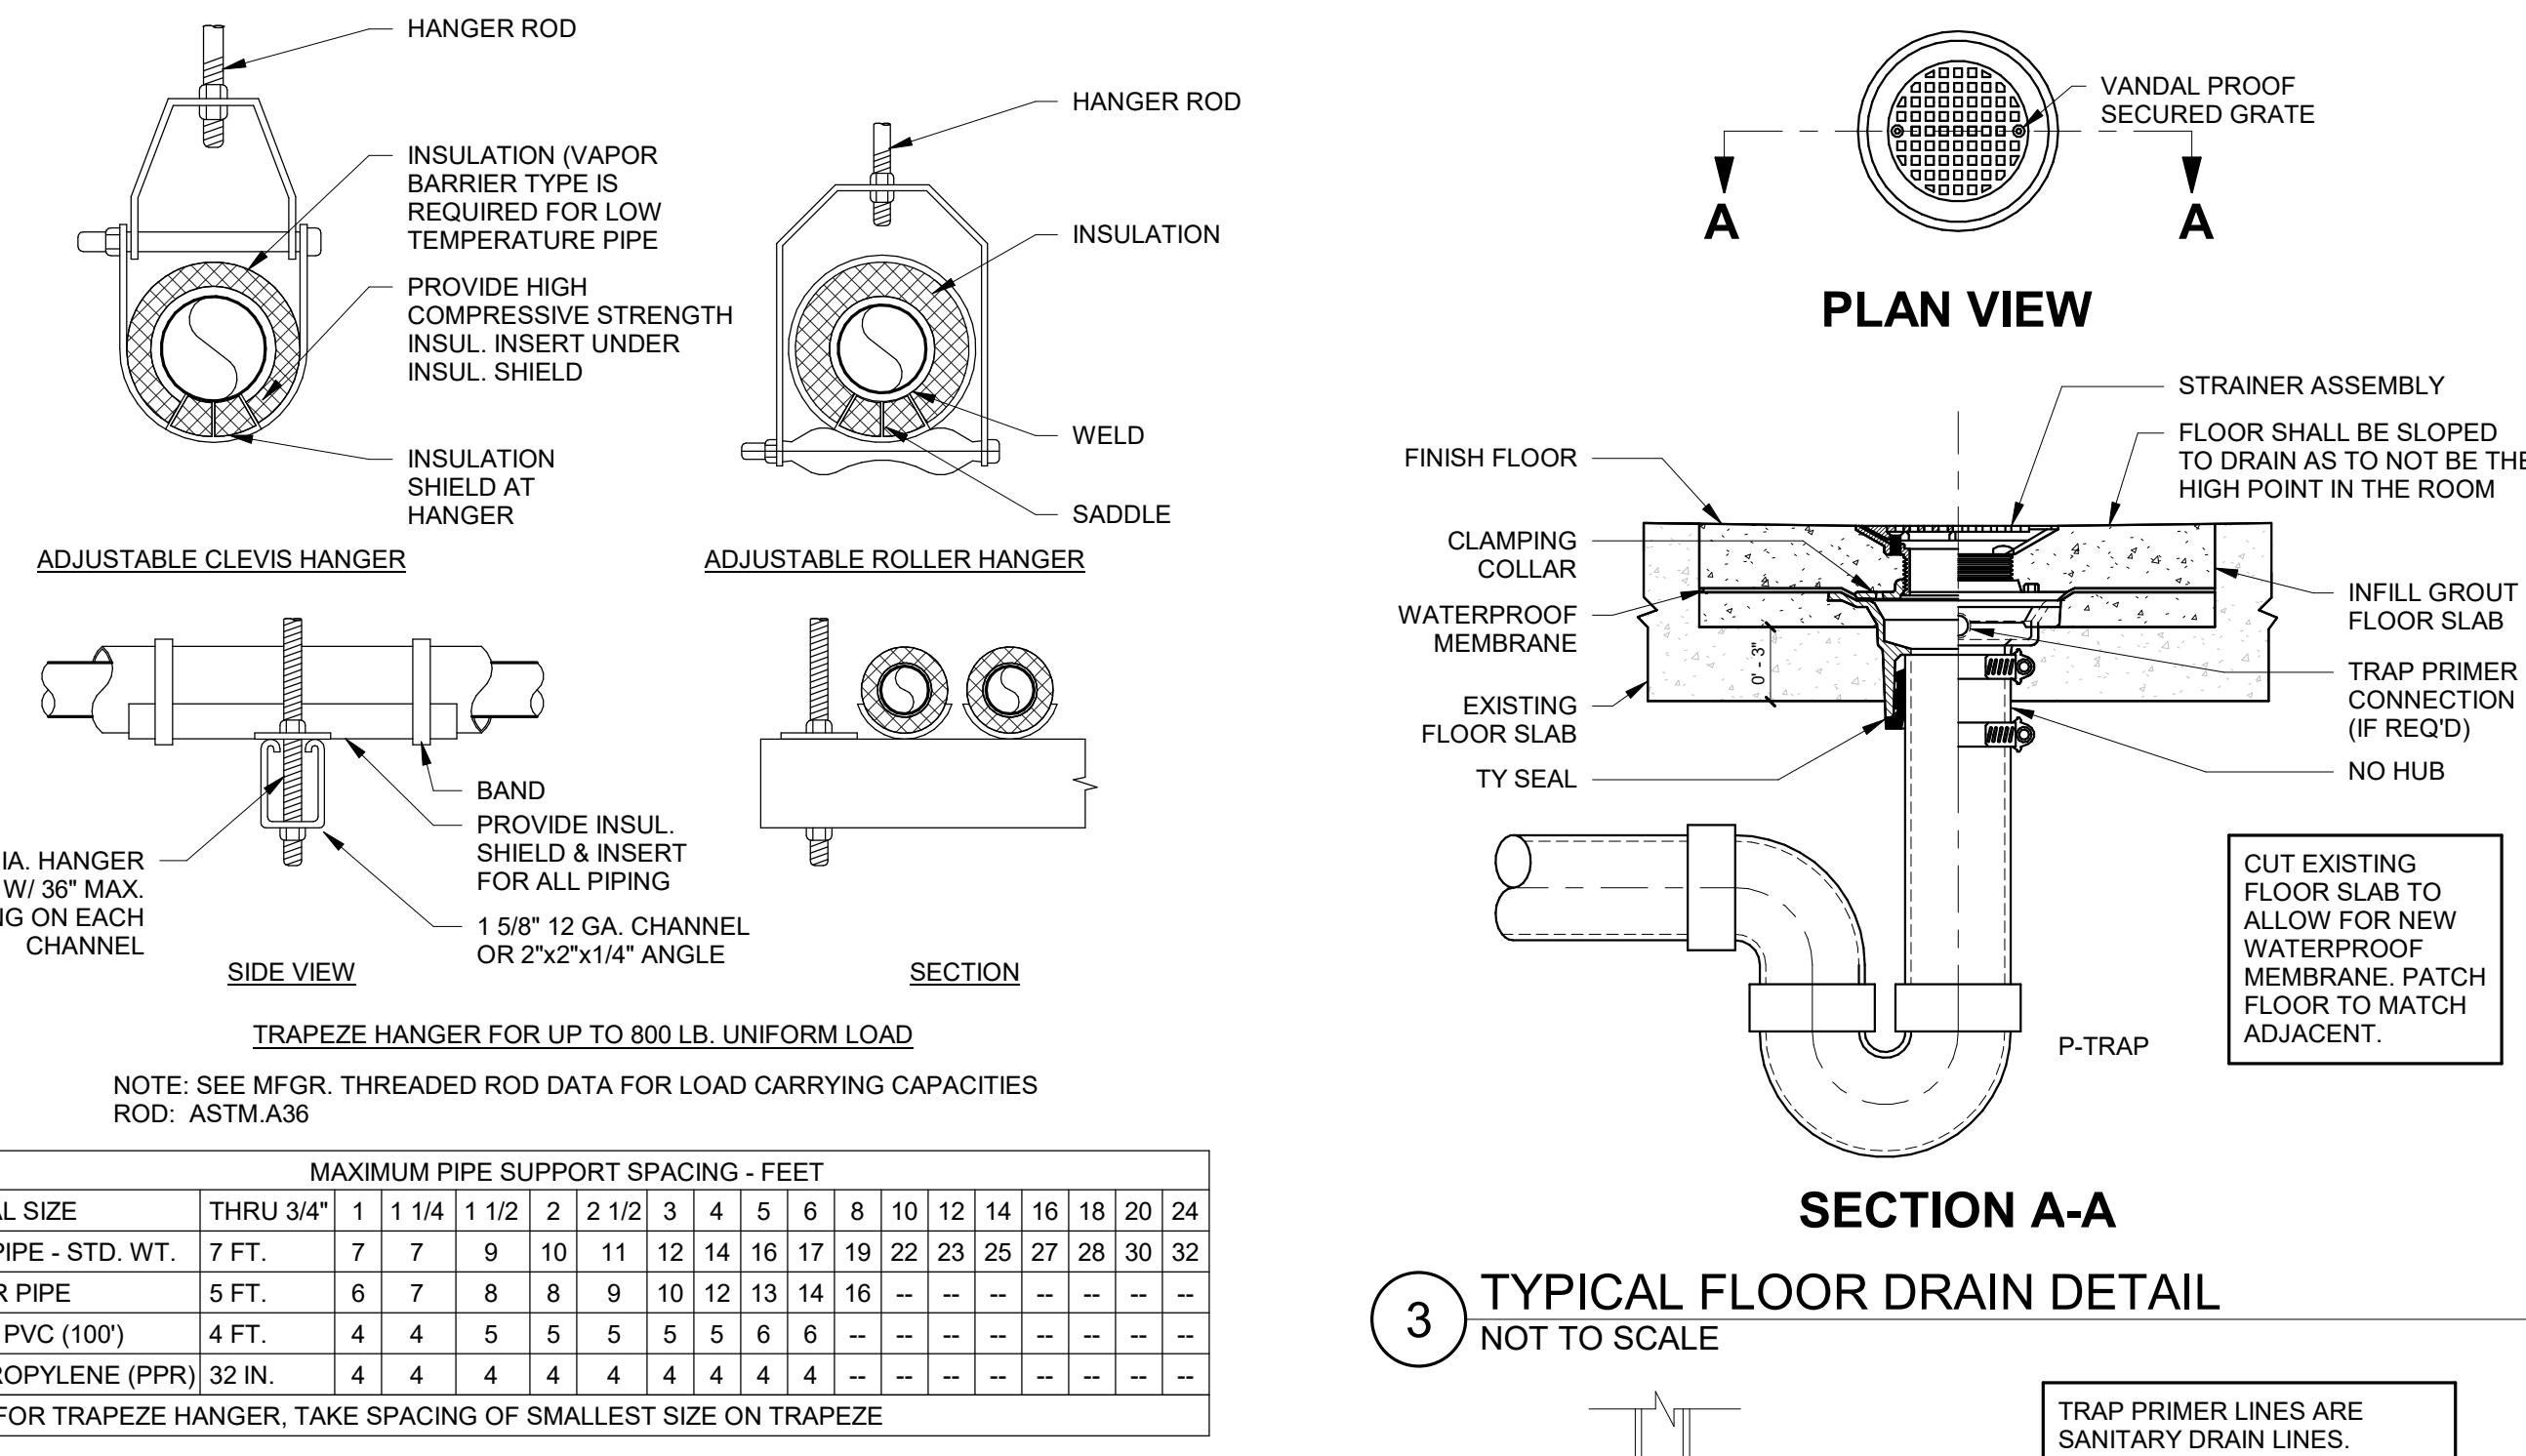
WATER HAMMER ARRESTOR CAPACITIES							
ARRESTOR SIZE	AA	A	B	C	D	E	F
Fixture Units	1-4	5-11	12-32	33-60	61-113	114-154	155-330

NOTE: ARRESTOR CAPACITIES BASED ON SIOUX CHIEF MODELS. VERIFY EQUIVALENT ARRESTOR'S FIXTURE UNIT CAPACITY IF USING DIFFERENT MANUFACTURER.
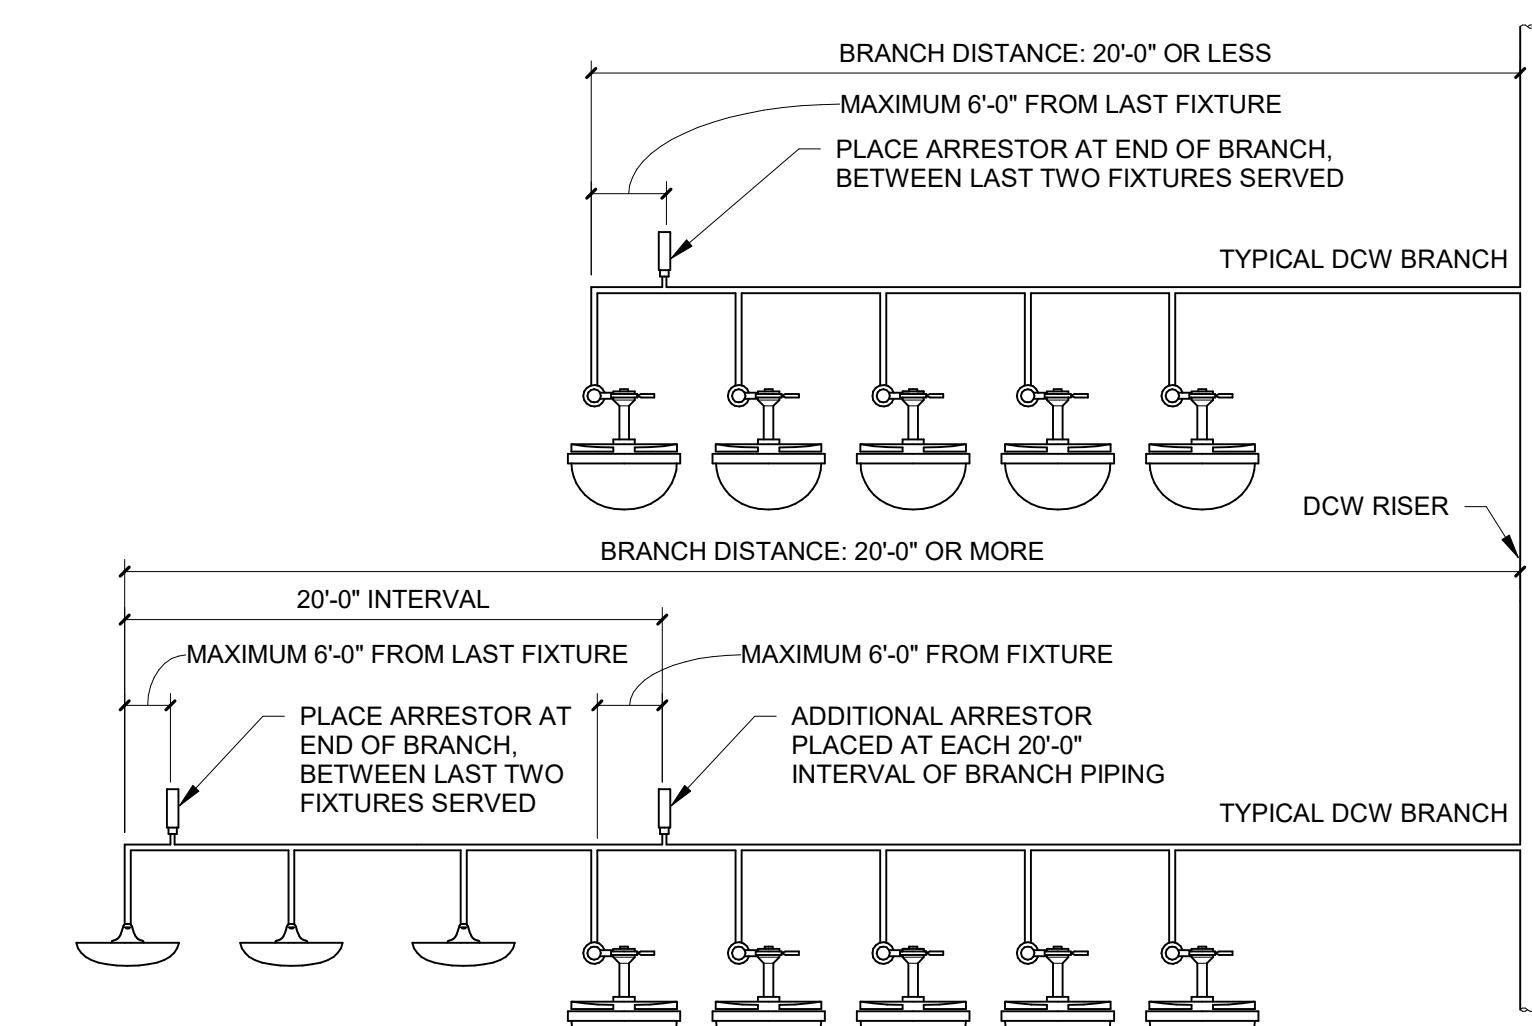
### 1 WATER HAMMER ARRESTOR PLACEMENT DETAIL NOT TO SCALE



### 6 POTABLE WATER ISOMETRIC

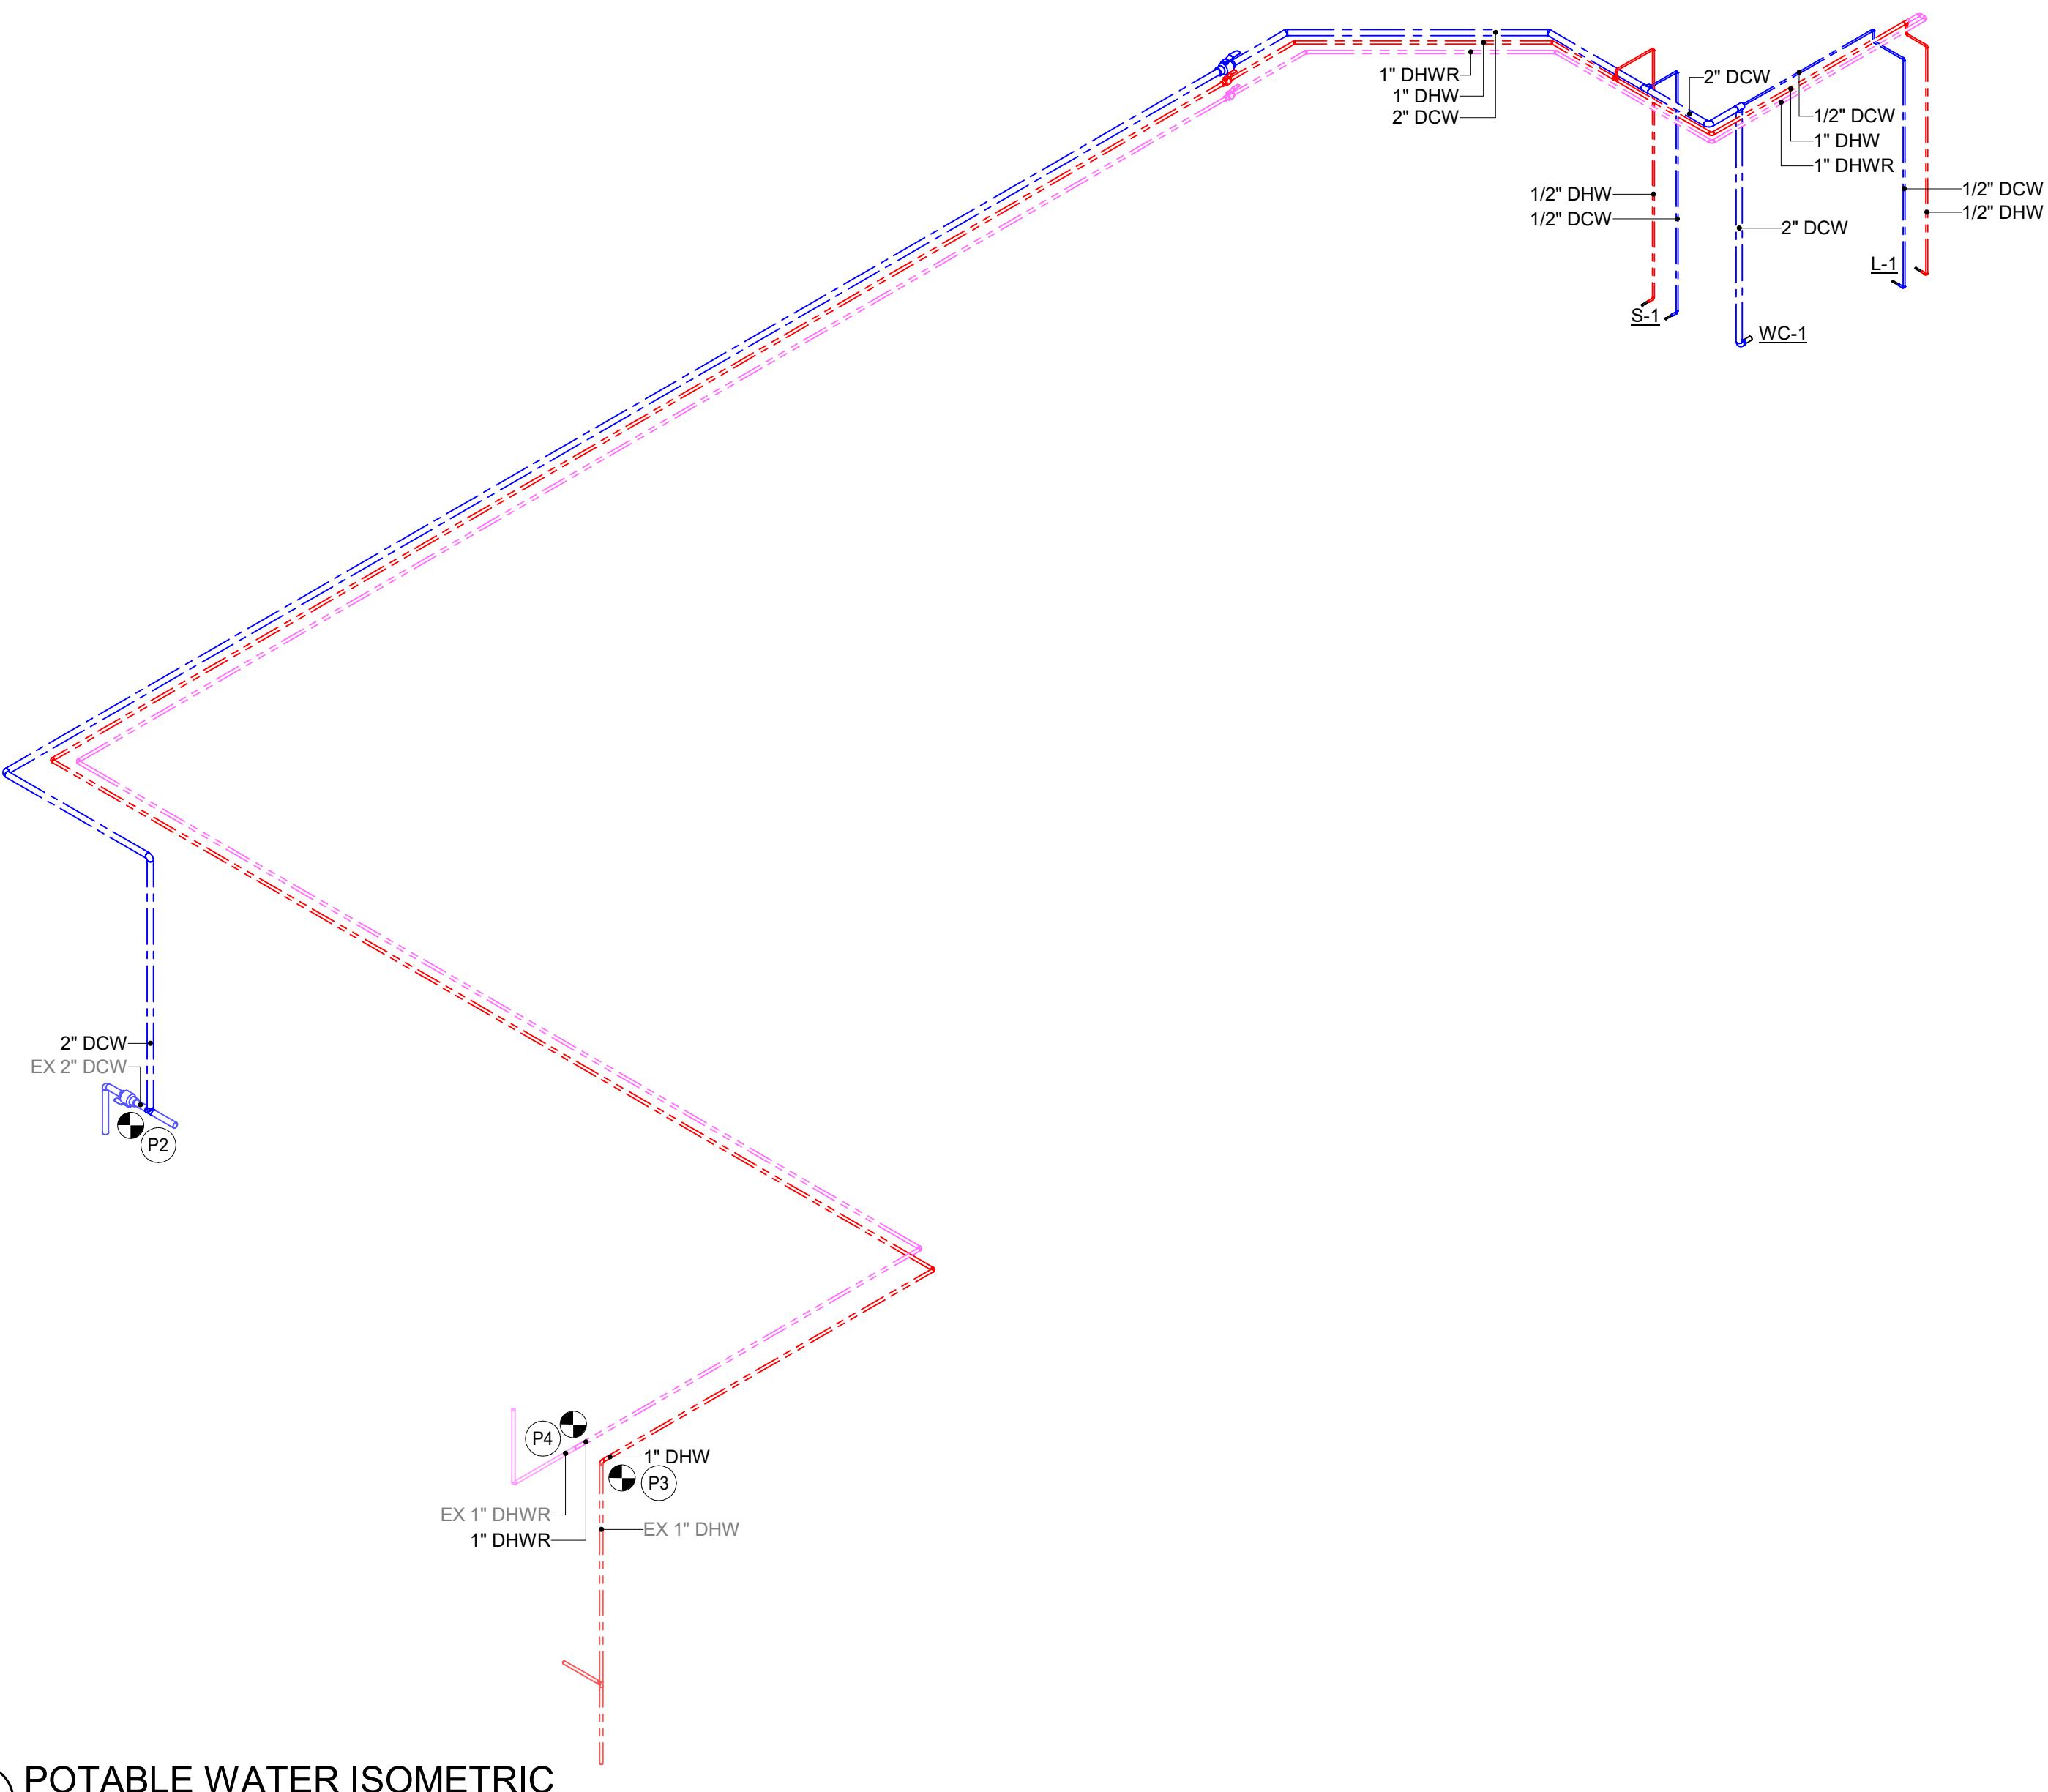


MAXIMUM PIPE SUPPORT SPACING - FEET											
NOMINAL SIZE	THRU 3/4"	1"	1 1/4"	1 1/2"	2"	2 1/2"	3"	4"	5"	6"	8"
STEEL PIPE - STD. WT.	7 FT.	7	7	9	10	11	12	14	16	17	22
COPPER PIPE	5 FT.	6	7	8	9	10	12	13	14	16	—
SCH. 40 PVC (100')	4 FT.	4	4	5	5	5	6	6	—	—	—
POLYPROPYLENE (PPR) 32 IN.	4	4	4	4	4	4	4	4	—	—	—


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STEEL PIPE - STD. WT.	7 FT.	7	7	9	10	11	12	14	16	17	22
COPPER PIPE	5 FT.	6	7	8	9	10	12	13	14	16	—
SCH. 40 PVC (100')	4 FT.	4	4	5	5	5	6	6	—	—	—
POLYPROPYLENE (PPR) 32 IN.	4	4	4	4	4	4	4	4	—	—	—

NOTE: FOR TRAPEZE HANGER, TAKE SPACING OF SMALLEST SIZE ON TRAPEZE


### 2 PIPE SUPPORT NOT TO SCALE

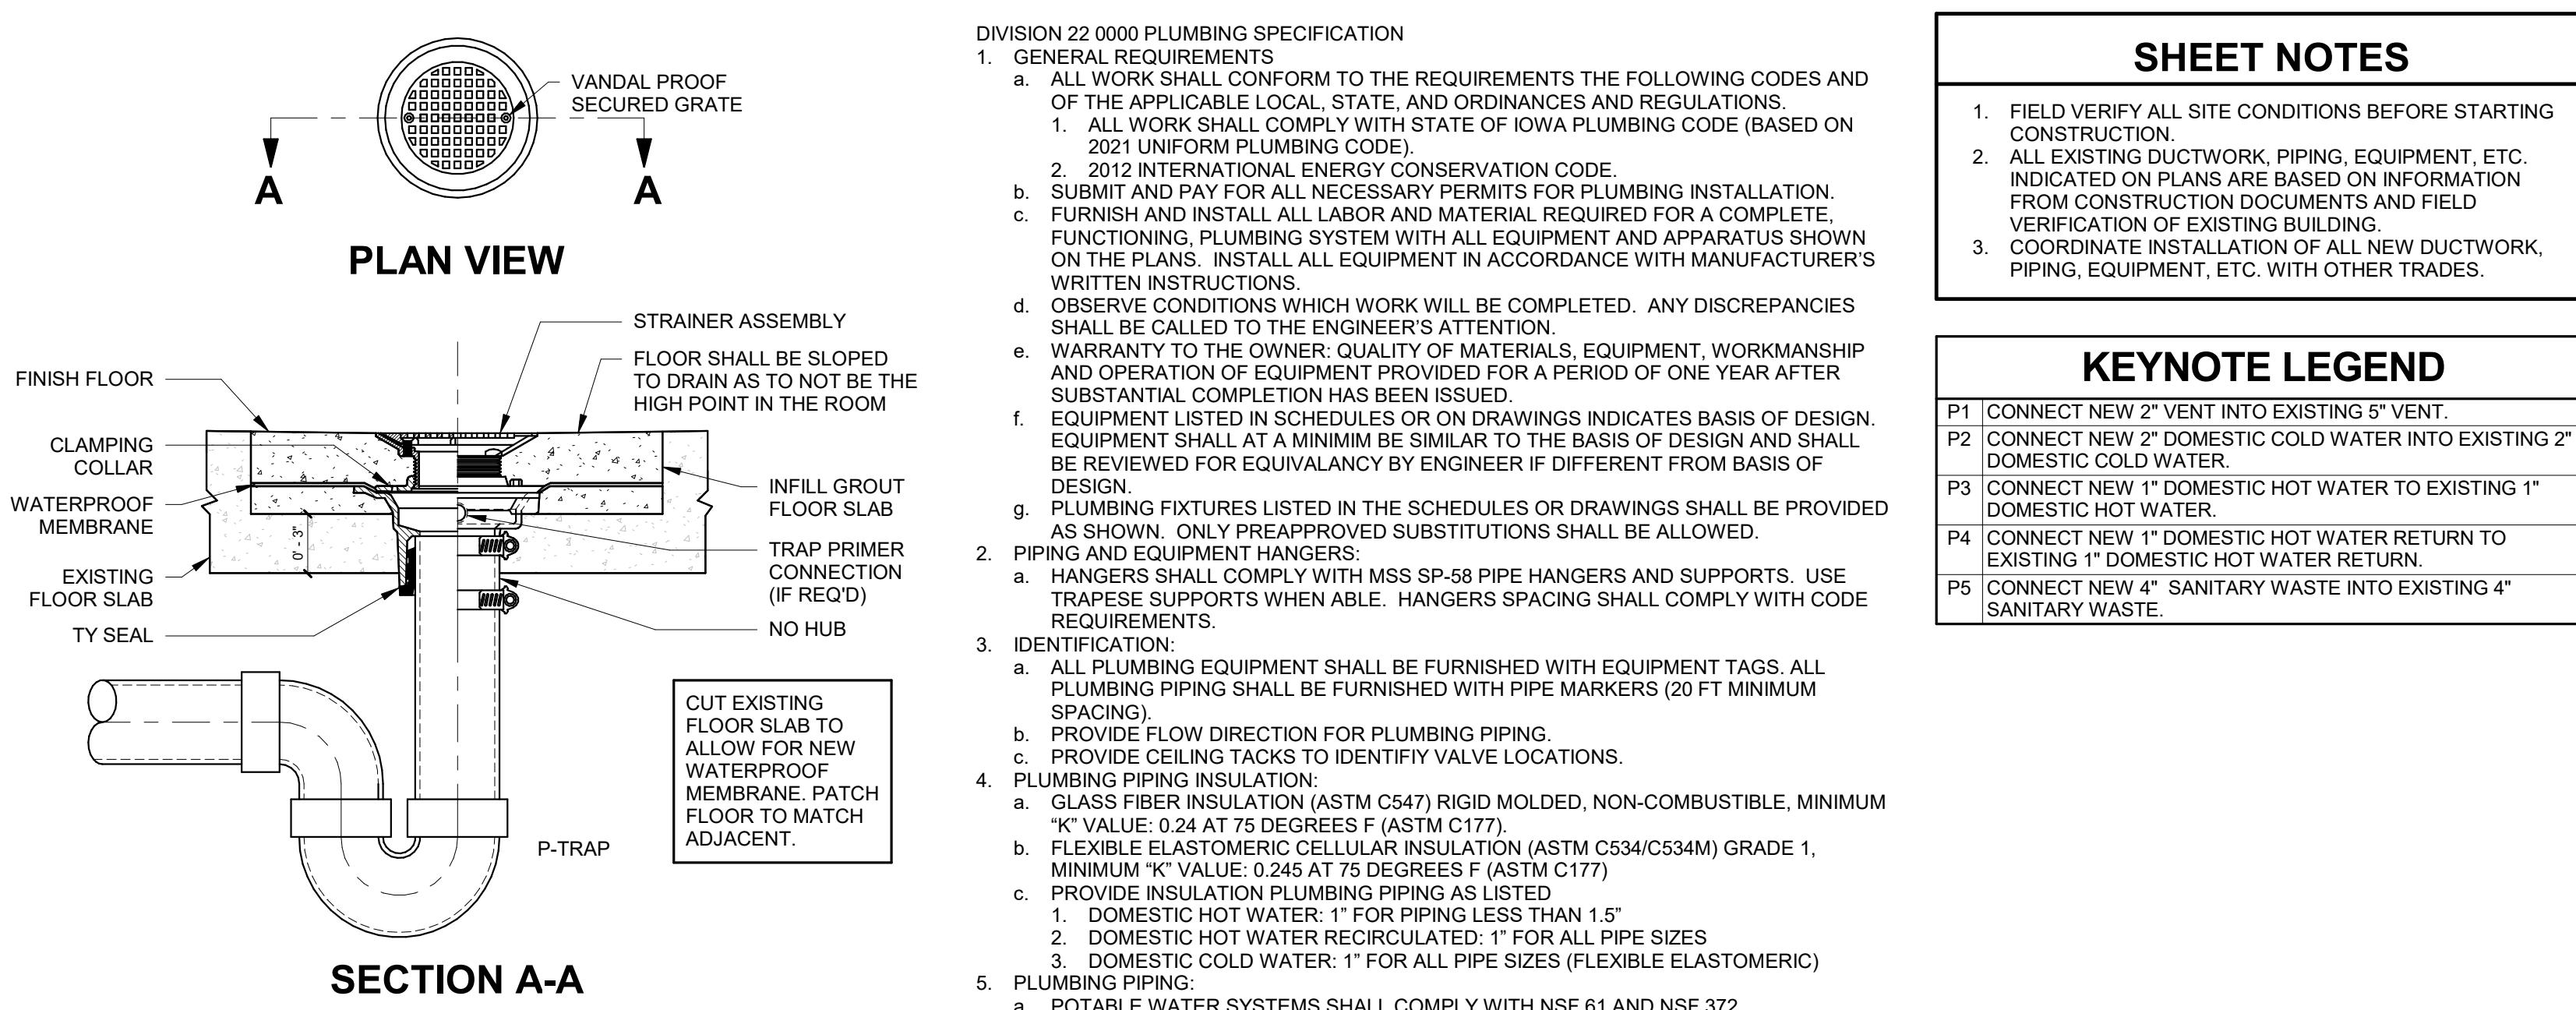

### 3 TYPICAL FLOOR DRAIN DETAIL NOT TO SCALE

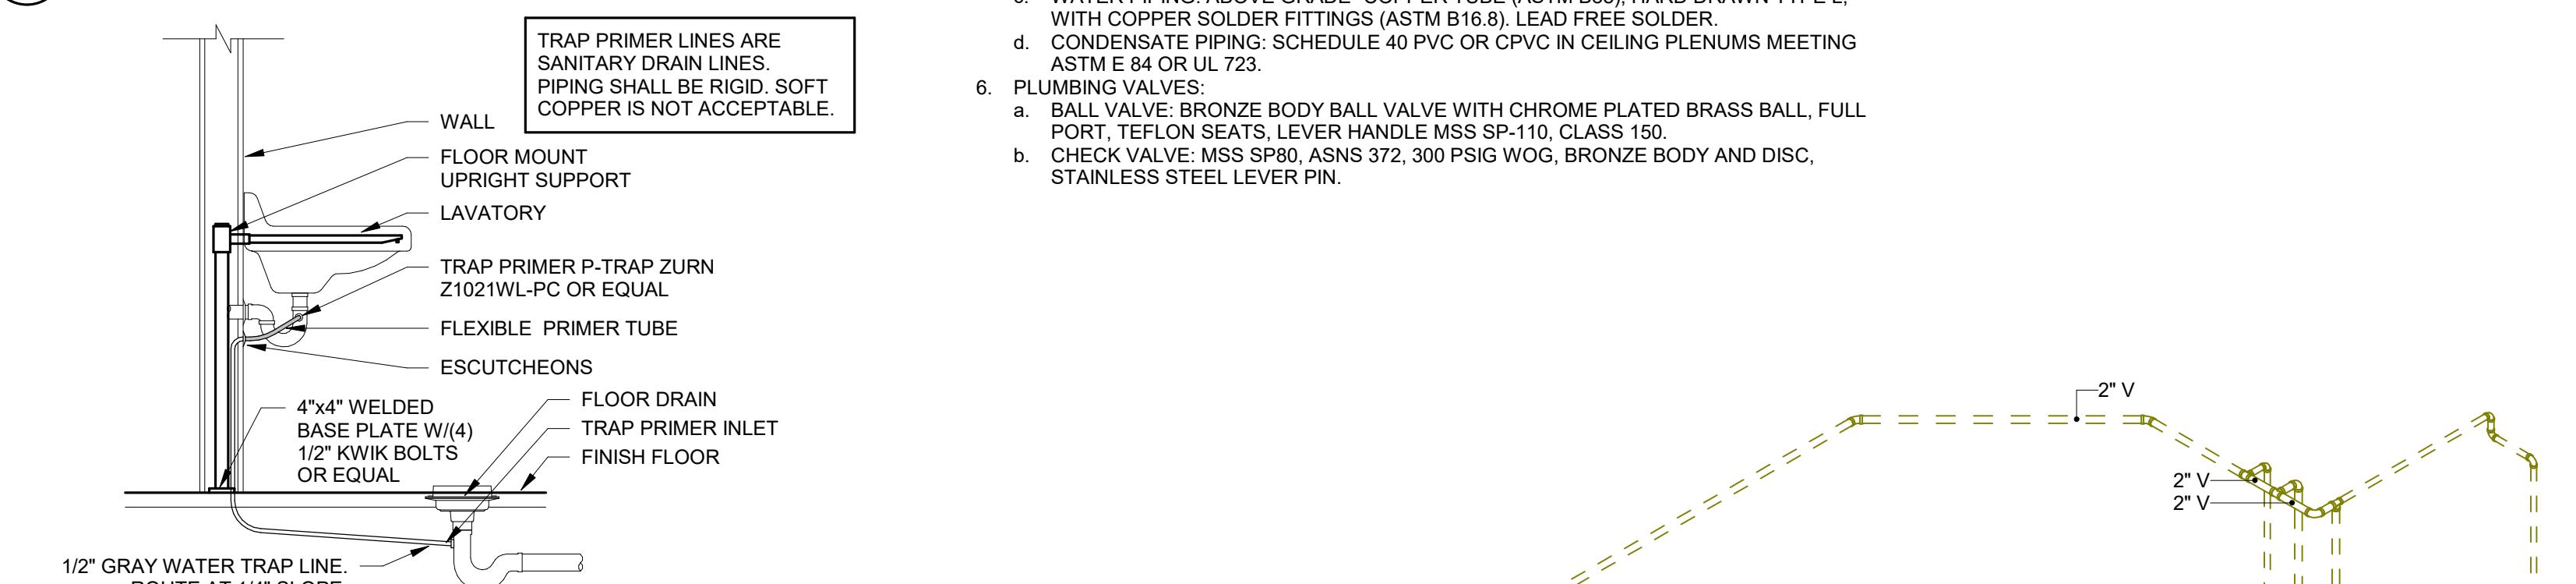

### 5 LAVATORY SUPPORT AND TRAP PRIMER DETAIL NOT TO SCALE

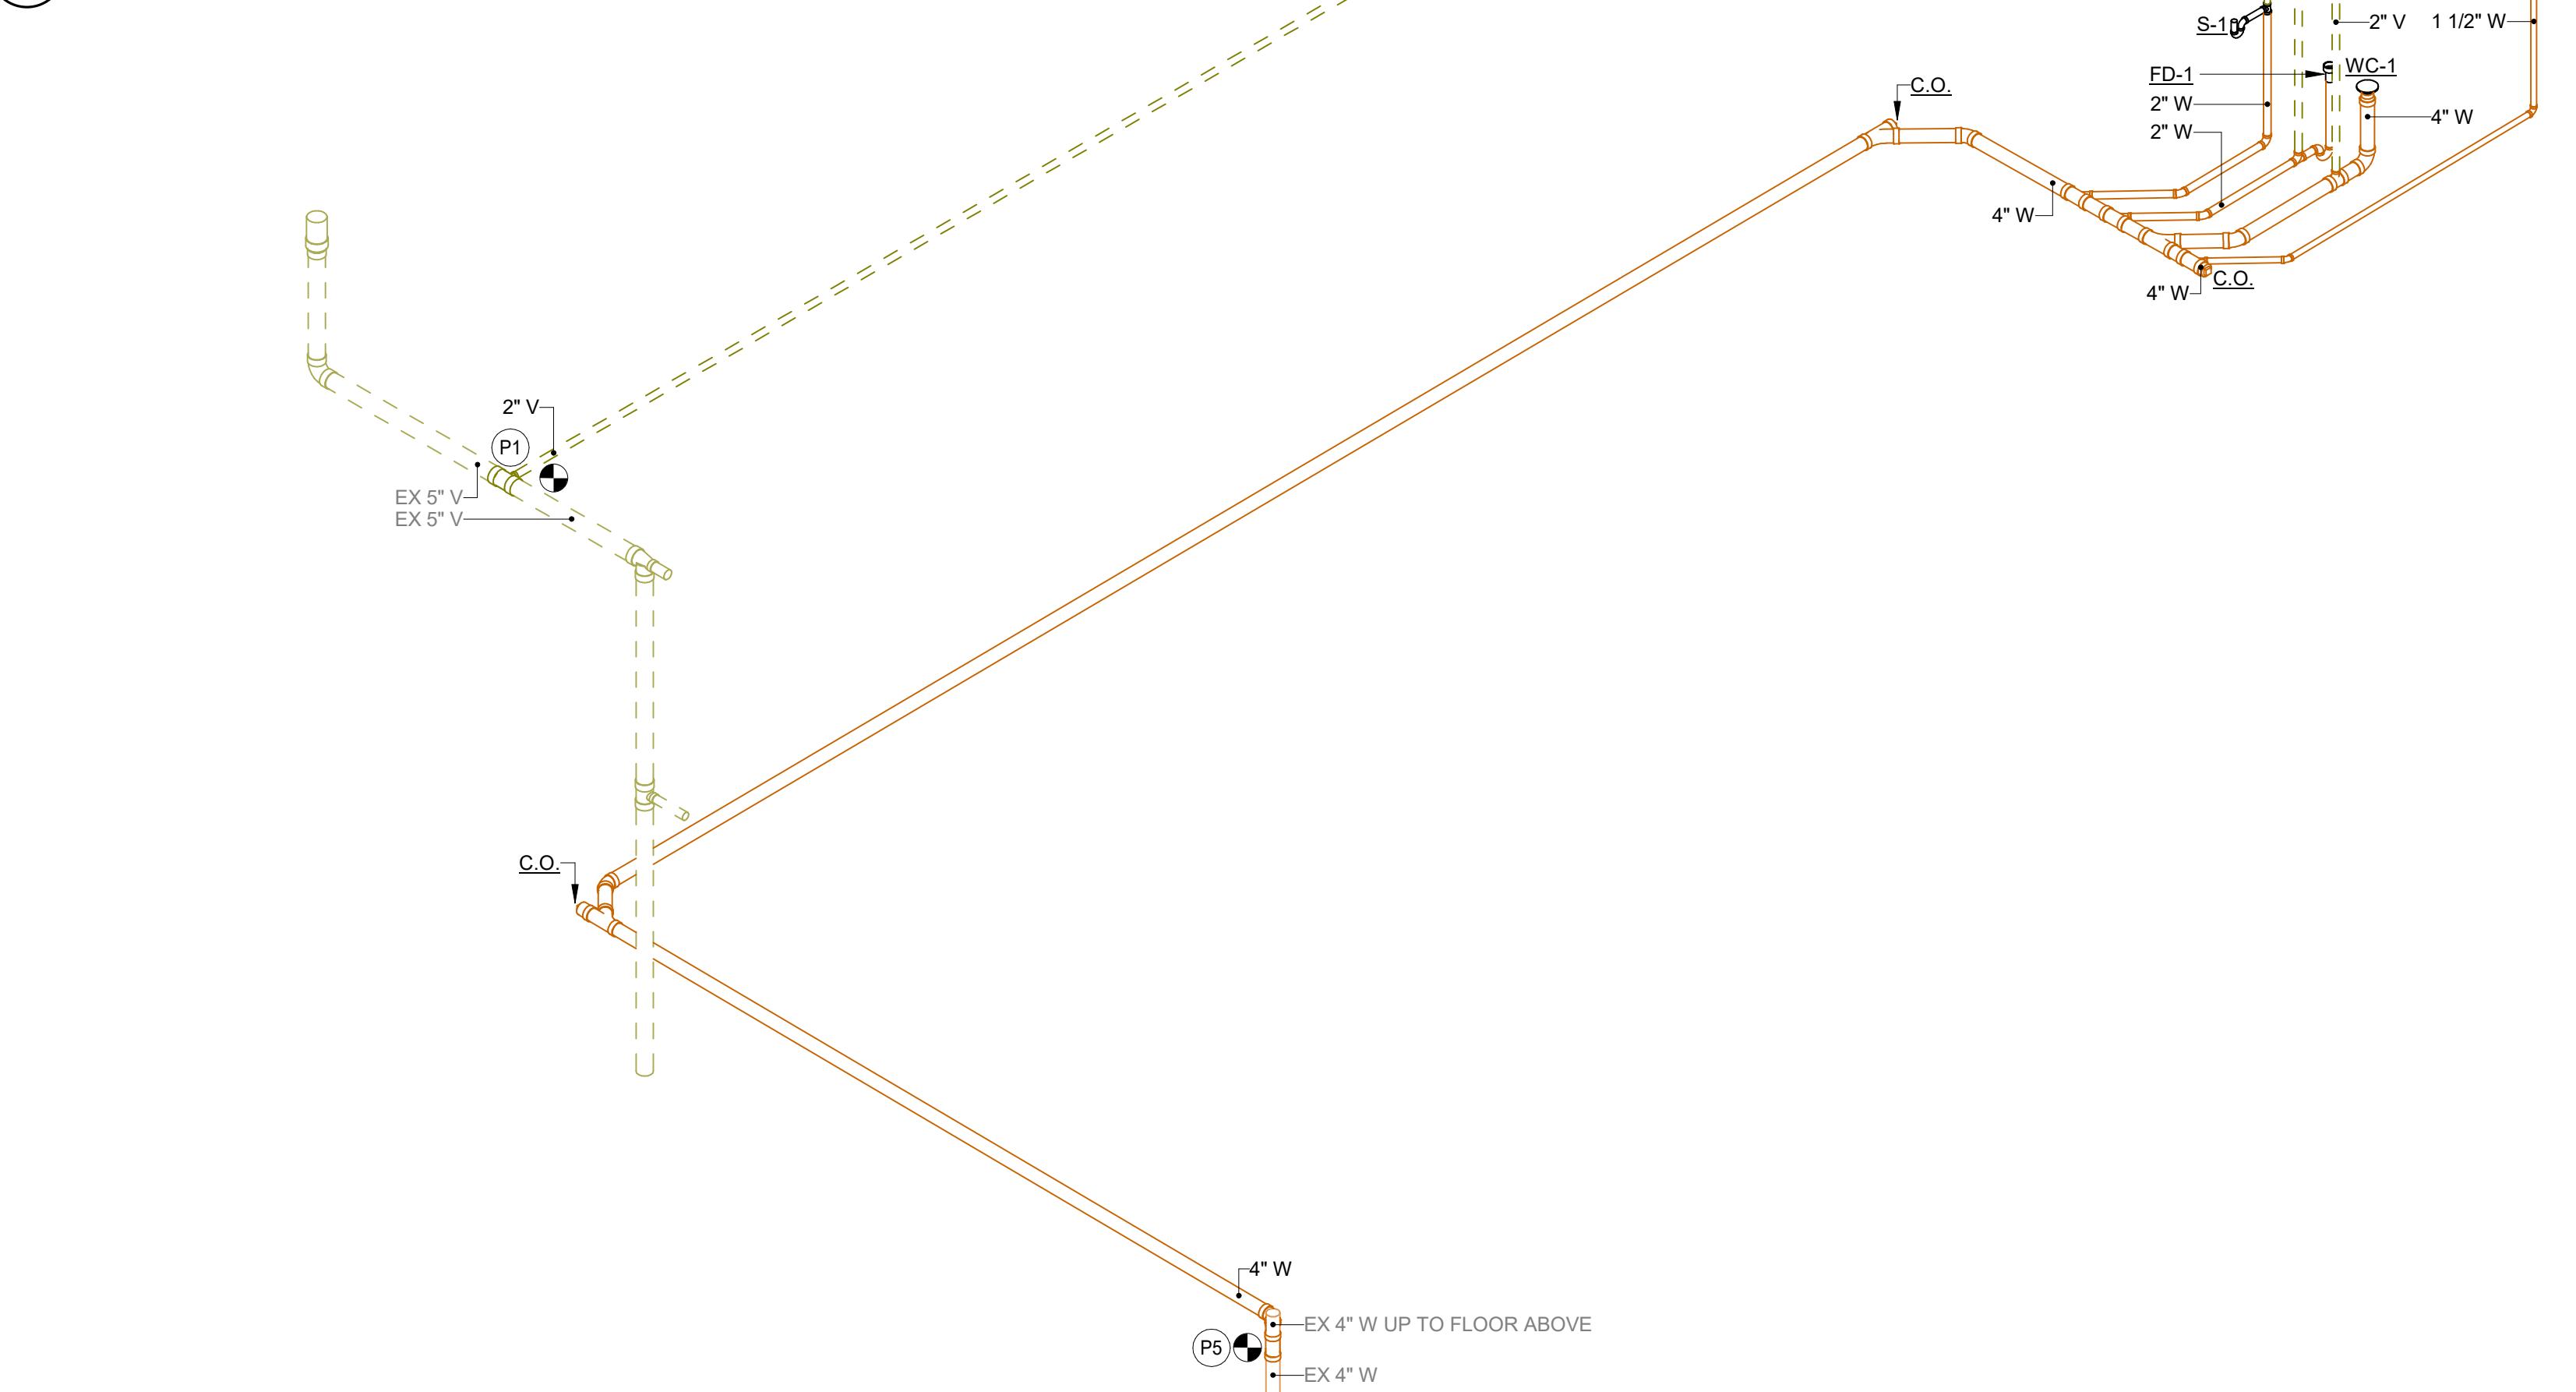

### 7 WASTE AND VENT ISOMETRIC

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PROJECT

## DAS CC IDALS HOOVER 5TH FLOOR RENOVATION

DES MOINES IOWA

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TITLE

## PLUMBING ISOMETRICS, DETAILS, SCHEDULES, AND SPECIFICATIONS

SHEET

PLUMBING FIXTURE SCHEDULE												
Fixture	Mfr	Model	Finish / Color	Trim				Waste	Vent	Cold Water	Hot Water	Notes
				Mfr	Model	Type	Waste					
FD-1	ZURN	2415S	NICKEL BRONZE									Fixture: 5"x6" SQUARE NICKEL BRONZE STRAINER, VANDAL PROOF SCREWS, CAST IRON BODY, TRAP PRIMER CONNECTION, AND DEEP SEAL P-TRAP. INSTALL UNIT FLUSH WITH FINISHED FLOOR. FLOOR DRAIN PIPE SIZES SHALL BE SIZED PER PLANS.
L-1	KOHLER	K-2005	WHITE	CHICAGO FAUCETS	420-T41E2805ABC	TYPE 'S'	SQUARE GRID TOP	2"	1 1/2"	1 1/2"	1/2"	Fixture: 18 GAUGE 304 STAINLESS STEEL, SINGLE BOWL, DROP IN WITH SOUND DEADENING UNDERSEAL. LUSTROUS SATIN FINISH. 25"x22"x8" OVERALL SIZE WITH 21"x15-3/4"x6-1/8" BOWL. 3-3/8" REAR CENTER DRAIN.
S-1	ELKAY	LRAD252265	LUSTROUS SATIN	CHICAGO FAUCETS	431-ABCP	LEVER HANDLE FAUCET	1 1/2"	1 1/2"	1/2"	1/2"		FAUCET: MANUAL DECK MOUNTED FAUCET WITH 4" CENTER SET MOUNT, POLISHED CHROME FINISH, NON-AERATING LAMINAR SPRAY, 0.5 GPM, CERAMIC OPERATING CARTRIDGES. VANDAL PROOF 4-1/4" LEVER HANDLE. PROVIDE 1/2" CHROME PLATED ANGLE STOPS WITH WHEEL HANDLE AND FLEXIBLE RISERS.
WC-1	KOHLER	K-96057	WHITE	SLOAN	ROYAL 111-128	MANUAL FLUSH VALVE	3"	2"	1"			WASTE: BRUSHED STAINLESS DUO STRAINER AND 1 1/2" TAILPIECE, STRAINER BASKET WITH NEOPRENE STOPPER. 17 GAUGE-1 1/2" CHROME PLATED BRASS ADJUSTABLE P-TRAP. AND WASTE-TO-WALL. MIXING VALVE: POWERS, HYDROGUARD LFLM495 SERIES LEAD FREE THERMOSTATIC MIXING VALVE. MOUNT UNDER THE FIXTURE, 1/2" INLETS AND OUTLET. SET VALVE TO DELIVER 105 DEG F (ADJ) WATER TO HOT WATER SIDE OF MANUAL FAUCET. ACCEPTABLE TO BE INTEGRAL TO FAUCET PROVIDED ASSE 1070 IS MET.
												CARRIER: PROVIDE CAST IRON, CONCEALED ARM CARRIER/THIN PLATE SYSTEM.

## DIVISION 21 0000 FIRE PROTECTION SPECIFICATION

## 1. GENERAL REQUIREMENTS

- a. ALL WORK SHALL COMPLY WITH STATE OF IOWA BUILDING CODE (BASED ON 2015 INTERNATIONAL BUILDING CODE).
- b. ALL WORK SHALL COMPLY WITH THE STATE OF IOWA FIRE CODE (BASED ON 2015 INTERNATIONAL FIRE CODE).
- c. SUBMIT AND PAY FOR ALL NECESSARY PERMITS FOR FIRE PROTECTION INSTALLATION.
- d. PROVIDE AND PAY FOR ALL EQUIPMENT AND APPARATUS FOR A FUNCTIONING FIRE PROTECTION SYSTEM WITH ALL EQUIPMENT AND APPARATUS SHOWN ON THE PLANS. INSTALL ALL EQUIPMENT IN ACCORDANCE WITH MANUFACTURER'S WRITTEN INSTRUCTIONS.
- e. OBSERVE CONDITIONS WHICH WORK WILL BE COMPLETED. ANY DISCREPANCIES SHALL BE CALLED TO THE ENGINEER'S ATTENTION.
- f. EQUIPMENT LISTED IN SCHEDULES OR ON DRAWINGS INDICATES BASIS OF DESIGN. EQUIPMENT SHALL AT A MINIMUM BE SIMILAR TO THE BASIS OF DESIGN AND SHALL BE REVIEWED FOR EQUIVALENCE BY ENGINEER IF DIFFERENT FROM BASIS OF DESIGN.
2. FIRE PROTECTION PIPING:
  - a. SPRINKLER PIPING: SEE SCHEDULE 10, BLACK.
  - b. STEEL FITTINGS: ASME B16.9 WROUGHT STEEL, BUTTWELDED.
  - c. MALLEABLE FITTINGS: ASME B16.3, THREADLESS FITTINGS AND ASTM A47/A47M.
  - d. MECHANICAL GROOVED COUPLINGS: MALLEABLE IRON HOUSING CLAMPS TO ENGAGE AND LOCK, "C" SHAPED ELASTOMERIC SEALING GASKET, STEEL BOLTS, NUTS, AND WASHERS; GASKET IS COMPRESSED INTO PERMANENT MECHANICAL ENGAGEMENT ONTO PIPE.
  - e. MECHANICAL FORMED FITTINGS: CARBON STEEL HOUSING WITH INTEGRAL PIPE STOP AND O-RING POKED AND O-RING, UNIFORMLY COMPRESSED INTO PERMANENT MECHANICAL ENGAGEMENT ONTO PIPE.
  - f. INSTALL SPRINKLER SYSTEM AND SERVICE MAIN SPRINGS, HANGERS, AND SUPPORTS IN ACCORDANCE WITH NFPA 13.
  - g. PROVIDE SPRINKLER PIPING, SUPPORTS, AND ACCESSORIES TO MAINTAIN GRADIENT.
  - h. INSTALL PIPING TO CONSERVE BUILDING SPACE, DO NOT INTERFERE WITH USE OF SPACE AND OTHER WORK.
  - i. GROUP PIPING WHENEVER PRACTICAL AT COMMON ELEVATIONS.
  - j. SLOW SPRINKLER PIPING AND ARREST PIPING DRAINS AT LOW POINTS USE ECCENTRIC REDUCERS TO MAINTAIN TOP OF PIPE LEVEL.
  - k. PREPARE PIPE FITTINGS, SUPPORTS, AND ACCESSORIES FOR FRESH PAINTING, WHERE PIPE SUPPORT MEMBERS ARE WELDED TO STRUCTURAL BUILDING FRAMING, SCRAPE, BRUSH CLEAN, AND APPLY ONE COAT OF ZINC RICH PRIMER TO WELDING.
  - l. DO NOT PENETRATE BUILDING STRUCTURAL MEMBERS UNLESS INDICATED.
  - m. PREPARE PIPING FOR PENETRATING FOOTINGS, FLOORS, WALLS, AND PARTITIONS. SEAL PIPE INCLUDING SLEEVE PENETRATIONS TO ACHIEVE FIRE RESISTANCE EQUIVALENT TO FIRE SEPARATION REQUIRED.
  - n. WHEN INSTALLING MORE THAN ONE PIPING SYSTEM MATERIAL, ENSURE SYSTEM COMPONENTS ARE COMPATIBLE AND JOINED TO ENSURE THE INTEGRITY OF THE SYSTEM. PROVIDE NECESSARY JOINING FITTINGS, UNION, FLANGES, UNION, AND COUPLINGS FOR SERVICING AS PROVIDED.
  - o. DIE CUT THREADED JOINTS WITH 1/2" STEEL THREADS, 1/2" THREADED LEADS AND LINESEED, OR OTHER NON-TOXIC JOINT COMPOUND APPLIED TO MALE THREADS ONLY.
  - p. INSTALL FIRE ATTACHE ESCUTCHEONS AT PIPING PENETRATING PARTITIONS AND CEILINGS ON BOTH SIDES OF PARTITIONS SEPARATING FINISHED AREAS THROUGH WHICH PIPING PASSES. USE CHROME PLATED ESCUTCHEONS IN OCCUPIED SPACES AND TO CONCEAL OPENINGS IN CONSTRUCTION.
  3. PIPE HANGERS AND SUPPORTS:
    - a. PROVIDE HANGERS AS LISTED. USE TRAPEZE SUPPORTS WHEN ABLE. HANGERS SPACING SHALL COMPLY WITH CODE REQUIREMENTS.
    1. HANGERS FOR PIPE SIZES 1/2 TO 1-1/2 INCH: MALLEABLE IRON, ADJUSTABLE, SWIVEL, SPLIT RING.
    2. HANGERS FOR PIPE SIZES 2 INCHES AND OVER: CARBON STEEL, ADJUSTABLE, CLEVIS.
    3. TRAPEZE HANGERS: STEEL CHANNELS WITH WELDED SPACERS AND HANGER RODS.
    4. WALL SUPPORT FOR PIPE SIZES 2 TO 3 INCHES: CAST IRON HOOK.
    5. WALL SUPPORT: CARBON STEEL AND OVER: WELDED STEEL BRACKET AND WROUGHT STEEL CLAMP.
    6. VERTICAL SUPPORT: STEEL RISER CLAMP.
    7. FLOOR SUPPORT: CAST IRON ADJUSTABLE PIPE SADDLE, LOCK NUT, NIPPLE, FLOOR FLANGE, AND CONCRETE PIER OR STEEL SUPPORT.
    8. INSTALL HANGERS TO PROVIDE A MINIMUM 1/2" INLET SPACE BETWEEN FINISHED COVERING AND ADJACENT WORK.
    9. PROVIDE HANGERS WITH 1-1/2 INCH MINIMUM VERTICAL ADJUSTMENT. DESIGN HANGERS FOR PIPE MOVEMENT WITHOUT DISENGAGEMENT OF SUPPORTED PIPE.
  4. FIRE PROTECTION VALVES:
    - a. TWO PIECE BALL VALVE WITH INDICATORS: MINIMUM PRESSURE RATING SHALL BE 175 PSIG, FULL OR STANDARD PORT, POLYTETRAFLUOROETHYLENE (PTFE) SEAT, BRONZE OR STAINLESS STEEL STEM, LEVER ACTUATOR.
    1. VALVE MATERIAL FOR PIPING LESS THAN OR EQUAL TO 2": BRONZE BODY BALL VALVE WITH CHROME PLATED OR STAINLESS STEEL BRASS BALL.
    2. VALVE MATERIAL FOR PIPING GREATER THAN 2": CAST IRON BODY BALL VALVE WITH CHROME PLATED BALL.
    3. END CONNECTIONS FOR VALVES 1" AND UP THROUGH 2-1/2": THREADED ENDS WITH UNION.
    4. END CONNECTIONS FOR VALVES 3" AND OVER: GROOVED ENDS.
    - b. TRIM AND DRAIN VALVES: MINIMUM PRESSURE RATING SHALL BE 175 PSIG. TWO PIECE DESIGN, FORGED BRASS OR BRONZE BODY WITH CHROME PLATED BRASS BALL, FULL OR STANDARD PORT, POLYTETRAFLUOROETHYLENE (PTFE) SEAT, BRONZE OR STAINLESS STEEL STEM, HAND LEVER ACTUATOR.
    1. END CONNECTIONS FOR VALVES 1-1/4 NPS THROUGH 2-1/2 NPS: THREADED ENDS.
    2. END CONNECTIONS FOR VALVES 1-1/4 NPS AND 2-1/2 NPS: GROOVED ENDS.
  5. IDENTIFICATION:
    - a. ALL FIRE PROTECTION AUTOMATIC CONTROLS AND INSTRUMENTATION SHALL BE FURNISHED WITH TAGS. ALL CONTROL PANELS SHALL BE FURNISHED WITH NAMEPLATES. ALL FIRE PROTECTION PIPING SHALL BE FURNISHED WITH PIPE MARKERS (20 FT MINIMUM SPACING).
    - b. PROVIDE FLOW DIRECTION FOR FIRE PROTECTION PIPING.
    - c. PROVIDE CEILING TACKS TO IDENTIFY VALVE LOCATIONS.
  6. SPRINKLERS:
    - a. SUSPENDED CEILING TYPE: SEMI-RECESSED PENDANT TYPE WITH MATCHING PUSH ON ESCUTCHEON PLATE.
    - b. Recessed Type: Recessed.
    - c. COVERAGE TYPE: EXTENDED.
    - d. FINISH: CHROME PLATED.
    - e. FUSIBLE LINK: FUSIBLE SOLDER LINK TYPE TEMPERATURE RATED FOR SPECIFIC AREA HAZARD.

## SHEET NOTES

1. REVISE SPRINKLER PIPING INCLUDING REPIPING MAINS, BRANCH PIPING, AND SUPPORTS TO ALLOW FOR RECONFIGURATION OF DOOR PLACEMENT, INSTALLATION OF NEW DUCTWORK, MECHANICAL EQUIPMENT, AND PIPING. PROVIDE NEW RUNOUTS AND HEADS AS NECESSARY TO MAINTAIN COVERAGE PER NFPA 13.
2. FIELD VERIFY SITE CONDITIONS BEFORE STARTING CONSTRUCTION.
3. ALL EXISTING DUCTWORK, PIPING, EQUIPMENT, ETC. INDICATED ON DRAWINGS AND ON INFORMATION FROM THE BIM DOCUMENTS, AND FIELD VERIFICATION OF EXISTING BUILDING.
4. COORDINATE INSTALLATION OF ALL NEW DUCTWORK, PIPING, EQUIPMENT, ETC. WITH OTHER TRADES.
5. INSTALLATION OF STANDAR RESPONSE SPRINKLERS WHERE MODIFICATIONS OR ADDITIONS ARE MADE TO THE EXISTING STANDARD RESPONSE SPRINKLER SYSTEM.

## GENERAL FIRE PROTECTION NOTES:

1. SPRINKLER PROTECTION SHALL BE PROVIDED THROUGHOUT NEW CONSTRUCTION. SPRINKLER DESIGN SHALL BE PER THE REQUIREMENTS OF THE CURRENT EDITIONS OF THE INTERNATIONAL BUILDING CODE (IBC), INTERNATIONAL FIRE CODE (IFC), STATE AND LOCAL CODES, OWNER'S INSURANCE UNDERWRITER, AND NFPA 13.
2. SPRINKLER CONTRACTOR SHALL DESIGN THESE SYSTEMS, PROVIDE HYDRAULIC CALCULATIONS AND SUBMIT STAMPED (PE OR CONTRACTOR'S NAME) TO THE AUTHORITIES HAVING JURISDICTION. APPROVAL OF THE DESIGN BY THE ARCHITECT/ENGINEER, APPROVAL SHALL BE OBTAINED FROM ALL AUTHORITIES PRIOR TO ORDERING EQUIPMENT, FABRICATION OF MATERIALS, OR STARTING INSTALLATION.
3. SPRINKLER CONTRACTOR SHALL COORDINATE WITH ALL OTHER TRADES AND BUILDING STRUCTURE. CONTRACTOR SHALL PROVIDE SPRINKLERS, PIPE, FITTINGS, VALVES, HANGERS, AIR COMPRESSORS, RISER ASSEMBLIES, ALARM SWITCHES, PUMPS, TANKS, AND ANY OTHER ITEMS FOR COMPLETE INSTALLATION.
4. SPRINKLERS AND PIPING SHALL NOT BE INSTALLED UNDER ANY LIGHT FIXTURES.
5. ALL EQUIPMENT SHALL BE UL LISTED.
6. SPRINKLER CONTRACTOR SHALL PREPARE PLANS FOR APPROVAL USING LAYOUT PROVIDED BY THE ENGINEER AS GUIDANCE.
7. SEISMIC BRACING SHALL BE PROVIDED WHERE REQUIRED BY BUILDING CODE AND / OR THE OWNER'S INSURANCE UNDERWRITER.
8. SPRINKLER HEADS IN LAY IN CEILINGS SHALL BE INSTALLED IN CENTER OF TILES.
9. SPRINKLER CONTRACTOR SHALL COORDINATE THE ELECTRICAL CHARACTERISTICS OF THE ELECTRICAL FIRE PROTECTION EQUIPMENT WITH THE ELECTRICAL DRAWINGS, FURNISH EQUIPMENT WITH THE CORRECT VOLTAGE SHOWN ON ELECTRICAL DRAWINGS.
10. ALL W/C PIPE FLOWERS SHALL INCLUDE A WALL INDICATOR VALVE, FLOW SWEEP, ETC.
11. ALL SPRINKLER PIPING AND DEVICES SHALL BE INSTALLED AS HIGH AS POSSIBLE AND SHALL NOT BE INSTALLED BELOW THE OWNER'S MINIMUM CLEARANCE REQUIREMENT.
12. ALL SYSTEMS SHALL BE CONTROLLED WITH A DEDICATED INDICATOR VALVE 40' OR GREATER FROM THE BUILDING.
13. CONTRACTOR'S MATERIAL AND TEST CERTIFICATES SHALL BE PROVIDED FOR ALL FIRE PROTECTION SYSTEMS.
14. THE CONTRACTOR'S INSURANCE AND THE OWNER'S INSURANCE UNDERWRITER SHALL FOLLOWED AT ALL TIMES.
15. PIPING RACKS, CABLE TRAYS, DUCTWORK AND ALL OTHER OBSTRUCTIONS SHALL HAVE SPRINKLER COVERAGE UNDERWRITER'S REQUIREMENT BY CODE AND THE OWNER'S INSURANCE UNDERWRITER.
16. SPRINKLER CONTRACTOR SHALL PROVIDE A SET OF SHOP DRAWINGS (PDF OR DWG FILES) AFTER RECEIVING APPROVAL FROM FIRE MARSHALL AND THE OWNER'S INSURANCE UNDERWRITER.

## FIRE PROTECTION KEY

LH-W: PROVIDE WET PIPE SPRINKLER SYSTEM PER NFPA 13. ORDINARY HAZARD GROUP 1. DENSITY SHALL BE 0.10 GPM/SQ. FT OVER THE MOST REMOTE 1,500 SQ. FT.

OH1-W: PROVIDE WET PIPE SPRINKLER SYSTEM PER NFPA 13. ORDINARY HAZARD GROUP 1. DENSITY SHALL BE 0.15 GPM/SQ. FT OVER THE MOST REMOTE 1,500 SQ. FT.


OH2-W: PROVIDE WET PIPE SPRINKLER SYSTEM PER NFPA 13. ORDINARY HAZARD GROUP 2. DENSITY SHALL BE 0.2 GPM/SQ. FT OVER THE MOST REMOTE 1,500 SQ. FT.

LH-D: PROVIDE DRY PIPE SPRINKLER SYSTEM PER NFPA 13. LIGHT HAZARD. DENSITY SHALL BE 0.10 GPM/SQ. FT OVER THE MOST REMOTE 1,500 SQ. FT.

OH1-D: PROVIDE DRY PIPE SPRINKLER SYSTEM PER NFPA 13. ORDINARY HAZARD GROUP 1. DENSITY SHALL BE 0.15 GPM/SQ. FT OVER THE MOST REMOTE 1,500 SQ. FT.

OH2-D: PROVIDE DRY PIPE SPRINKLER SYSTEM PER NFPA 13. ORDINARY HAZARD GROUP 2. DENSITY SHALL BE 0.2 GPM/SQ. FT OVER THE MOST REMOTE 1,500 SQ. FT.

ISG

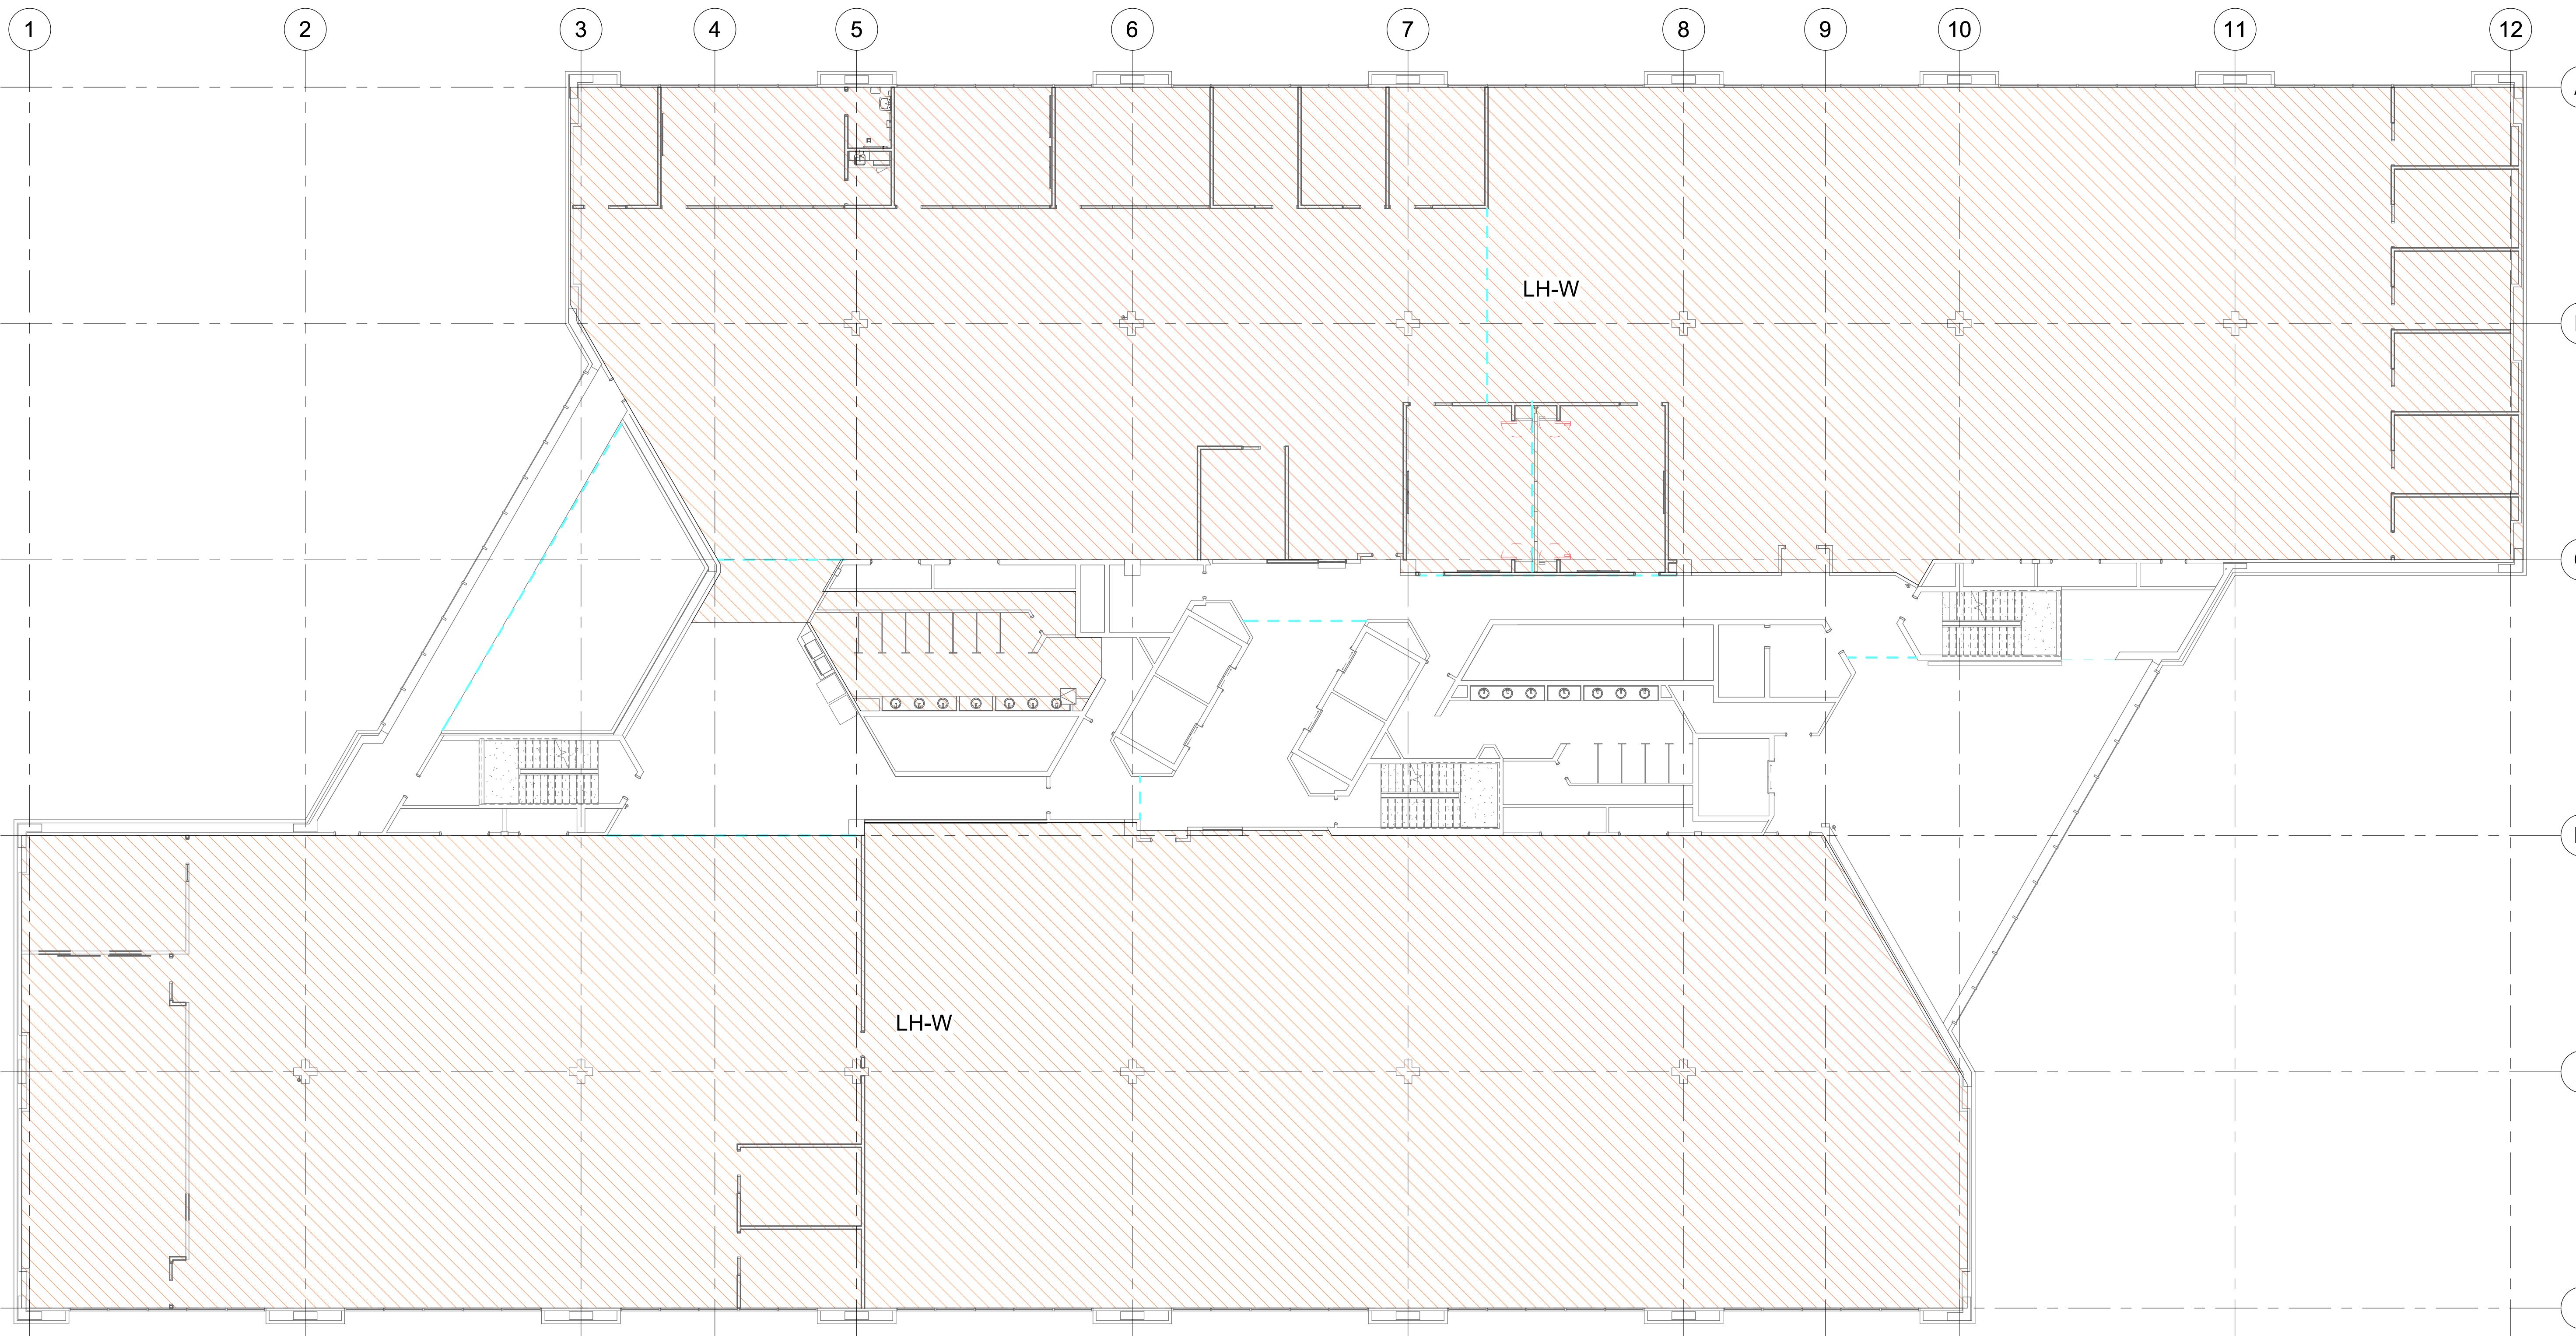1 FIFTH FLOOR FIRE PROTECTION PLAN  
3/32" = 1'-0"

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PROJECT

**DAS CC IDALS  
HOOVER  
5TH FLOOR  
RENOVATION**

DES MOINES IOWA

REVISION SCHEDULE		
DATE	DESCRIPTION	BY

PROJECT NO.	24-31954
FILE NAME	31954 Mech R24
DRAWN BY	JKS
DESIGNED BY	JKS
REVIEWED BY	AWP
ORIGINAL ISSUE DATE	01/21/25
CLIENT PROJECT NO.	9426.00

TITLE


**FIFTH FLOOR  
FIRE  
PROTECTION  
PLAN**

SHEET

FP2-11

SHEET NOTES	
1.	FIELD VERIFY ALL SITE CONDITIONS BEFORE STARTING CONSTRUCTION.
2.	EXISTING DUCTWORK, PIPING, EQUIPMENT, ETC. INDICATED ON PLANS ARE BASED ON INFORMATION FROM CONSTRUCTION DOCUMENTS AND FIELD VERIFICATION OF EXISTING BUILDING.
3.	COORDINATE START/STOP OF ALL NEW DUCTWORK, PIPING, EQUIPMENT, ETC. WITH OTHER TRADES.
4.	BASE BID EXISTING THERMOSTATS TO REMAIN OR BE RELOCATED.
5.	ALTERNATE #2 ACCEPTED: REMOVE AND DISPOSE OF ALL EXISTING THERMOSTATS IN AREA OF WORK.

KEYNOTE LEGEND	
D2	REMOVE EXISTING AIR TERMINAL AND ASSOCIATED PLENUM BOX. PREPARE FOR RELOCATION.
D3	REMOVE AND DISPOSE OF DUCTWORK BACK TO MAIN AND OTHER TRADES.
D4	REMOVE AND DISPOSE OF DUCTWORK. PREPARE REMAINING DUCT FOR NEW CONNECTION.
D5	REMOVE AND DISPOSE OF EXISTING AIR TERMINAL ABANDONED IN PLACE.
D6	DISPOSE OF AIR TERMINAL FROM EXISTING DUCTWORK AND PREPARE FOR NEW CONNECTION.
D7	BASE BID: REMOVE EXISTING THERMOSTAT AND PREPARE FOR RELOCATION. PATCH WALL TO MATCH ADJACENT.
D8	REMOVE AND DISPOSE OF DUCT CAP. PREPARE DUCT FOR NEW CONNECTION.
D9	CUT INTO EXISTING DUCT. PREPARE EXISTING DUCT MAIN FOR NEW BRANCH CONNECTION.
D10	REMOVE AND DISPOSE OF EXISTING AIR TERMINAL.
D11	BASE BID: REMOVE AND DISCONNECT EXISTING THERMOSTAT. PATCH WALL TO MATCH ADJACENT. PREPARE THERMOSTAT TO CONNECT TO NEW VAV. SEE NEW PLANS FOR RELOCATION LOCATION.
D12	BASE BID: REMOVE AND REINQUISIT EXISTING THERMOSTAT TO OWNER.
D13	BASE BID: THERMOSTAT TO REMAIN IN PLACE AND OPERATIONAL.
D14	ALTERNATE #2: REMOVE AND DISPOSE OF EXISTING THERMOSTAT. PATCH WALL TO MATCH ADJACENT.
D15	ALTERNATE #2: REMOVE AND DISPOSE OF EXISTING THERMOSTAT. PREPARE REMAINING BASEPLATE OR SURFACE MOUNTED WIREMOLD DEVICE BOX FOR NEW CONNECTION.

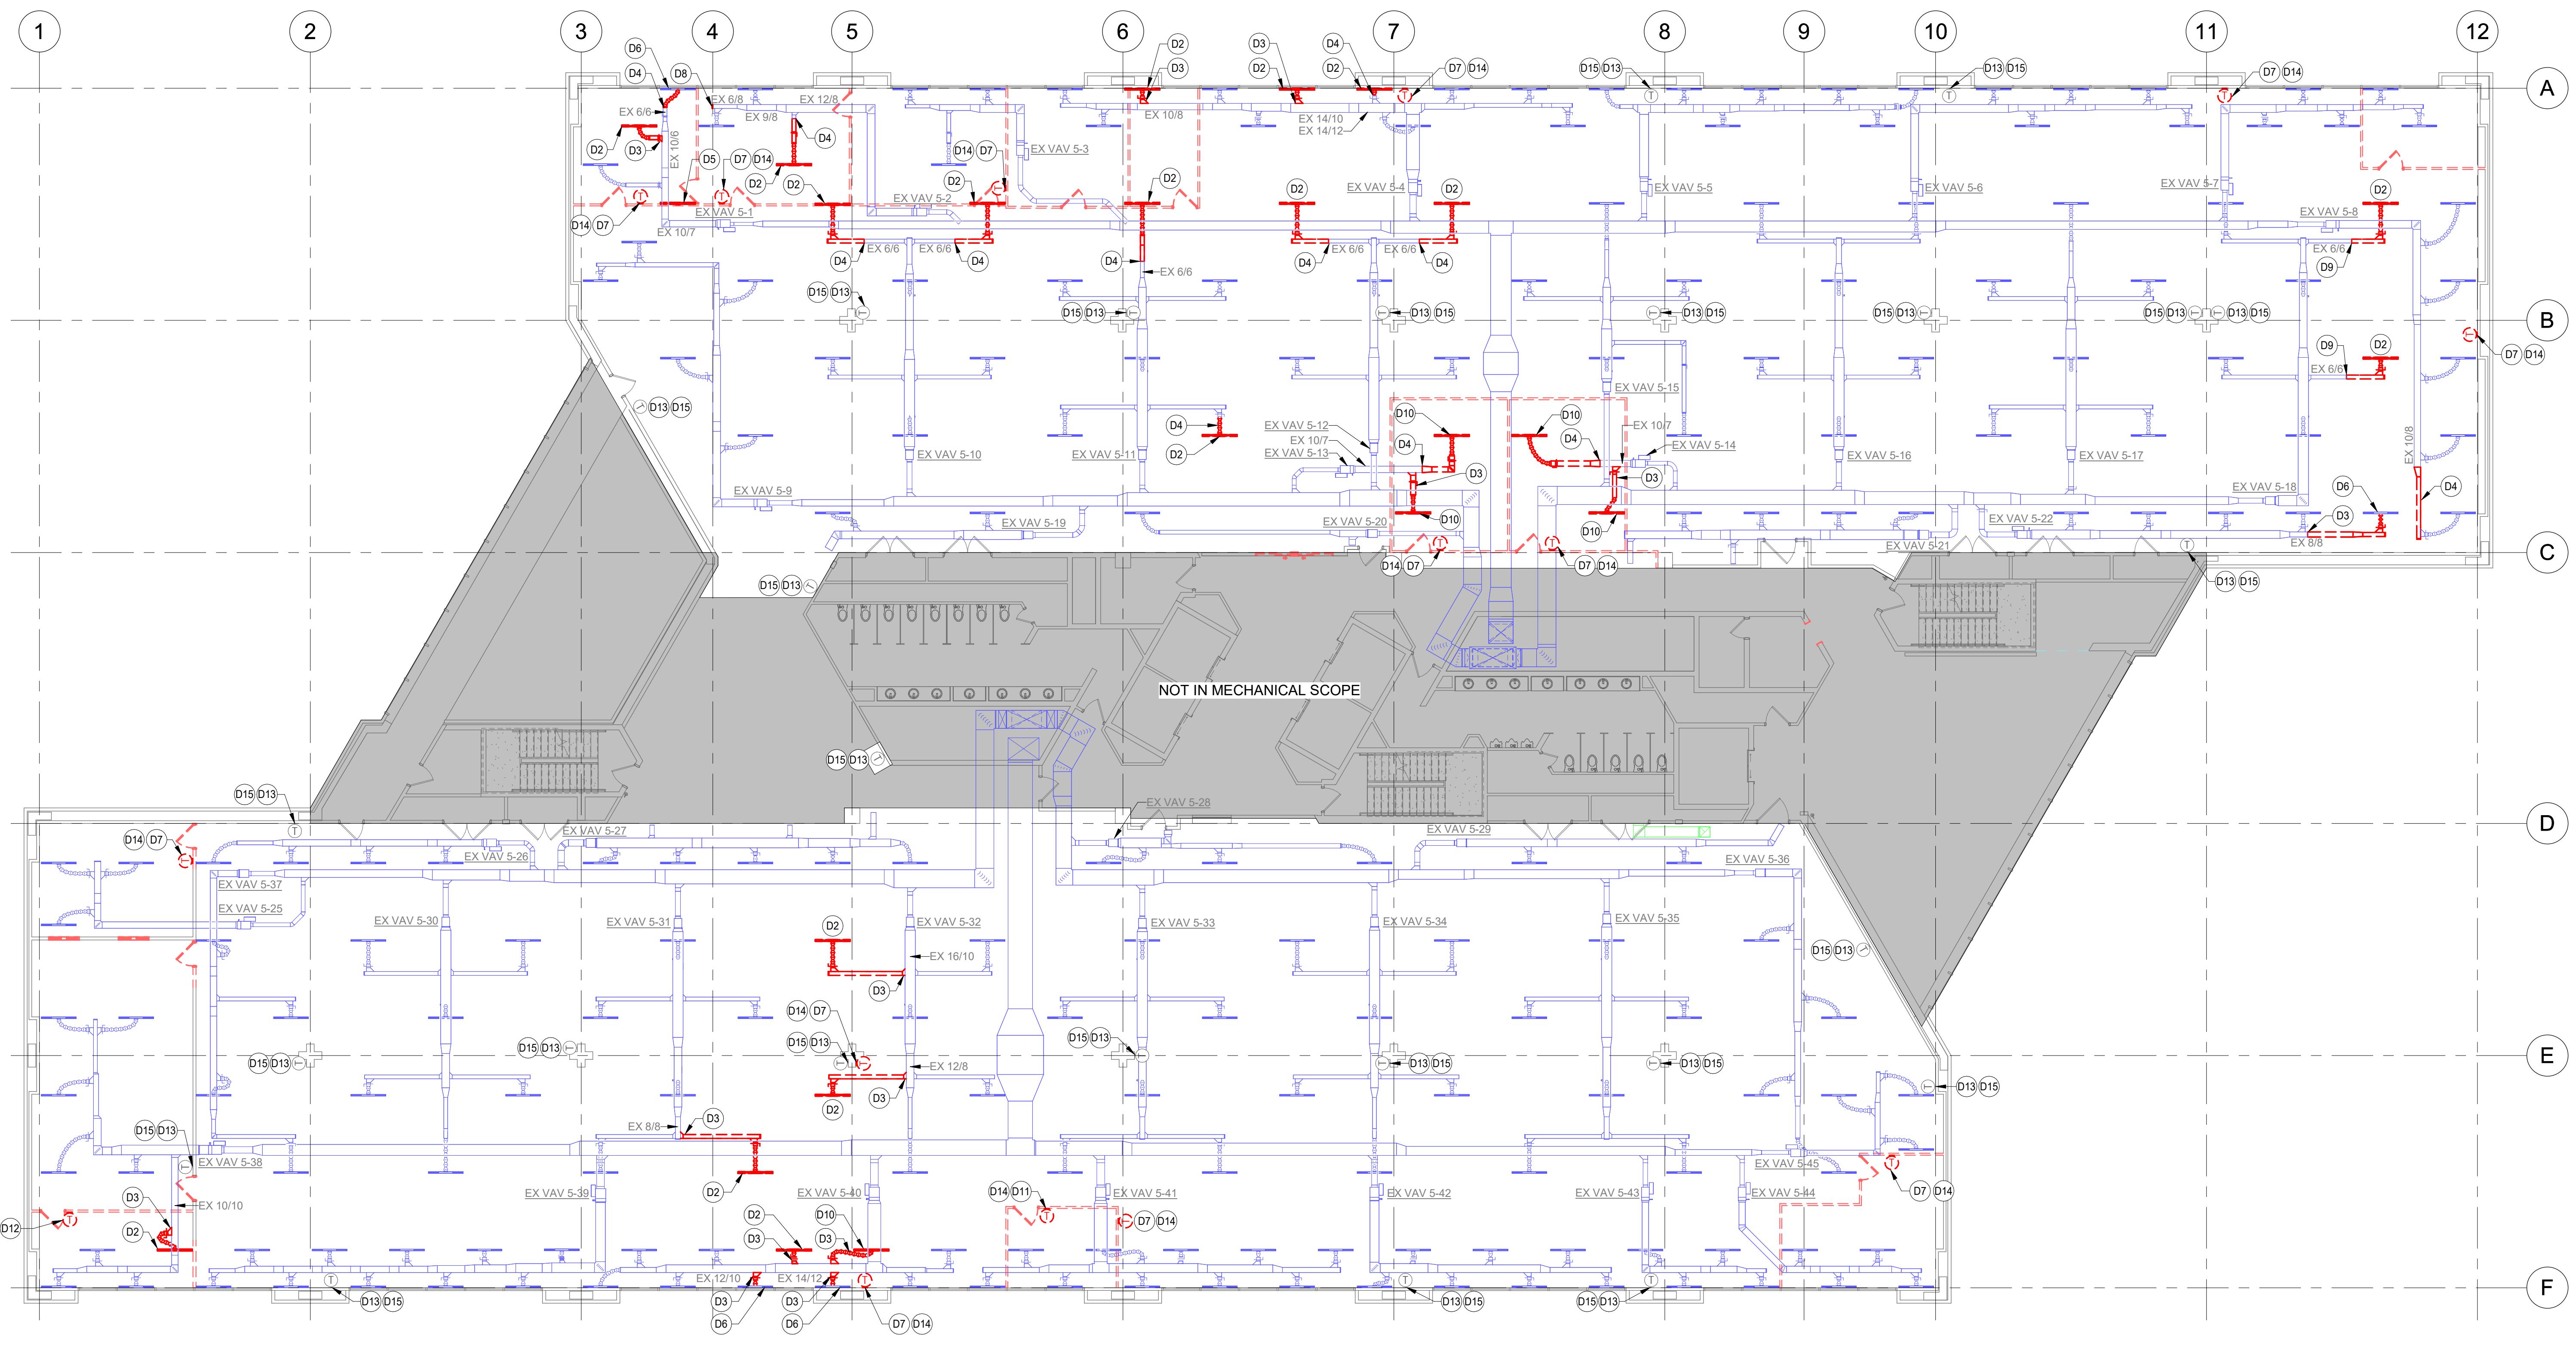

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PROJECT

## DAS CC IDALS HOOVER 5TH FLOOR RENOVATION

DES MOINES IOWA


REVISION SCHEDULE		
DATE	DESCRIPTION	BY

PROJECT NO.	24-31954
FILE NAME	31954 Mech R24
DRAWN BY	JKS
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TITLE

## FIFTH FLOOR MECHANICAL DEMOLITION PLAN

M1-11

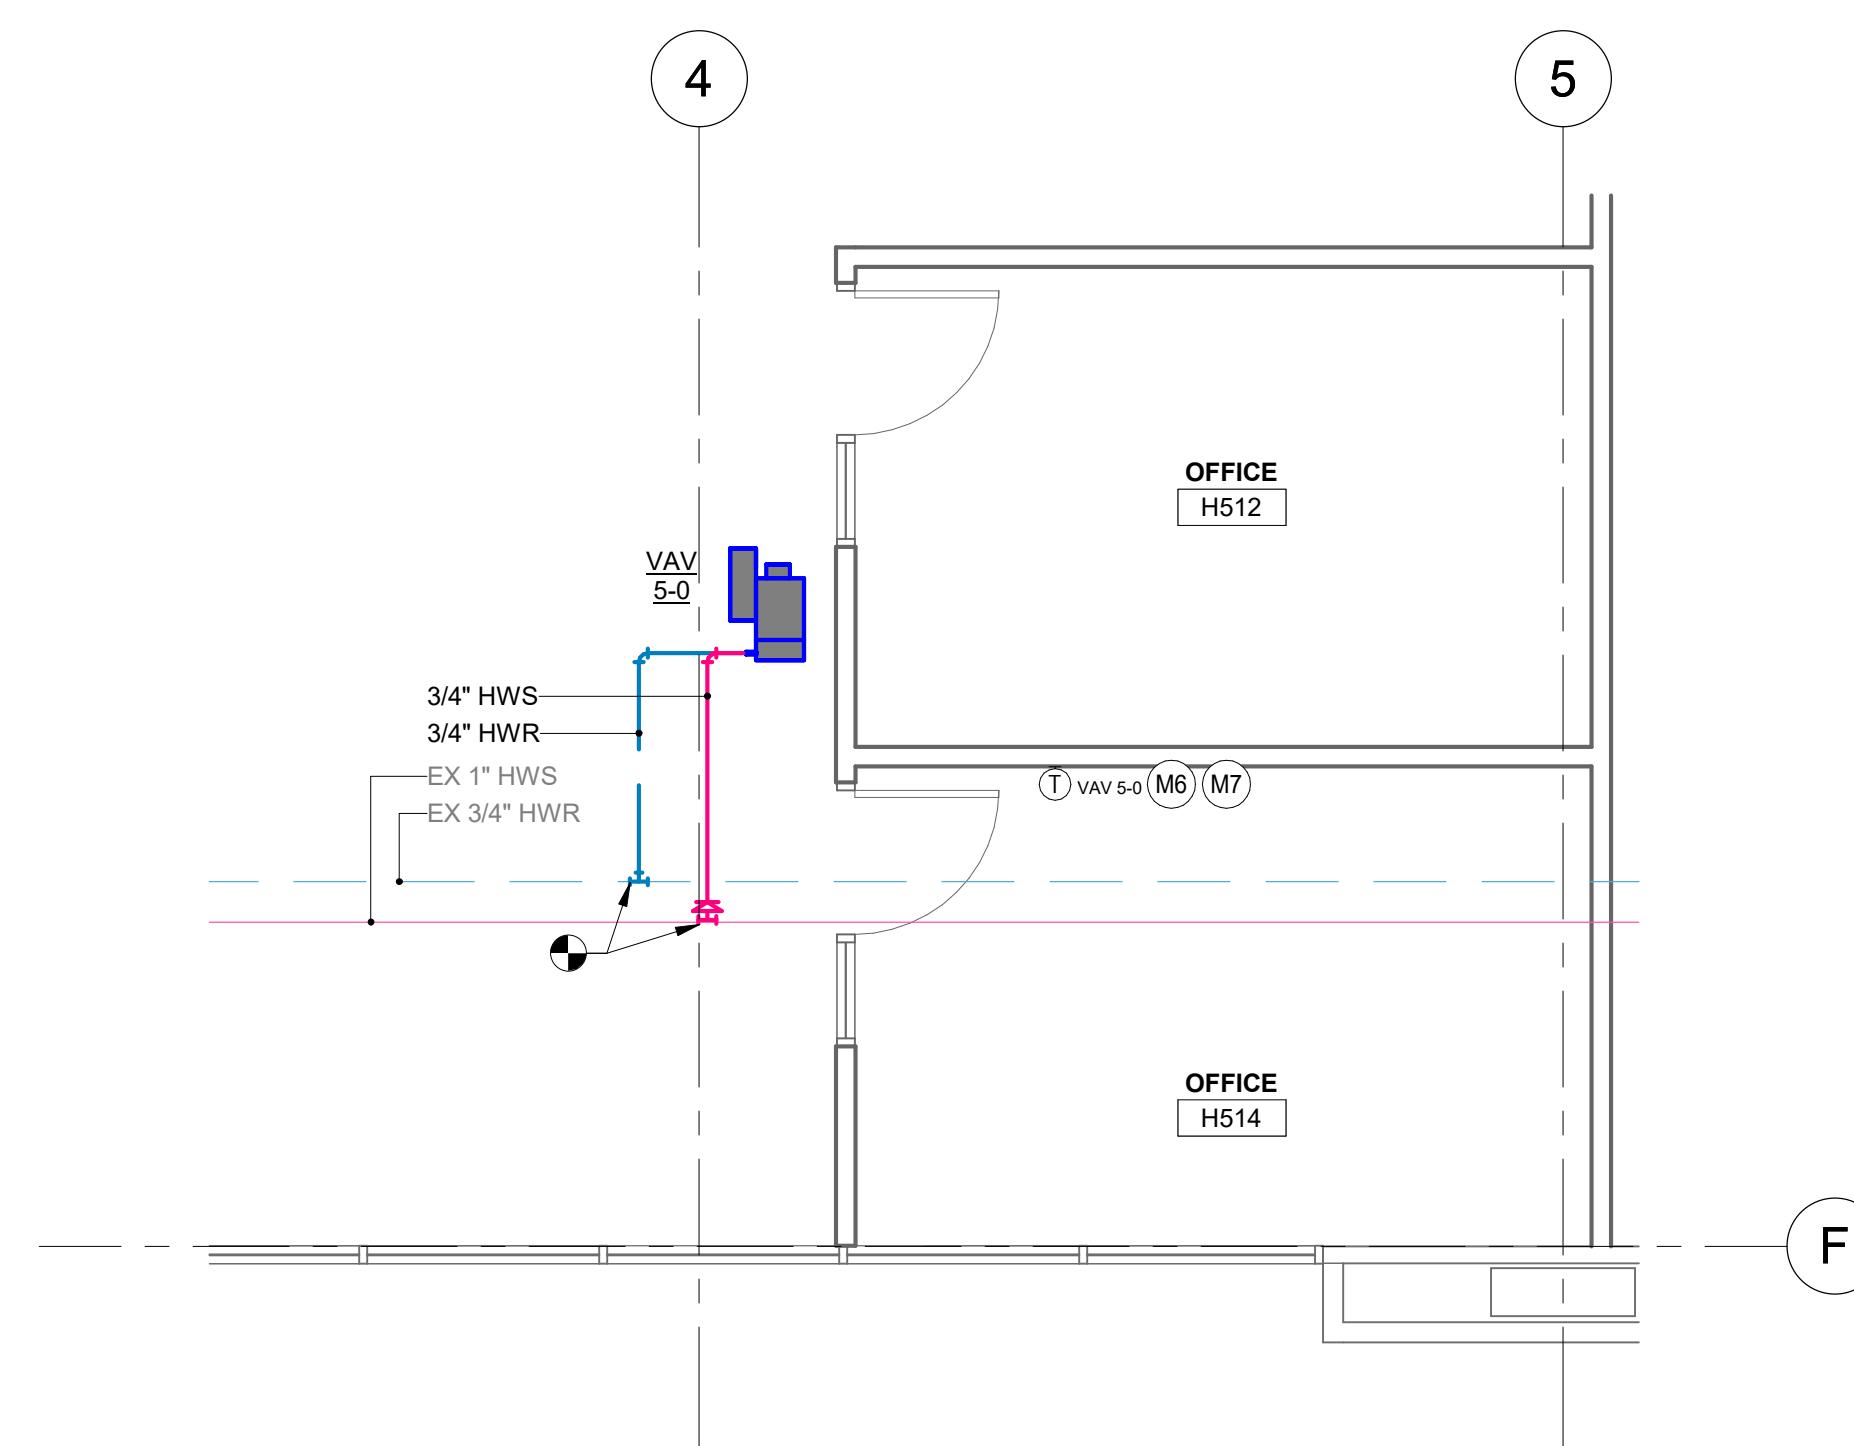


1 FIFTH FLOOR HYDRONIC PLAN  
1/4" = 1'-0"

SHEET NOTES	
1.	FIELD VERIFY ALL SITE CONDITIONS BEFORE STARTING CONSTRUCTION
2.	ALL EXISTING DUCTWORK, PIPING, EQUIPMENT, ETC. INDICATED ON PLANS ARE BASED ON INFORMATION FROM CONSTRUCTION DOCUMENTS AND FIELD VERIFICATION OF EXISTING BUILDING.
3.	ROUTE, STABILIZE AND TIGHTEN ALL NEW DUCTWORK, PIPING, EQUIPMENT, ETC. WITH OTHER TRADES.
4.	BASE BID EXISTING THERMOSTATS TO REMAIN OR BE RELOCATED. PAINT WIREMOLD TO MATCH ADJACENT WALL.
5.	ALTERNATE #2 ACCEPTED. INSTALL NEW THERMOSTATS IN PRIVATE OFFICES, CONFERENCE ROOMS, AND OPEN OFFICE SPACES. THERMOSTAT SHALL BE SIEMENS 3A4000. NO PREAPPROVED SUBSTITUTION SHALL BE ALLOWED. PAINT WIREMOLD TO MATCH ADJACENT WALL.

KEYNOTE LEGEND	
M1	BALANCE ALL DAMPERS DOWNSTREAM OF THE VAV BOX TO THE SPECIFIED AIRFLOW. ADJUST EXISTING VAV UNIT FOR NEW AIRFLOW. SEE SCHEDULE.
M2	BASE BID: RELOCATE AND REINSTALL EXISTING THERMOSTAT.
M3	ROUTE, STABILIZE AND TIGHTEN ALL NEW DUCTWORK, PIPING, EQUIPMENT, ETC. WITH OTHER TRADES.
M4	ALTERNATE #2: REPLACE EXISTING THERMOSTAT WITH NEW THERMOSTAT.
M5	ROUTE EXISTING DUCT UP TO GOOSENECK. SEE GOOSENECK EXISTING DETAIL.
M6	BASE BID: RELOCATE AND REINSTALL EXISTING THERMOSTAT. CONNECT TO VAV 5-0.
M7	ALTERNATE #2: INSTALL NEW THERMOSTAT. ROUTE ALL WIRING IN WALL. MOUNT TOP THERMOSTAT 48" ABOVE FINISHED FLOOR.
M8	ALTERNATE #2: INSTALL NEW THERMOSTAT ON EXISTING WALL. SURFACE MOUNT THERMOSTAT 60" ABOVE FINISHED FLOOR WITH WIREMOLD DEVICE BOX AND NONMETALLIC PLATE.
M9	ALTERNATE #2: INSTALL NEW THERMOSTAT. ROUTE ALL WIRING IN WALL. MOUNT THERMOSTAT 60" ABOVE FINISHED FLOOR TO MATCH EXISTING THERMOSTAT ELEVATION.
M10	COORDINATE WITH CONTROLS CONTRACTOR TO REPATH THERMOSTAT AFTER REDUCTION FROM TWO TO ONE SENSORS SERVING THE EXISTING VAV.

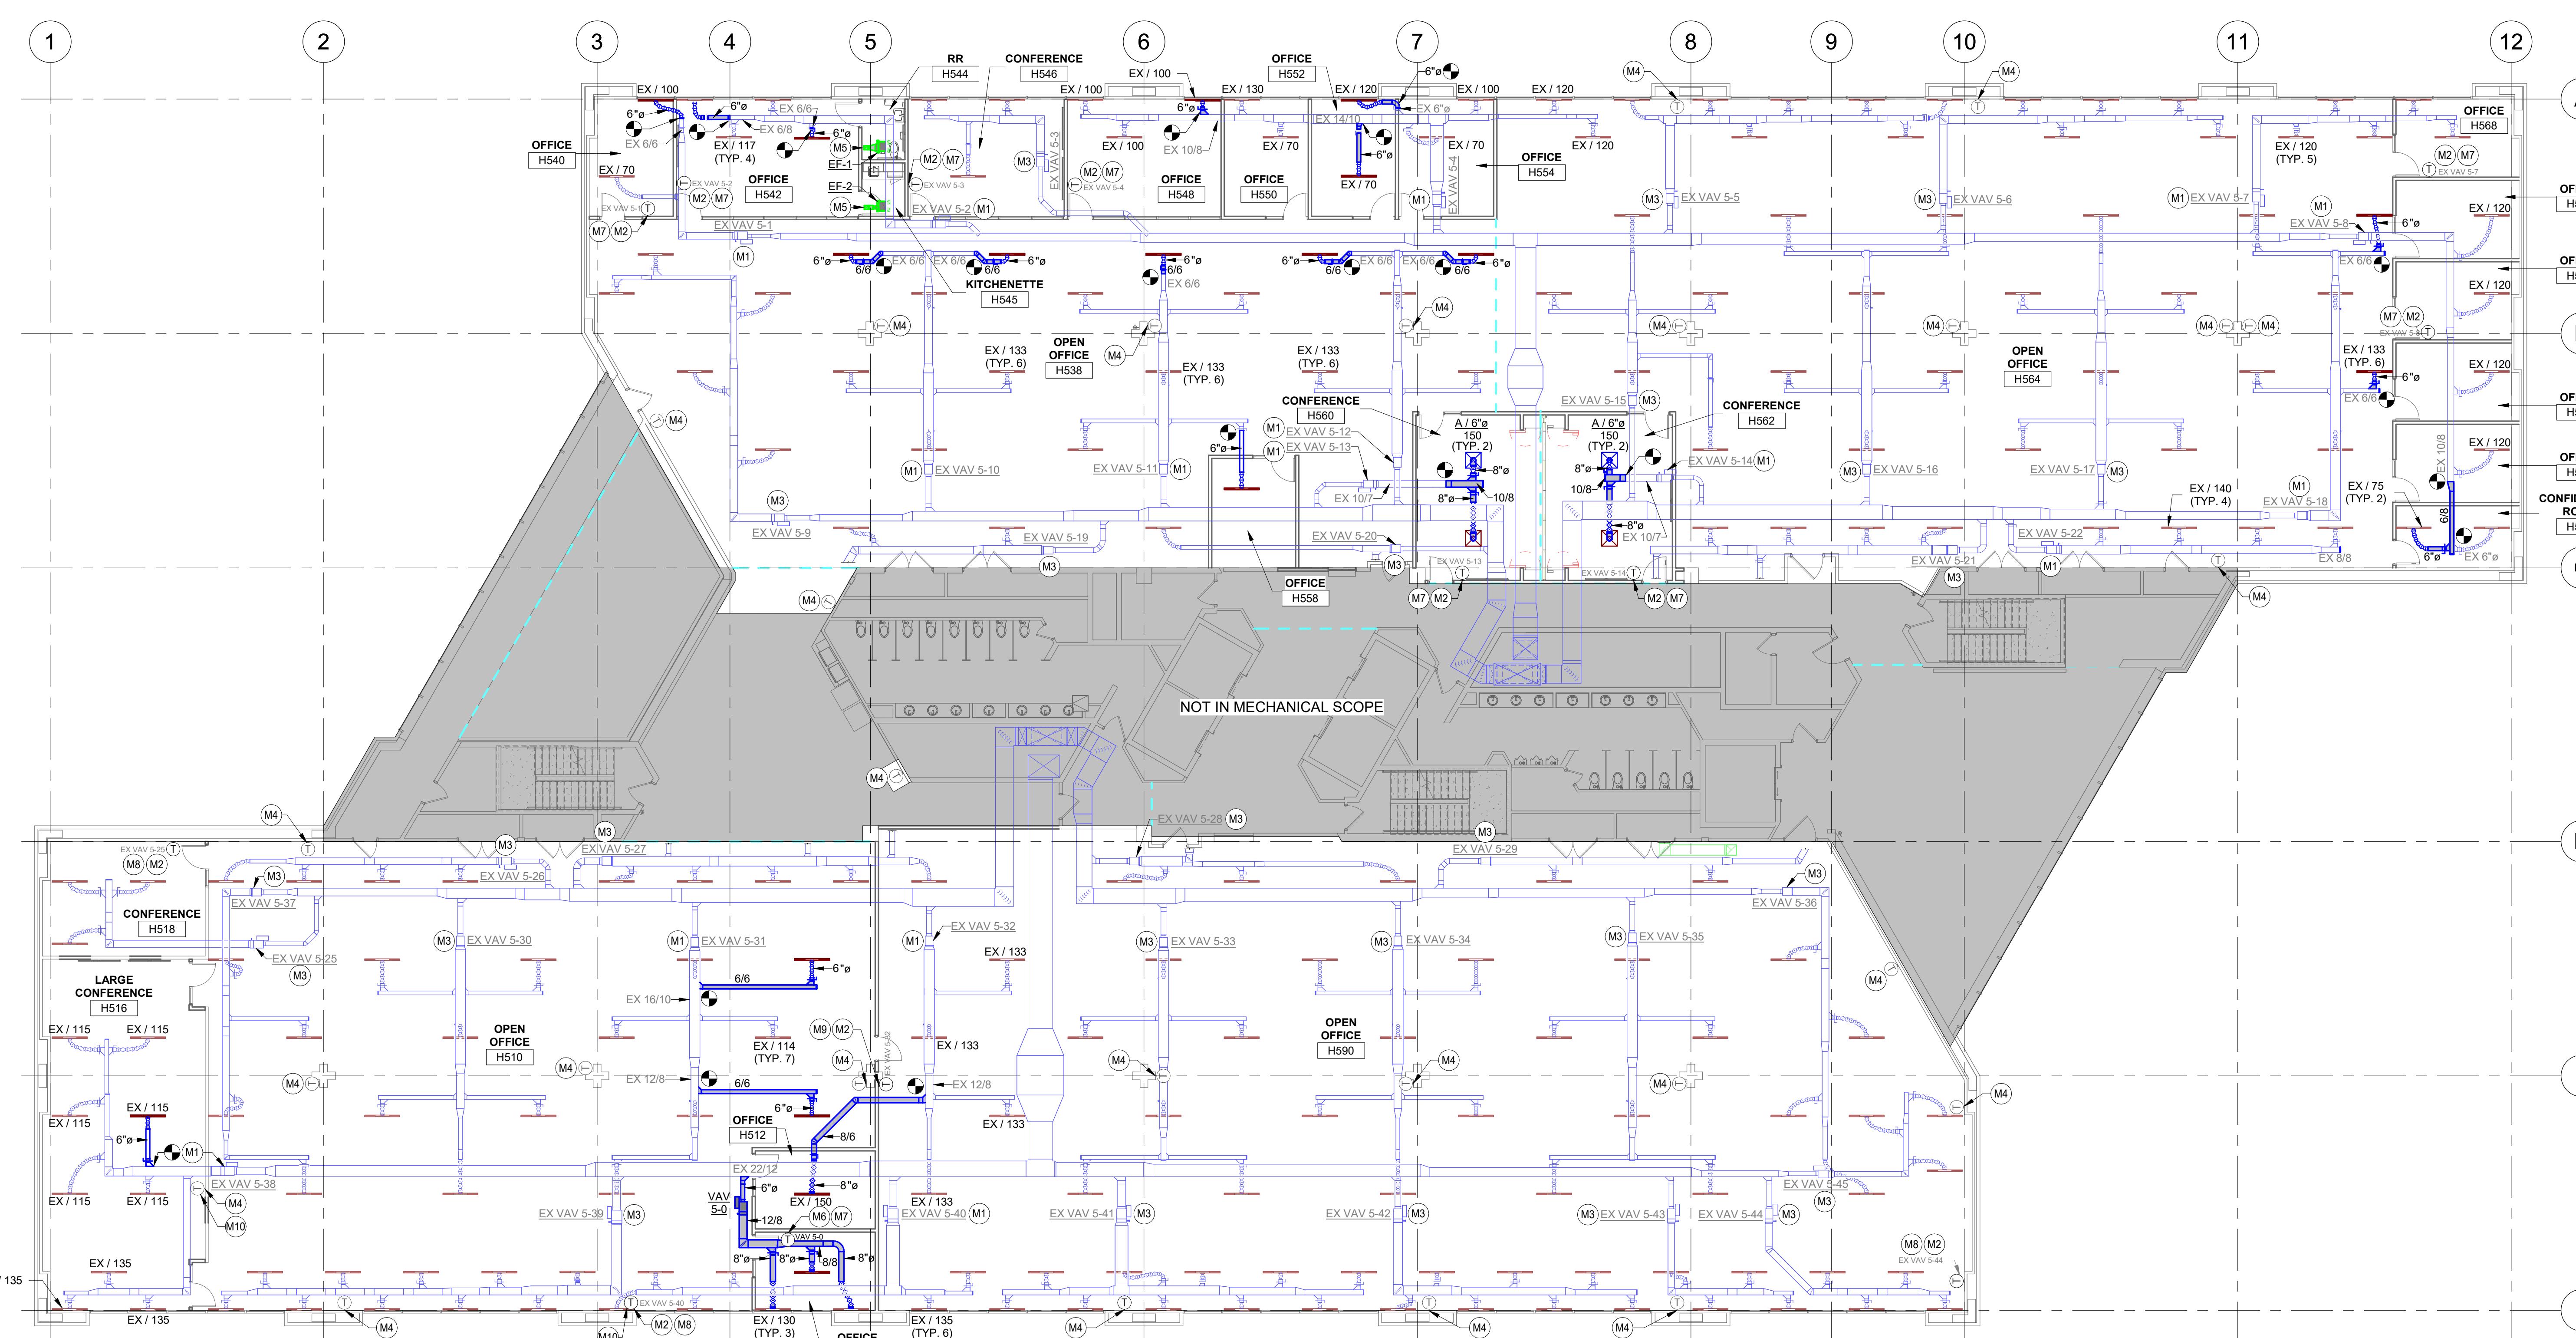

2 FIFTH FLOOR HVAC PLAN  
3/32" = 1'-0"

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PROJECT

## DAS CC IDALS HOOVER 5TH FLOOR RENOVATION

DES MOINES IOWA

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TITLE

## FIFTH FLOOR MECHANICAL PLAN

SHEET



EXHAUST FAN SCHEDULE													
MARK	MFR	MODEL	LOCATION	DRIVE	CFM	E.S.P.	SONES	FRPM	ELECTRICAL			WEIGHT	NOTES
									WATTS	VOLTAGE / PH.	AMPS		
EF-1	GREENHECK	SP-AP0511WL-1	H544 RR	DIRECT	70	0.3	2	878	16	115/1	0.29	16 lb	1,23,4
EF-2	GREENHECK	SP-B80	H545 KITCHENETTE	DIRECT	45	0.3	1.5	900	18	115/1	0.16	9 lb	1,23,4

VARIABLE AIR VOLUME (VAV) SCHEDULE																
MARK	MFR	MODEL	INLET DIAMETER	MAX CFM	MIN CFM	OUTPUT (MBH)	REHEAT COIL				WATER SIDE			# ROWS	NOTES	
							CFM	EAT (°F)	LAT (°F)	APD (IN. W.C.)	GPM	EWT (°F)	LWT (°F)	WPD (FT H2O)		
VAV 5-0	KRUEGER	LMHS	6	350	130	8.6	255	55	80	0.25	0.8	180	162.2	0.1	2	2,3,4,5
VAV 5-1	KRUEGER	LMHS	6	170	60	4.6	170	65	90	0.03	0.5	180	161.2	0.24	1	1,6
VAV 5-2	KRUEGER	LMHS	7	468	140	11.2	400	65	91	0.09	1	180	157.7	0.7	1	1
VAV 5-3	KRUEGER	LMHS	7	468	140	11.2	400	65	91	0.09	1	180	157.7	0.7	1	1
VAV 5-4	KRUEGER	LMHS	10	1100	375	20.6	800	65	89	0.27	3	180	166.3	1.5	1	1
VAV 5-5	KRUEGER	LMHS	8	791	240	13.8	500	65	91	0.24	2	180	166.2	2.5	1	1
VAV 5-6	KRUEGER	LMHS	7	565	170	11.2	400	65	91	0.13	1	180	157.7	0.7	1	1
VAV 5-7	KRUEGER	LMHS	7	600	180	11.2	400	65	91	0.14	1	180	157.7	0.7	1	1
VAV 5-8	KRUEGER	LMHS	7	630	210	12.4	460	65	90	0.13	2	180	167.6	2.5	1	1
VAV 5-9	KRUEGER	LMHS	7	530	160	7.9	295	65	90	0.12	0.5	180	148.5	0.2	1	1
VAV 5-10	KRUEGER	LMHS	8	798	240											1
VAV 5-11	KRUEGER	LMHS	8	798	240											1
VAV 5-12	KRUEGER	LMHS	8	665	200											1
VAV 5-13	KRUEGER	LMHS	6	300	90	7.1	265	65	90	0.07	1	180	165.9	0.5	1	1
VAV 5-14	KRUEGER	LMHS	6	300	90	7.1	265	65	90	0.07	1	180	165.9	0.5	1	1
VAV 5-15	KRUEGER	LMHS	8	665	200											1
VAV 5-16	KRUEGER	LMHS	8	798	240											1
VAV 5-17	KRUEGER	LMHS	8	798	240											1
VAV 5-18	KRUEGER	LMHS	8	798	240											1
VAV 5-19	KRUEGER	LMHS	8	541	165											1
VAV 5-20	KRUEGER	LMHS	9	940	285											1
VAV 5-21	KRUEGER	LMHS	8	560	200	9.8	365	65	90	0.17	1	180	160.4	0.7	1	1
VAV 5-22	KRUEGER	LMHS	6	399	120	10.2	350	65	92	0.12	2	180	169.8	1.8	1	1
VAV 5-23	KRUEGER	LMHS	7	532	160	7.4	275	65	90	0.12	0.5	180	150.5	0.2	1	1
VAV 5-24	KRUEGER	LMHS	10	1257	380											1
VAV 5-25	KRUEGER	LMHS	8	843	255											1
VAV 5-26	KRUEGER	LMHS	8	642	195											1
VAV 5-27	KRUEGER	LMHS	8	798	240											1
VAV 5-28	KRUEGER	LMHS	8	682	240											1
VAV 5-29	KRUEGER	LMHS	8	798	240											1
VAV 5-30	KRUEGER	LMHS	8	934	260	14.0	400	65	97	0.17	2	180	160.4	0.9	1	1
VAV 5-31	KRUEGER	LMHS	12	1306	400	19.6	545	65	90	0.17	1.5	180	160.0	0.34	1	1,6
VAV 5-32	KRUEGER	LMHS	12	1306	400	19.6	600	65	95	0.17	2	180	160.4	0.9	1	1
VAV 5-33	KRUEGER	LMHS	8	934	260	14.0	400	65	97	0.17	2	180	160.4	0.9	1	1
VAV 5-34	KRUEGER	LMHS	7	540	165	7.4	200	65	99	0.12	0.5	180	150.5	0.2	1	1
VAV 5-35	KRUEGER	LMHS	7	540	165	12.4	400	65	94	0.12	2	180	167.6	2.5	1	1
VAV 5-36	KRUEGER	LMHS	6	312	100	6.2	200	65	94	0.08	0.5	180	155.2	0.2	1	1

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**DAS CC IDALS  
HOOVER  
5TH FLOOR  
RENOVATION**

DES MOINES IOWA

REVISION SCHEDULE		
DATE	DESCRIPTION	BY

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FILE NAME	31954 Mech R24
DRAWN BY	JKS
DESIGNED BY	JKS
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CLIENT PROJECT NO.	9426.00

TITLE

**MECHANICAL  
SCHEMES AND  
SPECIFICATIONS**

SHEET  
**M5-11**

## ELECTRICAL KEYNOTE LEGEND


- 1 EXISTING ADDRESSABLE SMOKE DETECTOR. CONTRACTOR TO REMOVE AND STORE SMOKE DETECTOR HEADS AND CONDUCTORS. CONTRACTOR TO RELOCATE SMOKE DETECTOR HEADS BASE FOR CONSTRUCTION PHASE. REPLACE HEAT DETECTOR HEADS WITH EXISTING SMOKE DETECTOR HEADS AFTER CONSTRUCTION. COORDINATE WITH FIRE ALARM CONTRACTOR FOR MAINTENANCE CONTRACTOR TO REPROGRAM SYSTEM AS REQUIRED. TYPICAL UNLESS OTHERWISE NOTED.
- 2 EXISTING FIRE ALARM CONTROL PANEL LOCATED BELOW ON HOOVER A LEVEL.
- 3 EXISTING PANEL TO REMAIN. SHOWN FOR REFERENCE.
- 4 EXISTING WALL MOUNTED PA SPEAKER TO REMAIN.
- 5 EXISTING PA SPEAKER TO REMAIN AND BE PROTECTED. TYPICAL UNLESS OTHERWISE NOTED.
- 6 DEMOLISH EXISTING LIGHT FIXTURE. ENCLOSURES, RACEWAY, AND CONDUCTORS BACK TO SOURCE (TYPICAL). IN CASES WHERE NOT ALL DEVICES ON CIRCUIT ARE BEING DEMOLISHED, CONTRACTOR TO RE-ROUTE EXISTING DEVICES ON CIRCUIT NOT BEING DEMOLISHED. TYPICAL UNLESS OTHERWISE NOTED.
- 7 DEMOLISH EXISTING DEVICE, ENCLOSURES, RACEWAY, AND CONDUCTORS BACK TO SOURCE (TYPICAL). IN CASES WHERE NOT ALL DEVICES ON CIRCUIT ARE BEING DEMOLISHED, CONTRACTOR TO RE-ROUTE EXISTING DEVICES ON CIRCUIT NOT BEING DEMOLISHED.
- 8 DEMOLISH EXISTING RECESSED WALL MOUNTED JUNCTION BOX. EXTEND CONDUIT AND CONDUCTORS AS REQUIRED FOR RELOCATING JUNCTION BOX TO ABOVE ACCESSIBLE CEILING SPACE.
- 9 X INDICATES EXISTING DEVICE TO BE PROTECTED AND REMAIN.
- 10 ALL EXISTING DEVICES AND EQUIPMENT NOT INDICATED IN ELECTRICAL DEMOLITION PLANS ARE TO REMAIN AND BE PROTECTED.

## ELECTRICAL KEYNOTE LEGEND

- D6 EXISTING SMOKE DETECTOR TO BE REMOVED AND RELOCATED. EXTEND CONDUCTORS AS REQUIRED. SEE DOCUMENTS AND FIELD OBSERVATION OF THE EXISTING PLANS ARE BASED ON INFORMATION FROM CONSTRUCTION DOCUMENTS AND FIELD OBSERVATION OF THE EXISTING BUILDING.
- D7 DEMOLISH EXISTING SURFACE MOUNTED RACEWAY, DEVICE, AND CONDUCTORS BACK TO SOURCE (TYPICAL). IN CASES WHERE NOT ALL DEVICES ON CIRCUIT ARE BEING DEMOLISHED, CONTRACTOR TO RE-ROUTE EXISTING DEVICES ON CIRCUIT NOT BEING DEMOLISHED.
- D8 EXISTING LIGHT FIXTURE TO BE REMOVED AND RELOCATED. CONTRACTOR TO RE-ROUTE EXISTING DEVICES ON CIRCUIT NOT BEING REMOVED. CONNECT TO EXISTING LIGHTING CIRCUIT AND CONTROLS. EXTEND CONDUIT AND CONDUCTORS AS REQUIRED FOR RELOCATING HOT CIRCUIT.
- D9 EXISTING EXIT SIGN TO BE DEMOLISHED AND REPLACED BY NEW (TYPICAL). REUSE EXISTING UNSWITCHED HOT CIRCUIT.
- D10 EXISTING SELF ILLUMINATED TRITIUM EXIT SIGNAGE TO BE REMOVED AND DISPOSED OF PROPERLY FOLLOWING RADIOACTIVE WASTE REGULATIONS.
- D11 EXISTING FIRE ALARM DEVICE TO BE RELOCATED TO NEW WALL. REMOVE DEVICE AND COIL CONDUCTORS ABOVE NEW WALL. CONTRACTOR TO RE-ROUTE EXISTING DEVICES ON CIRCUIT FOR LOCATION. SEE NEW POWER AND FIRE ALARM PLAN FOR LOCATION.
- D12 EXISTING DATA DEVICE TO BE DEMOLISHED. DATA CABLEING TO BE COILED ABOVE CEILING TO BE REUSED.
- D13 PA SPEAKER TO BE REMOVED AND RELOCATED. SEE NEW POWER AND FIRE ALARM PLAN FOR LOCATION. EXTEND EXISTING CONDUIT AS REQUIRED.

## SHEET NOTES

1. ALL EXISTING ELECTRICAL EQUIPMENT INDICATED ON PLANS ARE BASED ON INFORMATION FROM CONSTRUCTION DOCUMENTS AND FIELD OBSERVATION OF THE EXISTING BUILDING.
2. ALL EXISTING DEVICES SHOWN ON DEMOLITION PLANS AND ASSOCIATED WIRES ARE TO BE DEMOLISHED BACK TO SOURCE OF POWER, UNLESS NOTED OTHERWISE.
3. CONTRACTOR SHALL REMOVE ALL ABANDONED CABLEING BACK TO SOURCE OF POWER.
4. CONTRACTOR IS RESPONSIBLE FOR RECONNECTION OF ANY EXISTING ACTIVE CIRCUITS AND/OR SPARE SYSTEM CABLES INTERRUPTED BY DEMOLITION AS REQUIRED TO KEEP OPERABLE.
5. ELECTRICAL PANELBOARDS AND SERVICE GEAR ARE TO REMAIN. PANELBOARDS ARE SHOWN FOR REFERENCE AND COORDINATION TO MAINTAIN CLEARANCES AROUND EQUIPMENT.
6. CONTRACTOR SHALL BE RESPONSIBLE FOR PATCHING AND PAINTING ALL SURFACES WHERE RACEWAY HAS BEEN REMOVED. MATCH ADJACENT SURFACE.
7. ALL ABANDONED SURFACE RACEWAY SHALL BE REMOVED AND PATCHED/PAINTED TO MATCH ADJACENT SURFACE.
8. CONTRACTOR TO COORDINATE WITH FIRE ALARM CONTROL MAINTENANCE CONTRACTOR FOR PROGRAMMING OF SYSTEM FOR SMOKE DETECTORS. CONSTRUCTION AND DEMOLITION CONTRACTOR IS RESPONSIBLE FOR FIRE DETECTORS DURING CONSTRUCTION AND REPROGRAMMING BACK TO SMOKE DETECTORS AFTER CONSTRUCTION PHASE IS COMPLETED.
9. X INDICATES EXISTING DEVICE TO BE PROTECTED AND REMAIN.
10. ALL EXISTING DEVICES AND EQUIPMENT NOT INDICATED IN ELECTRICAL DEMOLITION PLANS ARE TO REMAIN AND BE PROTECTED.

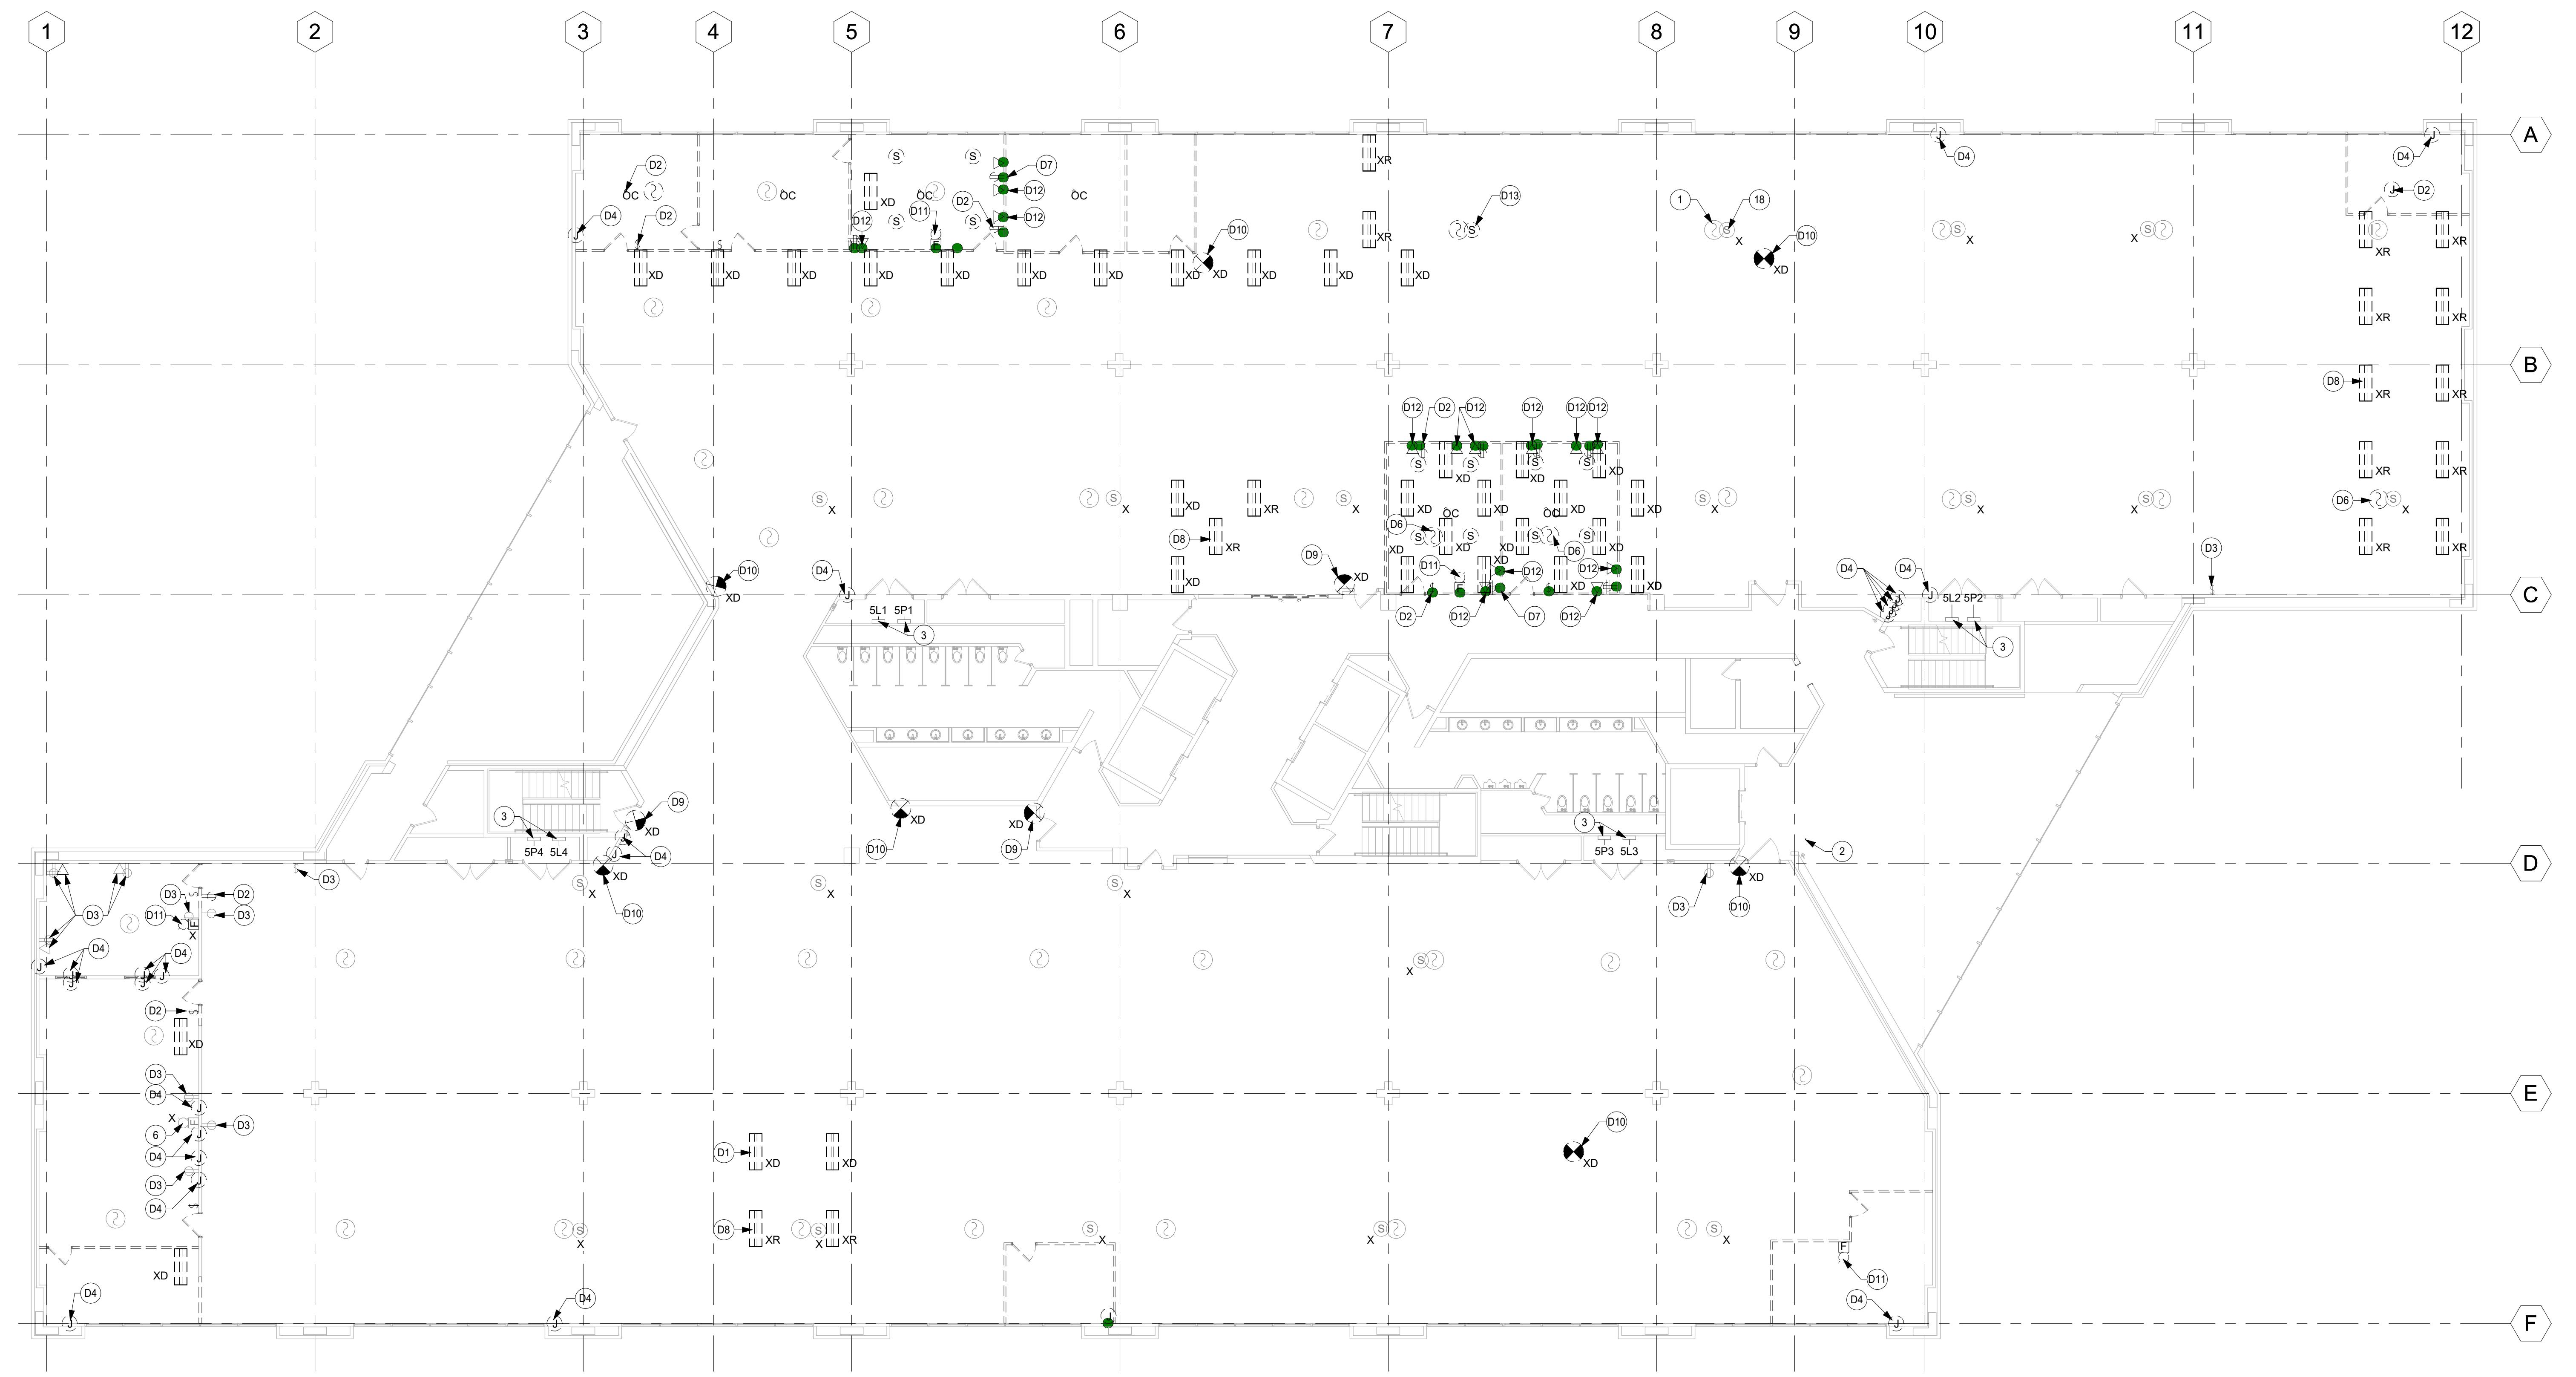1 LEVEL 5 ELECTRICAL DEMOLITION PLAN  
3/32" = 1'-0"

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PROJECT

## DAS CC IDALS HOOVER 5TH FLOOR RENOVATION

DES MOINES IOWA


REVISION SCHEDULE		
DATE	DESCRIPTION	BY

PROJECT NO.	24-31954
FILE NAME	31954_Elec_R24.rvt
DRAWN BY	AAG
DESIGNED BY	AAG
REVIEWED BY	RDS
ORIGINAL ISSUE DATE	01/21/2025
CLIENT PROJECT NO.	942600-01

TITLE

## LEVEL 5 ELECTRICAL DEMOLITION PLAN


SHEET  
E1-11

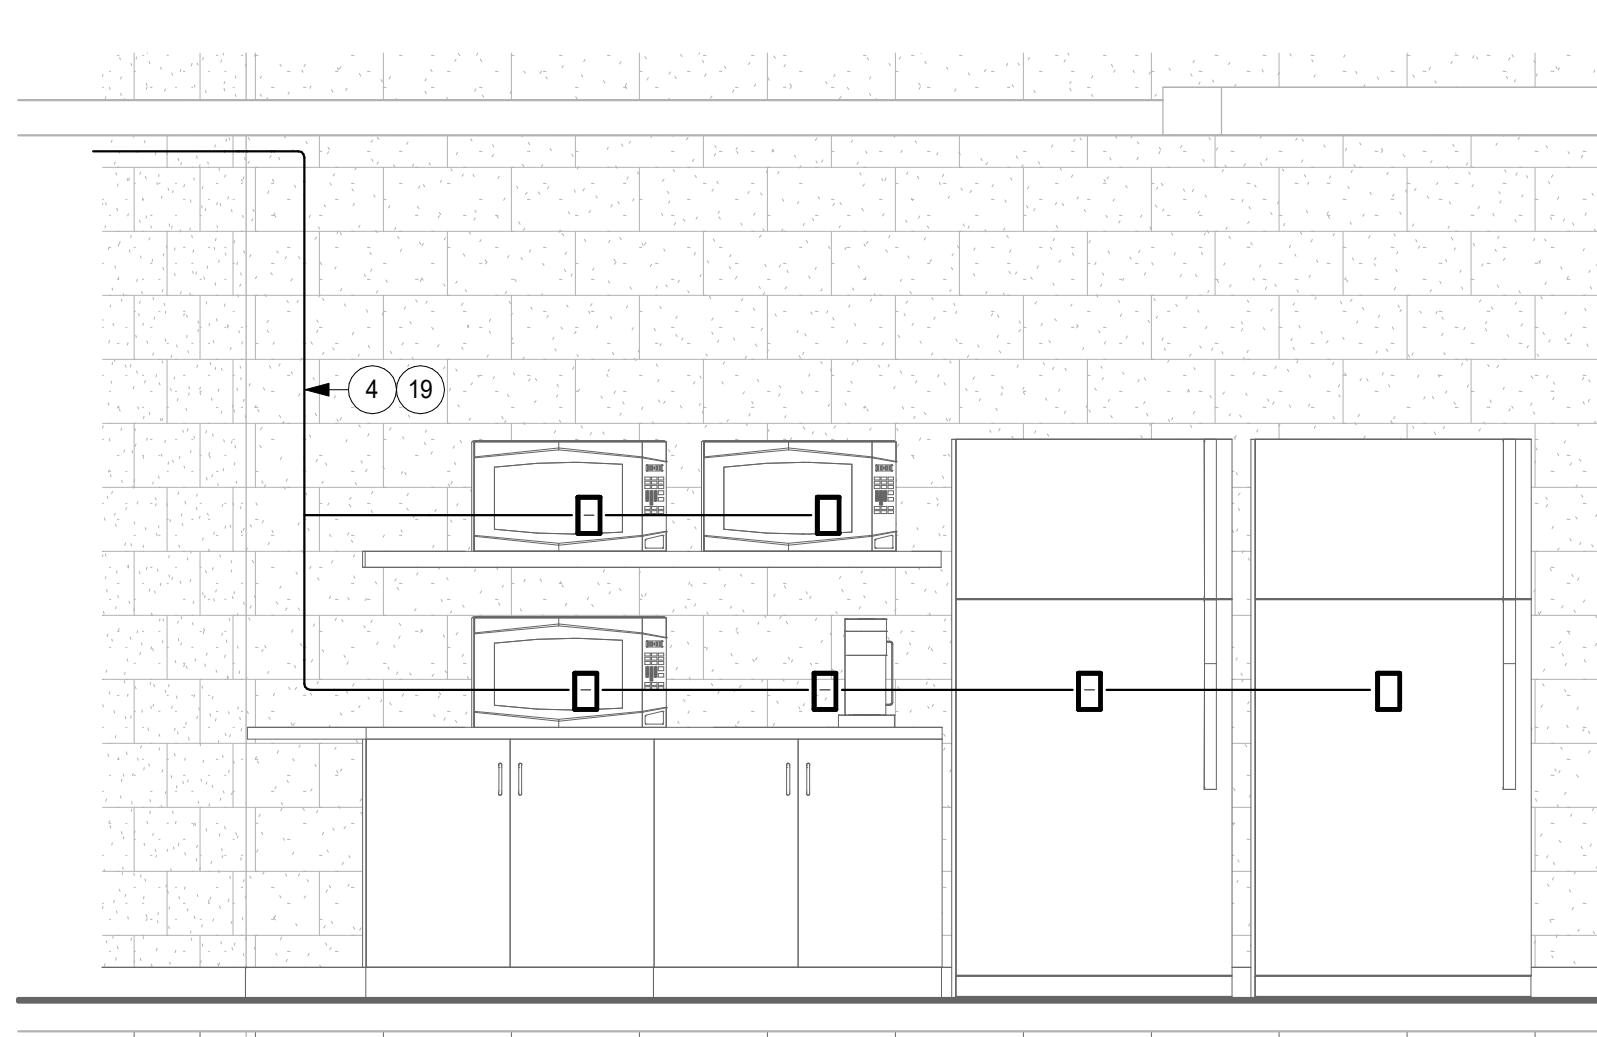

2 SURFACE MOUNTED RACEWAY ELEVATION  
1/2" = 1'-0"

ELECTRICAL KEYNOTE LEGEND	
2	EXISTING FIRE ALARM CONTROL PANEL LOCATED BELOW ON HOOVER A LEVEL
4	PROVIDE SURFACE MOUNTED RACEWAY AND DEVICES ON EXISTING CONCRETE FLOOR. PROVIDE 1/2" X 1/2" X 1/2" WHITE FINISH WIREMOLD SERIES 2400 OR APPROVED EQUAL. PROVIDE RACEWAY FROM DEVICES TO ACCESSIBLE CEILING CAVITY OR UNFINISHED SPACE
5	COORDINATE FINAL FURNITURE RECEPTACLE LOCATIONS WITH FURNITURE AND FURNITURE SUPPLIER PRIOR TO ROUGH-IN
7	OWNER PROVIDED DOGHOUSE. CONTRACTOR TO PROVIDE DUPLEX RECEPTACLE AND CUT OPENING IN RAISED FLOOR DUCT SYSTEM TO SUB FLOOR. PROVIDE DEDICATED CIRCUIT THROUGH EXISTING UNDER FLOOR DUCT SYSTEM POWER CIRCUIT
8	OWNER PROVIDED DOGHOUSE. CONTRACTOR TO PROVIDE DUPLEX RECEPTACLE AND CUT OPENING IN RAISED FLOOR DUCT SYSTEM TO SUB FLOOR. PROVIDE DEDICATED CIRCUIT THROUGH EXISTING UNDER FLOOR DUCT SYSTEM POWER CIRCUIT
9	OWNER PROVIDED DOGHOUSE. CONTRACTOR TO CUT OPENING IN RAISED FLOOR FOR ACCESS TO SUB FLOOR. PROVIDE CIRCUIT THROUGH EXISTING UNDER FLOOR DUCT SYSTEM TO SUB FLOOR. PROVIDE DEDICATED CIRCUIT POWER WHIP FOR FURNITURE. CONTRACTOR TO INSTALL AND TERMINATE POWER WHIP FROM DOGHOUSE TO FURNITURE FEED POINT
15	ROUTE SURFACE MOUNTED RACEWAY WITH SINGLE VERTICAL SECTION UP TO CEILING ROUTED TO ELEC ROOM H532
20	CONNECT TO EXISTING RECEPTACLE POWER CIRCUIT
D3	EXISTING DEVICE AND FACEPLATE TO BE REPLACED WITH NEW. MATCH NEW DEVICE AND FACEPLATE FINISHES
D6	EXISTING SMOKE DETECTOR TO BE REMOVED AND LOGGED. EXISTING CONDUCTORS AS REQUIRED. SEE POWER AND FIRE ALARM PLAN FOR NEW LOCATION
D11	EXISTING FIRE ALARM DEVICE TO BE RELOCATED TO NEW WALL. REMOVE DEVICE AND COIL CONDUCTORS ABOVE GELCOOL. SEE CONDUCTORS AS REQUIRED. SEE NEW POWER AND FIRE ALARM PLAN FOR NEW LOCATION
D13	PA SPEAKER TO BE REMOVED AND RELOCATED. SEE NEW POWER AND FIRE ALARM PLAN FOR LOCATION. EXTEND EXISTING CONDUCTORS AS REQUIRED

SHEET NOTES	
1.	ALL EXISTING ELECTRICAL EQUIPMENT INDICATED ON PLANS ARE BASED ON INFORMATION FROM CONSTRUCTION DOCUMENTS AND FIELD OBSERVATION OF THE EXISTING BUILDING
2.	"X" = INDICATES EXISTING DEVICE TO REMAIN
3.	MAINTAIN FIRE RATING OF ALL WALLS AND FLOORS. PROVIDE FIRE PROOFING FOR ALL WALL AND FLOOR PENETRATIONS PER CODE
4.	COORDINATE WORK WITH OTHER TRADES
5.	CIRCUIT NUMBERS ARE USED FOR DESIGN INTENT TO EXISTING PANELBOARDS. ELECTRICAL CONTRACTOR SHALL VERIFY EXACT CIRCUIT NUMBERS IN THE FIELD
6.	CONTRACTOR TO COORDINATE WITH FIRE ALARM CONTROL MAINTENANCE CONTRACTOR FOR PROGRAMMING OF SYSTEM FOR SMOKE DETECTORS IN CONSTRUCTION AREAS TO BE REMOVED AND REPLACED WITH HEAT DETECTORS DURING CONSTRUCTION AND REPROGRAMMING BACK TO SMOKE DETECTORS AFTER CONSTRUCTION PHASE IS COMPLETED
7.	COORDINATE DEVICE LOCATIONS WITH FURNITURE SUPPLIER AND OWNER PRIOR TO ROUGH-IN FOR FINAL LOCATIONS. IF CHANGE IN DIMENSIONS SHOWN IN PLANS IS REQUIRED, COORDINATE WITH OWNER PRIOR TO ROUGH-IN
8.	ALL WALL DEVICES TO BE RECESSED INTO WALL UNLESS OTHERWISE NOTED. INCLUDE DEVICES FROM TECHNOLOGY PLANS

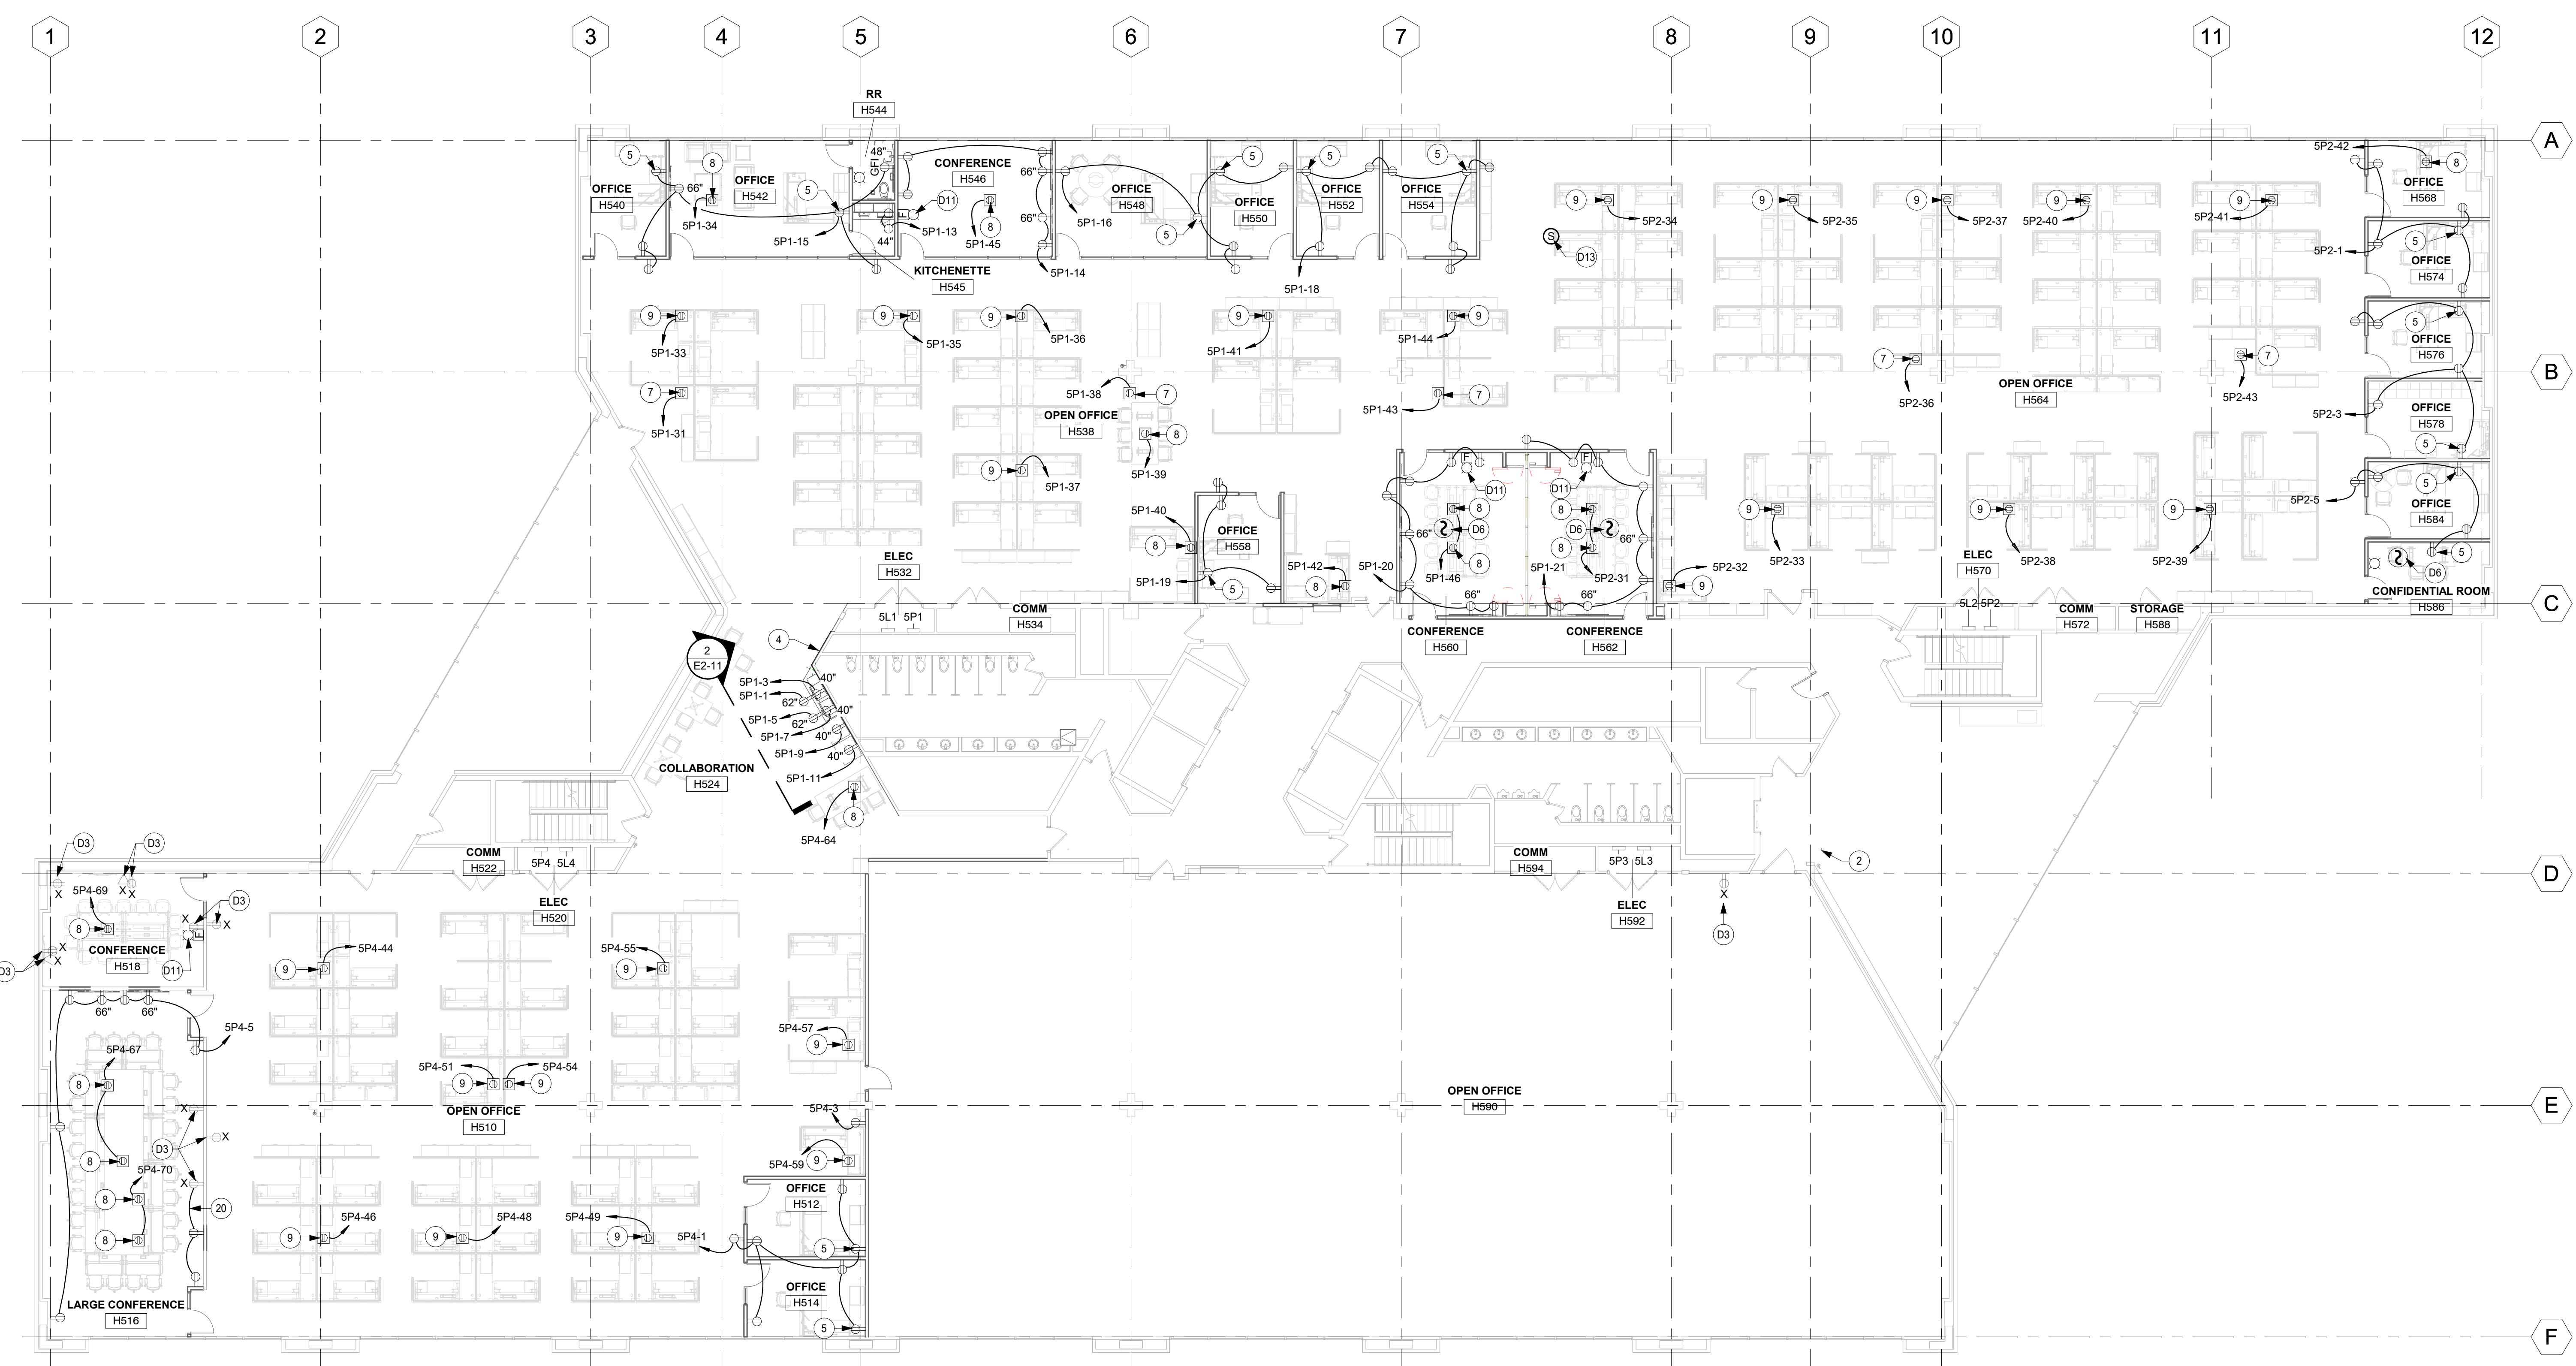


## ELECTRICAL KEYNOTE LEGEND

5 COORDINATE FINAL FURNITURE RECEPTACLE LOCATIONS WITH OWNER AND FURNITURE SUPPLIER PRIOR TO PLANS ARE BASED ON INFORMATION FROM CONSTRUCTION DOCUMENTS AND FIELD OBSERVATION OF THE EXISTING BUILDING.

13 EXISTING SUB FLOOR VDE DUCT TRAY SYSTEM FOR ROUTING OF DATA AND POWER CIRCUITS. DOUGHOUSE PUNCH FOR ACCESS TO TRAY AT TICK MARKS SHOWN.

## SHEET NOTES

- ALL EXISTING ELECTRICAL EQUIPMENT INDICATED ON PLANS ARE BASED ON INFORMATION FROM CONSTRUCTION DOCUMENTS AND FIELD OBSERVATION OF THE EXISTING BUILDING.
- "X" = INDICATES EXISTING DEVICE TO REMAIN.
- MAINTAIN FIRE RATING OF ALL WALLS AND FLOORS. PROVIDE FIRE PROOFING FOR ALL WALL AND FLOOR PENETRATIONS PER CODE.
- COORDINATE WORK WITH OTHER TRADES.
- CIRCUIT NUMBERS ARE USED FOR DESIGN INTENT TO EXISTING PANELBOARDS. ELECTRICAL CONTRACTOR SHALL VERIFY EXACT CIRCUIT NUMBERS IN THE FIELD.
- CONTRACTOR TO COORDINATE WITH FIRE ALARM CONTROL, MAINTENANCE CONTRACTOR FOR PROGRAMMING OF SYSTEM FOR SMOKE DETECTORS IN CONSTRUCTION AREAS TO BE REMOVED AND REPLACED WITH HEAT DETECTORS DURING CONSTRUCTION AND REPROGRAMMING BACK TO SMOKE DETECTORS AFTER CONSTRUCTION PHASE IS COMPLETED.
- COORDINATE DEVICE LOCATIONS WITH FURNITURE SUPPLIER AND OWNER PRIOR TO ROUGH-IN FOR FINAL LOCATIONS. IF CHANGE IN DIMENSIONS SHOWN IN PLANS IS REQUIRED, COORDINATE WITH OWNER PRIOR TO ROUGH-IN.
- ALL WALL DEVICES TO BE RECESSED INTO WALL UNLESS OTHERWISE NOTED. INCLUDE DEVICES FROM TECHNOLOGY PLANS.

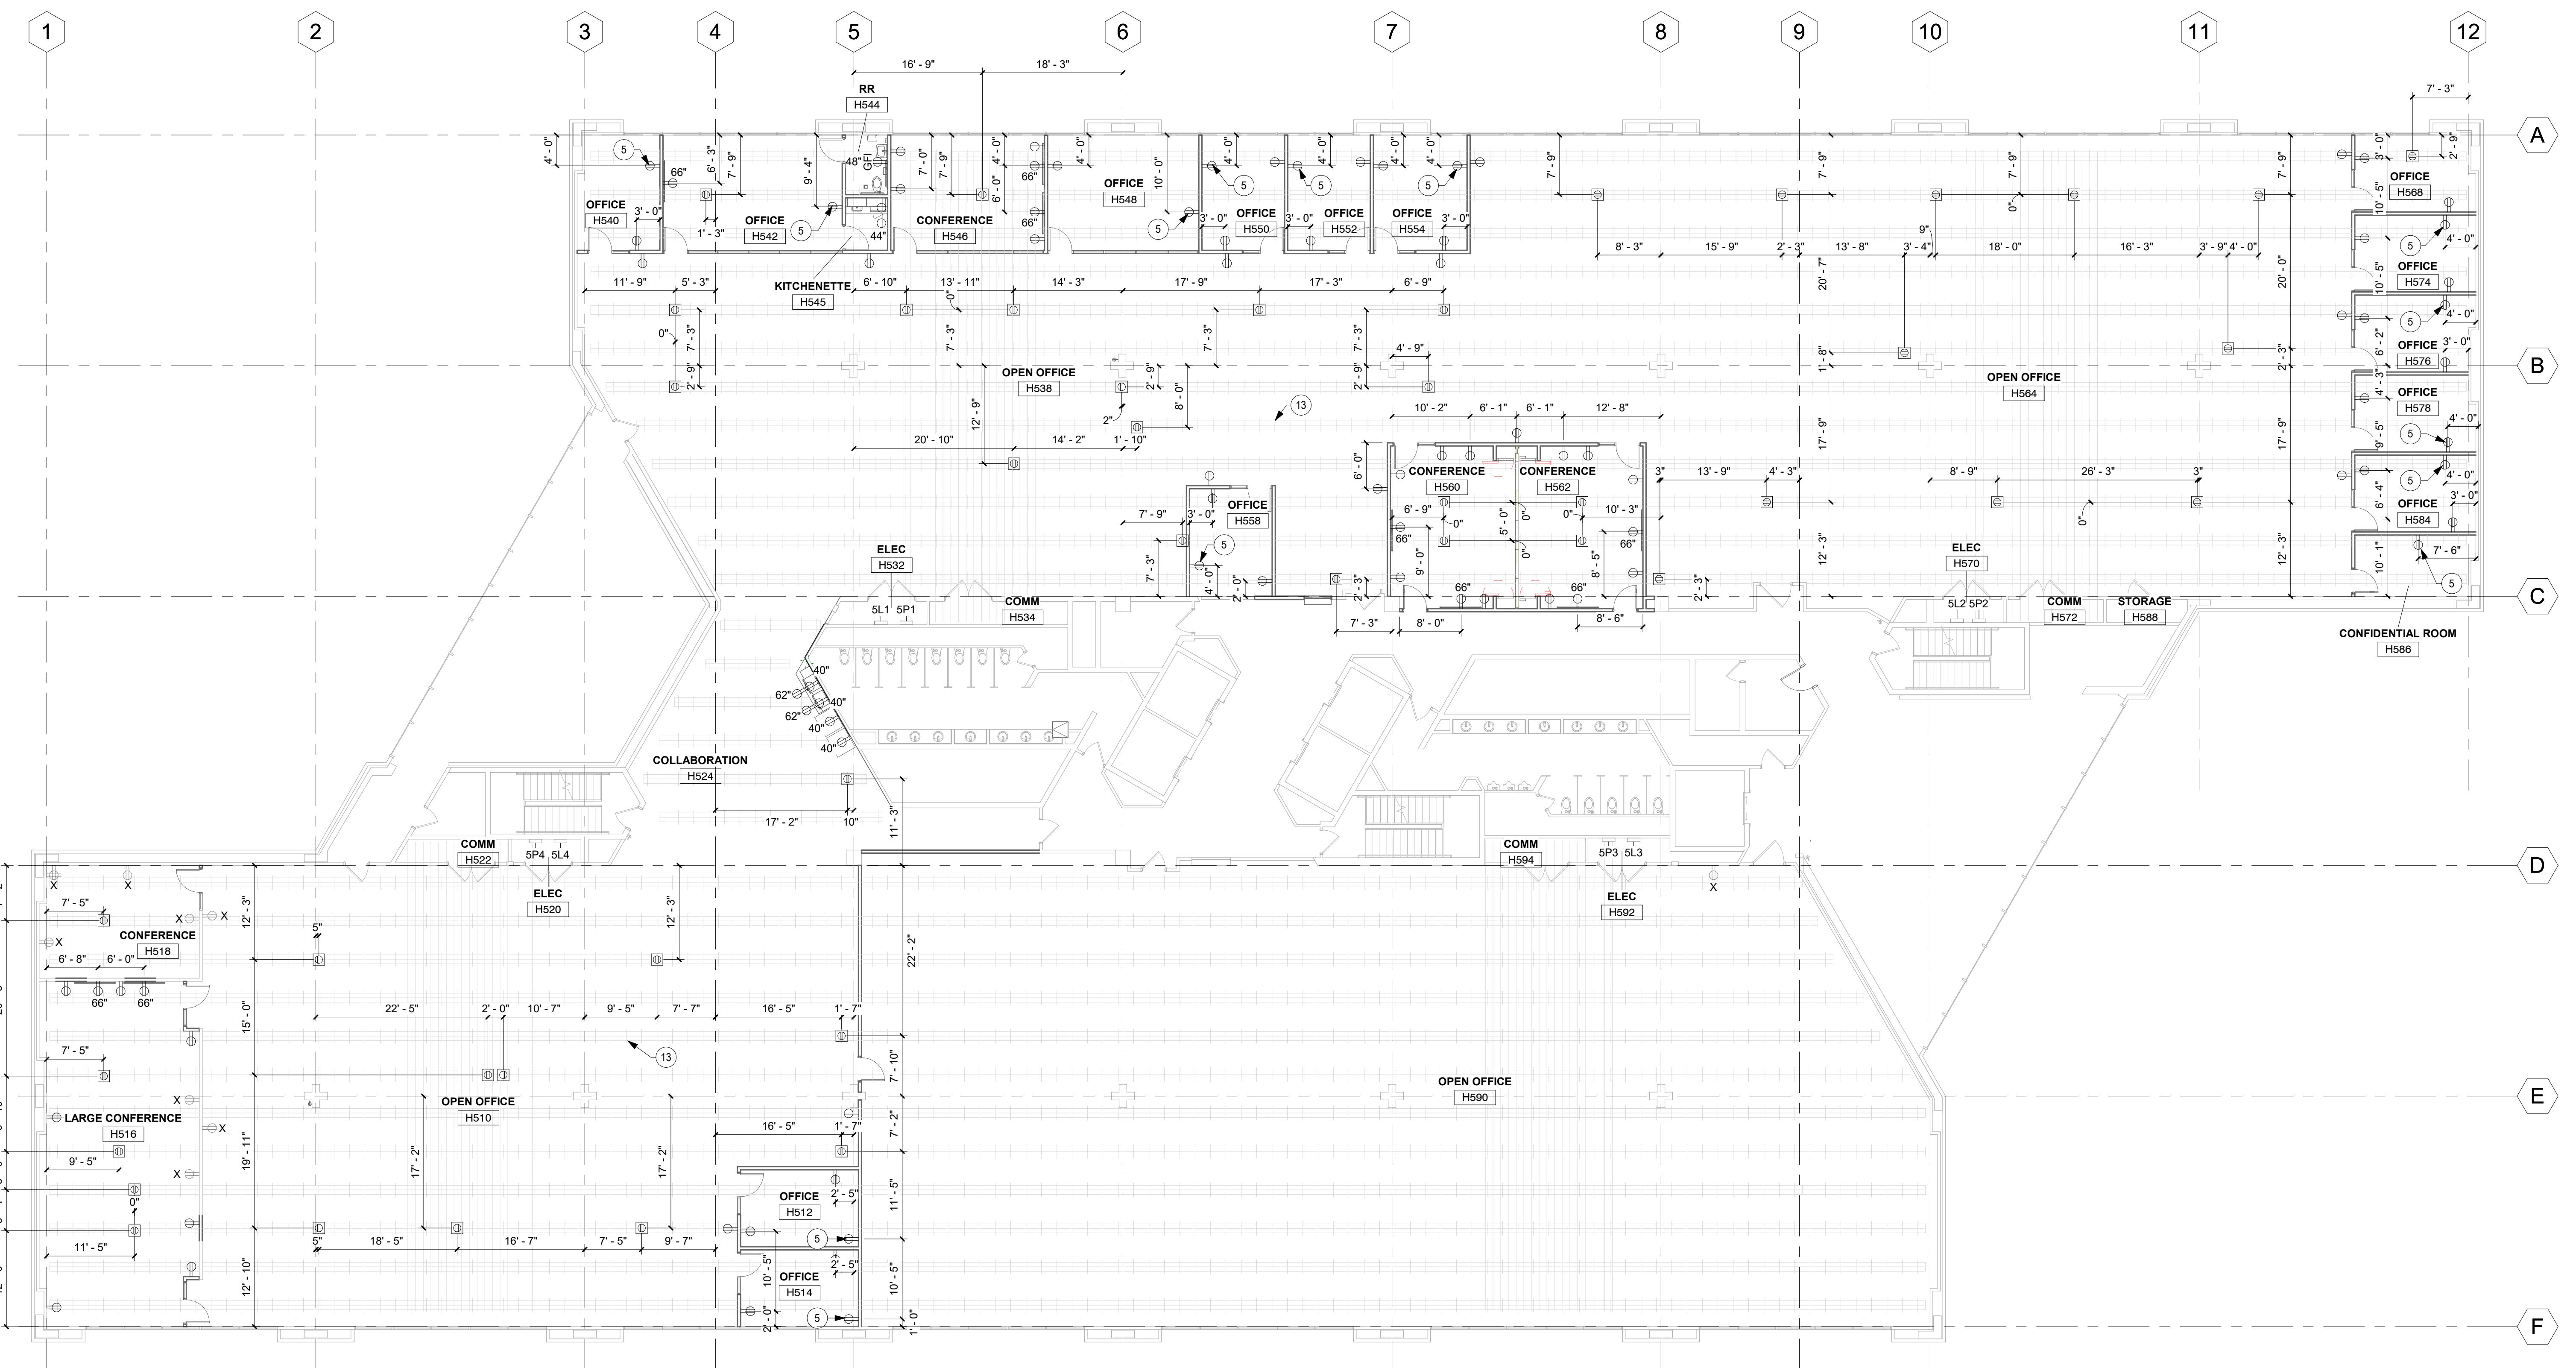1 LEVEL 5 POWER DEVICE DIMENSIONS  
3/32" = 1'-0"

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PROJECT

## DAS CC IDALS HOOVER 5TH FLOOR RENOVATION

DES MOINES IOWA

REVISION SCHEDULE			
DATE	DESCRIPTION	BY	

PROJECT NO. 24-31954  
FILE NAME 31954 Elec R24.rvt  
DRAWN BY AAG  
DESIGNED BY AAG  
REVIEWED BY RDS  
ORIGINAL ISSUE DATE 01/21/2025  
CLIENT PROJECT NO. 942600-01

TITLE

## LEVEL 5 POWER DEVICE DIMENSIONS




E2-12

## ELECTRICAL KEYNOTE LEGEND

- CONNECT NEW LIGHTING TO UNSWITCHED HOT CONDUCTOR FROM EXISTING LIGHTING CIRCUIT. EXTEND CONDUIT AND CONDUCTORS AS REQUIRED.
- RELEASE EXISTING EXIT SIGNAGE EMERGENCY EGGS CIRCUIT AND MOUNTING FOR NEW EXIT SIGNAGE LIGHTING CIRCUIT.
- REWIRE EXISTING LIGHTING FIXTURES TO SPACES EXISTING LIGHTING CIRCUIT AND UNSWITCHED HOT AND PROVIDED CONTROLS. EXTEND CONDUIT AND CONDUCTORS AS REQUIRED.
- CONNECT EXISTING LIGHTING FIXTURES TO NEW SPACE EXISTING LIGHTING CIRCUIT AND CONTROLS. EXTEND CONDUIT AND CONDUCTORS AS REQUIRED.
- PROVIDE UL223A TRANSFER DEVICE AND PROVIDE CONNECTION FROM FLOOR LIGHTING CIRCUIT. IDENTIFY FIXTURE IN FIELD WITH RED DOT ON FIXTURE FRAME.
- PROVIDE LIGHTING CONTACTOR AND RELAYS IN ELEC H592 CONNECTED TO NEW MANUAL SWITCH TO CONTROL OPEN/GROUNDING CIRCUIT. PROVIDE EXISTING LOCAL 24VDC TIME CLOCK OVERRIDE. LIGHTING CONTROLS TO UTILIZE EXISTING TIME CLOCK WITH LOCAL MANUAL OFF OVERRIDE. EXISTING MANUAL CONTROL CIRCUITING TO BE REVISED AS REQUIRED.
- EXISTING DEVICE AND FACEPLATE TO BE REPLACED WITH NEW. MATCH NEW DEVICE AND FACEPLATE FINISHES.


## SHEET NOTES

- ALL NEW ELECTRICAL EQUIPMENT INDICATED ON PLANS ARE BASED ON INFORMATION FROM CONSTRUCTION DOCUMENTS AND FIELD OBSERVATION OF THE EXISTING BUILDING.
- IT IS THE CONTRACTOR'S RESPONSIBILITY TO ENSURE COMPATIBLE LIGHTING CONTROL DEVICES ARE SUPPLIED WITH LIGHTING PACKAGE.
- REFER TO MANUFACTURERS INSTALLATION INSTRUCTIONS PRIOR TO INSTALLATION.
- ALL LIGHTING SHALL COMPLY WITH LOCAL AND STATE ENERGY CODES.
- PROVIDE UNSWITCHED HOT TO ALL EXIT AND EMERGENCY LIGHT FIXTURES.
- PROVIDE SEPARATE BOXES AND CONDUIT FOR EMERGENCY AND NORMAL LIGHTING CIRCUITS.
- MAINTAIN FIRE RATING OF ALL WALLS AND FLOORS. PROVIDE FIRE PROOFING FOR ALL WALL AND FLOOR PENETRATIONS PER CODE.
- COORDINATE WORK WITH OTHER TRADES.
- CIRCUIT NUMBERS ARE USED FOR DESIGN INTENT TO EXISTING PANELBOARDS. ELECTRICAL CONTRACTOR SHALL VERIFY EXACT CIRCUIT NUMBERS IN THE FIELD.
- LOCATIONS OF INDICATED LIGHTING CONTROL SENSORS ARE DIAGNOSTIC AND ONLY INTENDED TO INDICATE WHICH ROOMS AND SPACES AS REQUIRED FOR COMPLETE COVERAGE OF RESPECTIVE ROOM OR AREA BASED ON MANUFACTURER'S RECOMMENDATIONS FOR INSTALLED DEVICES.
- ALL WALL DEVICES TO BE RECESSED INTO WALL UNLESS OTHERWISE NOTED.

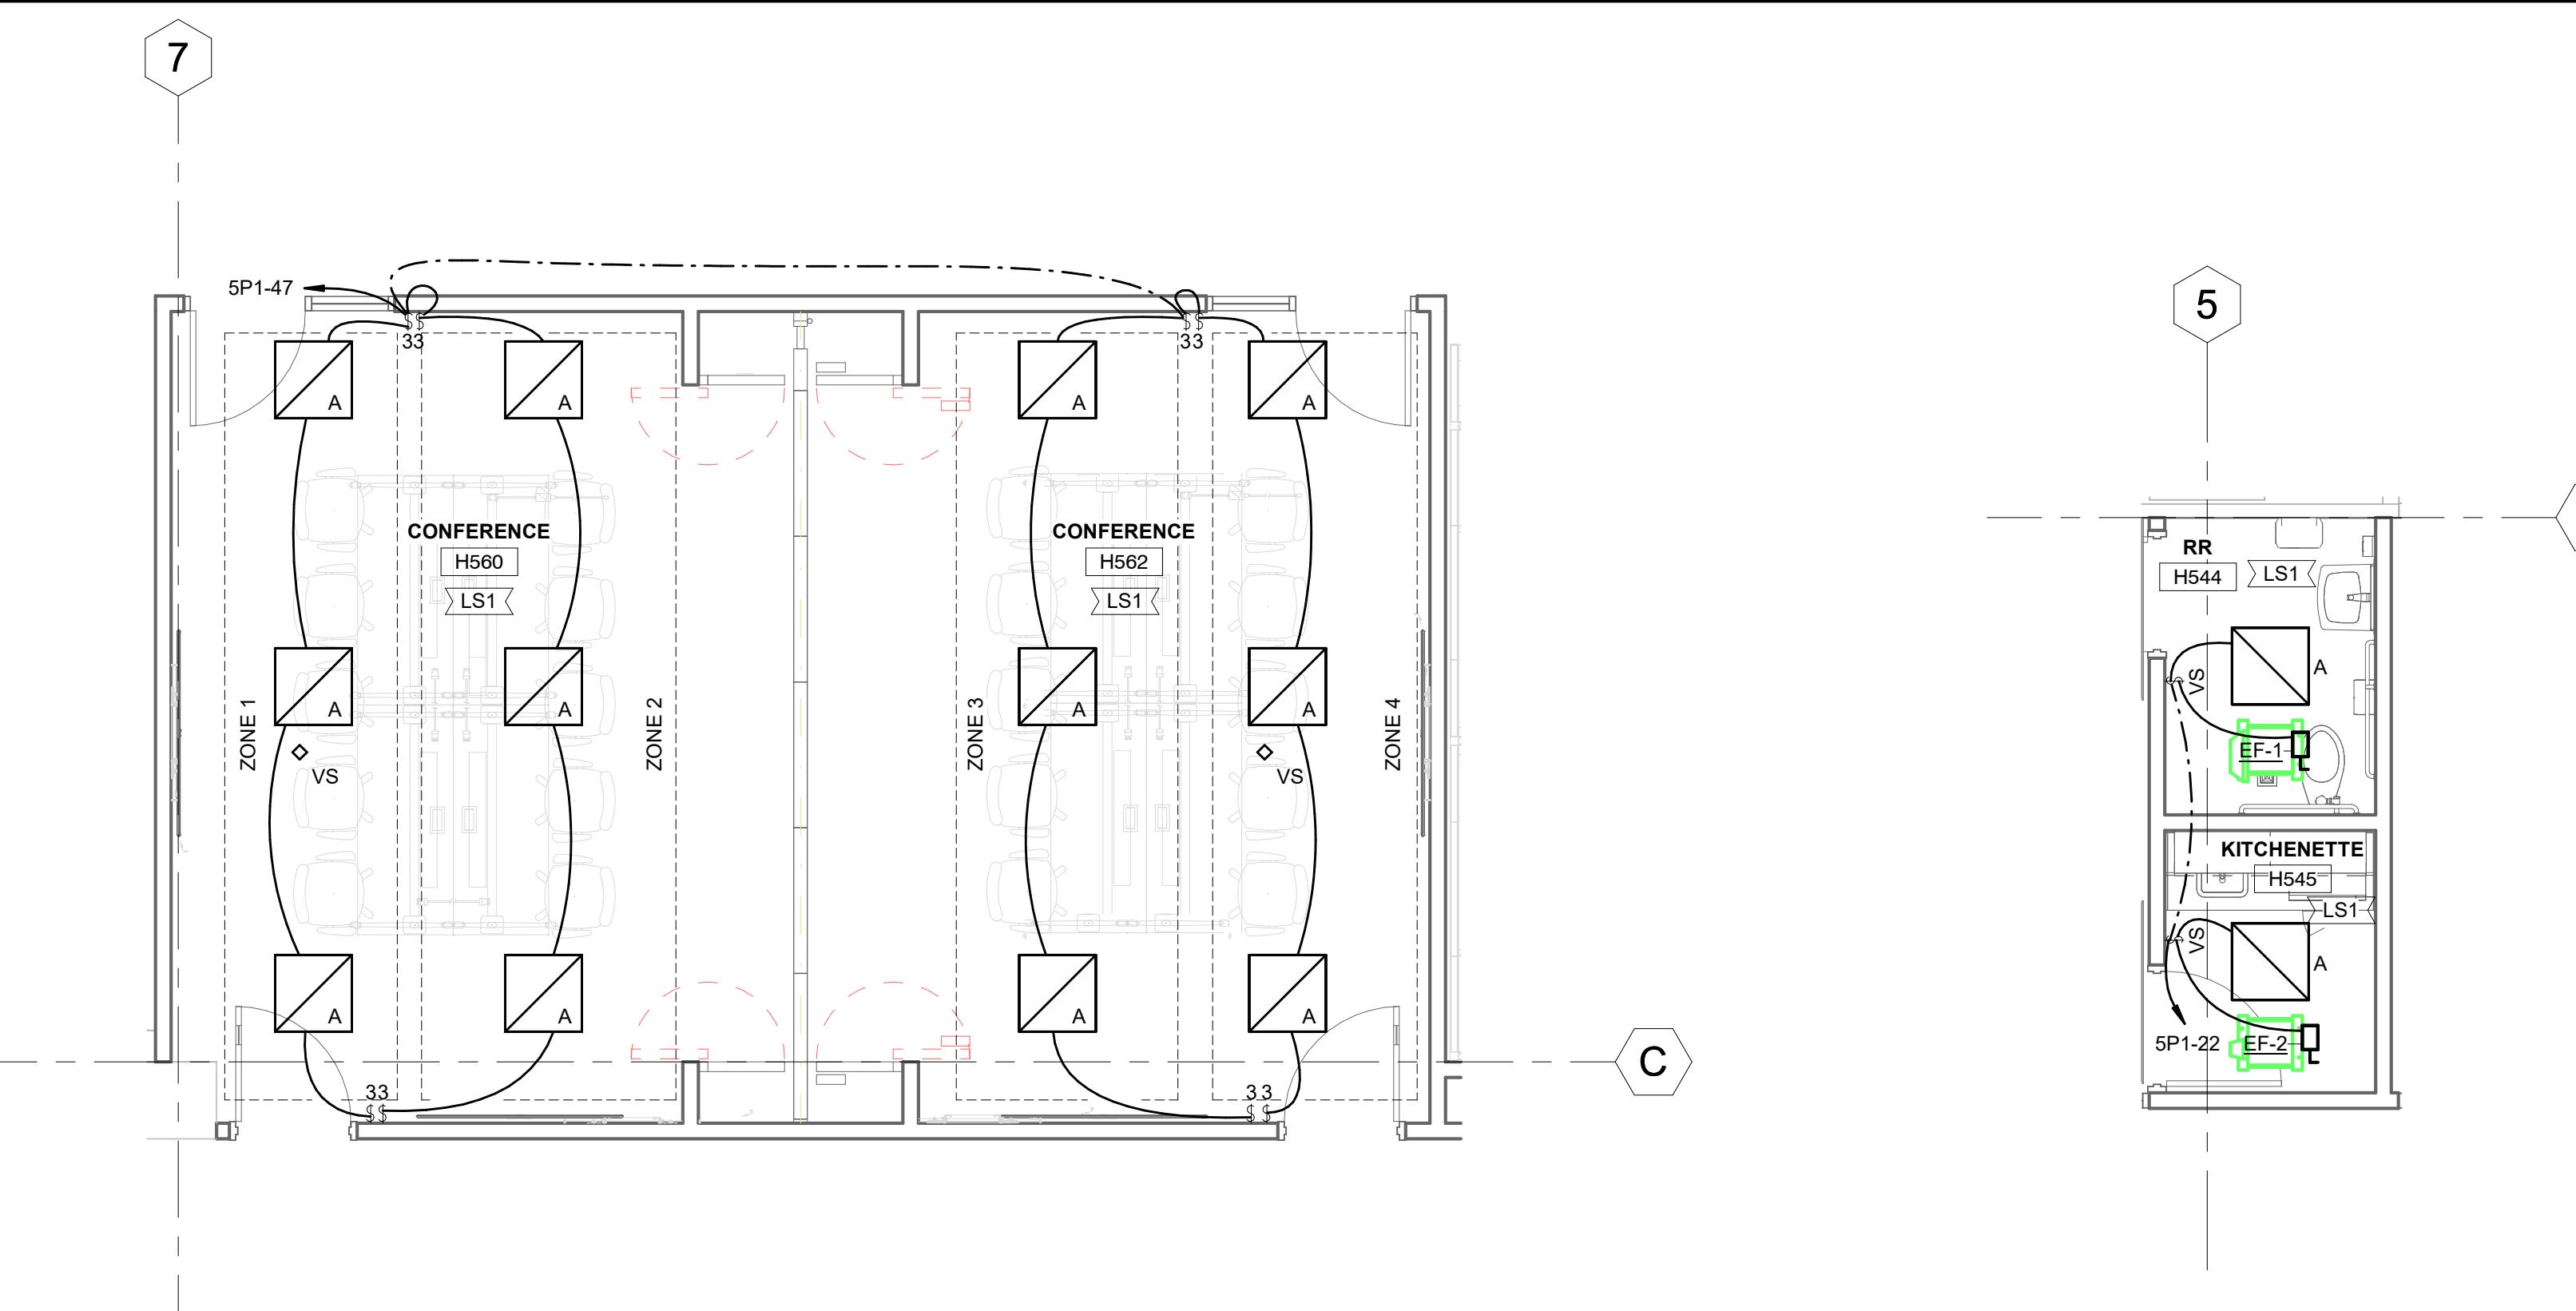

3 CONFERENCE ROOMS H560 AND H562 LIGHTING ENLARGED VIEW  
1/4" = 1'-0"

2 RR H544 AND KITCHENETTE H545 LIGHTING ENLARGED VIEW  
1/4" = 1'-0"

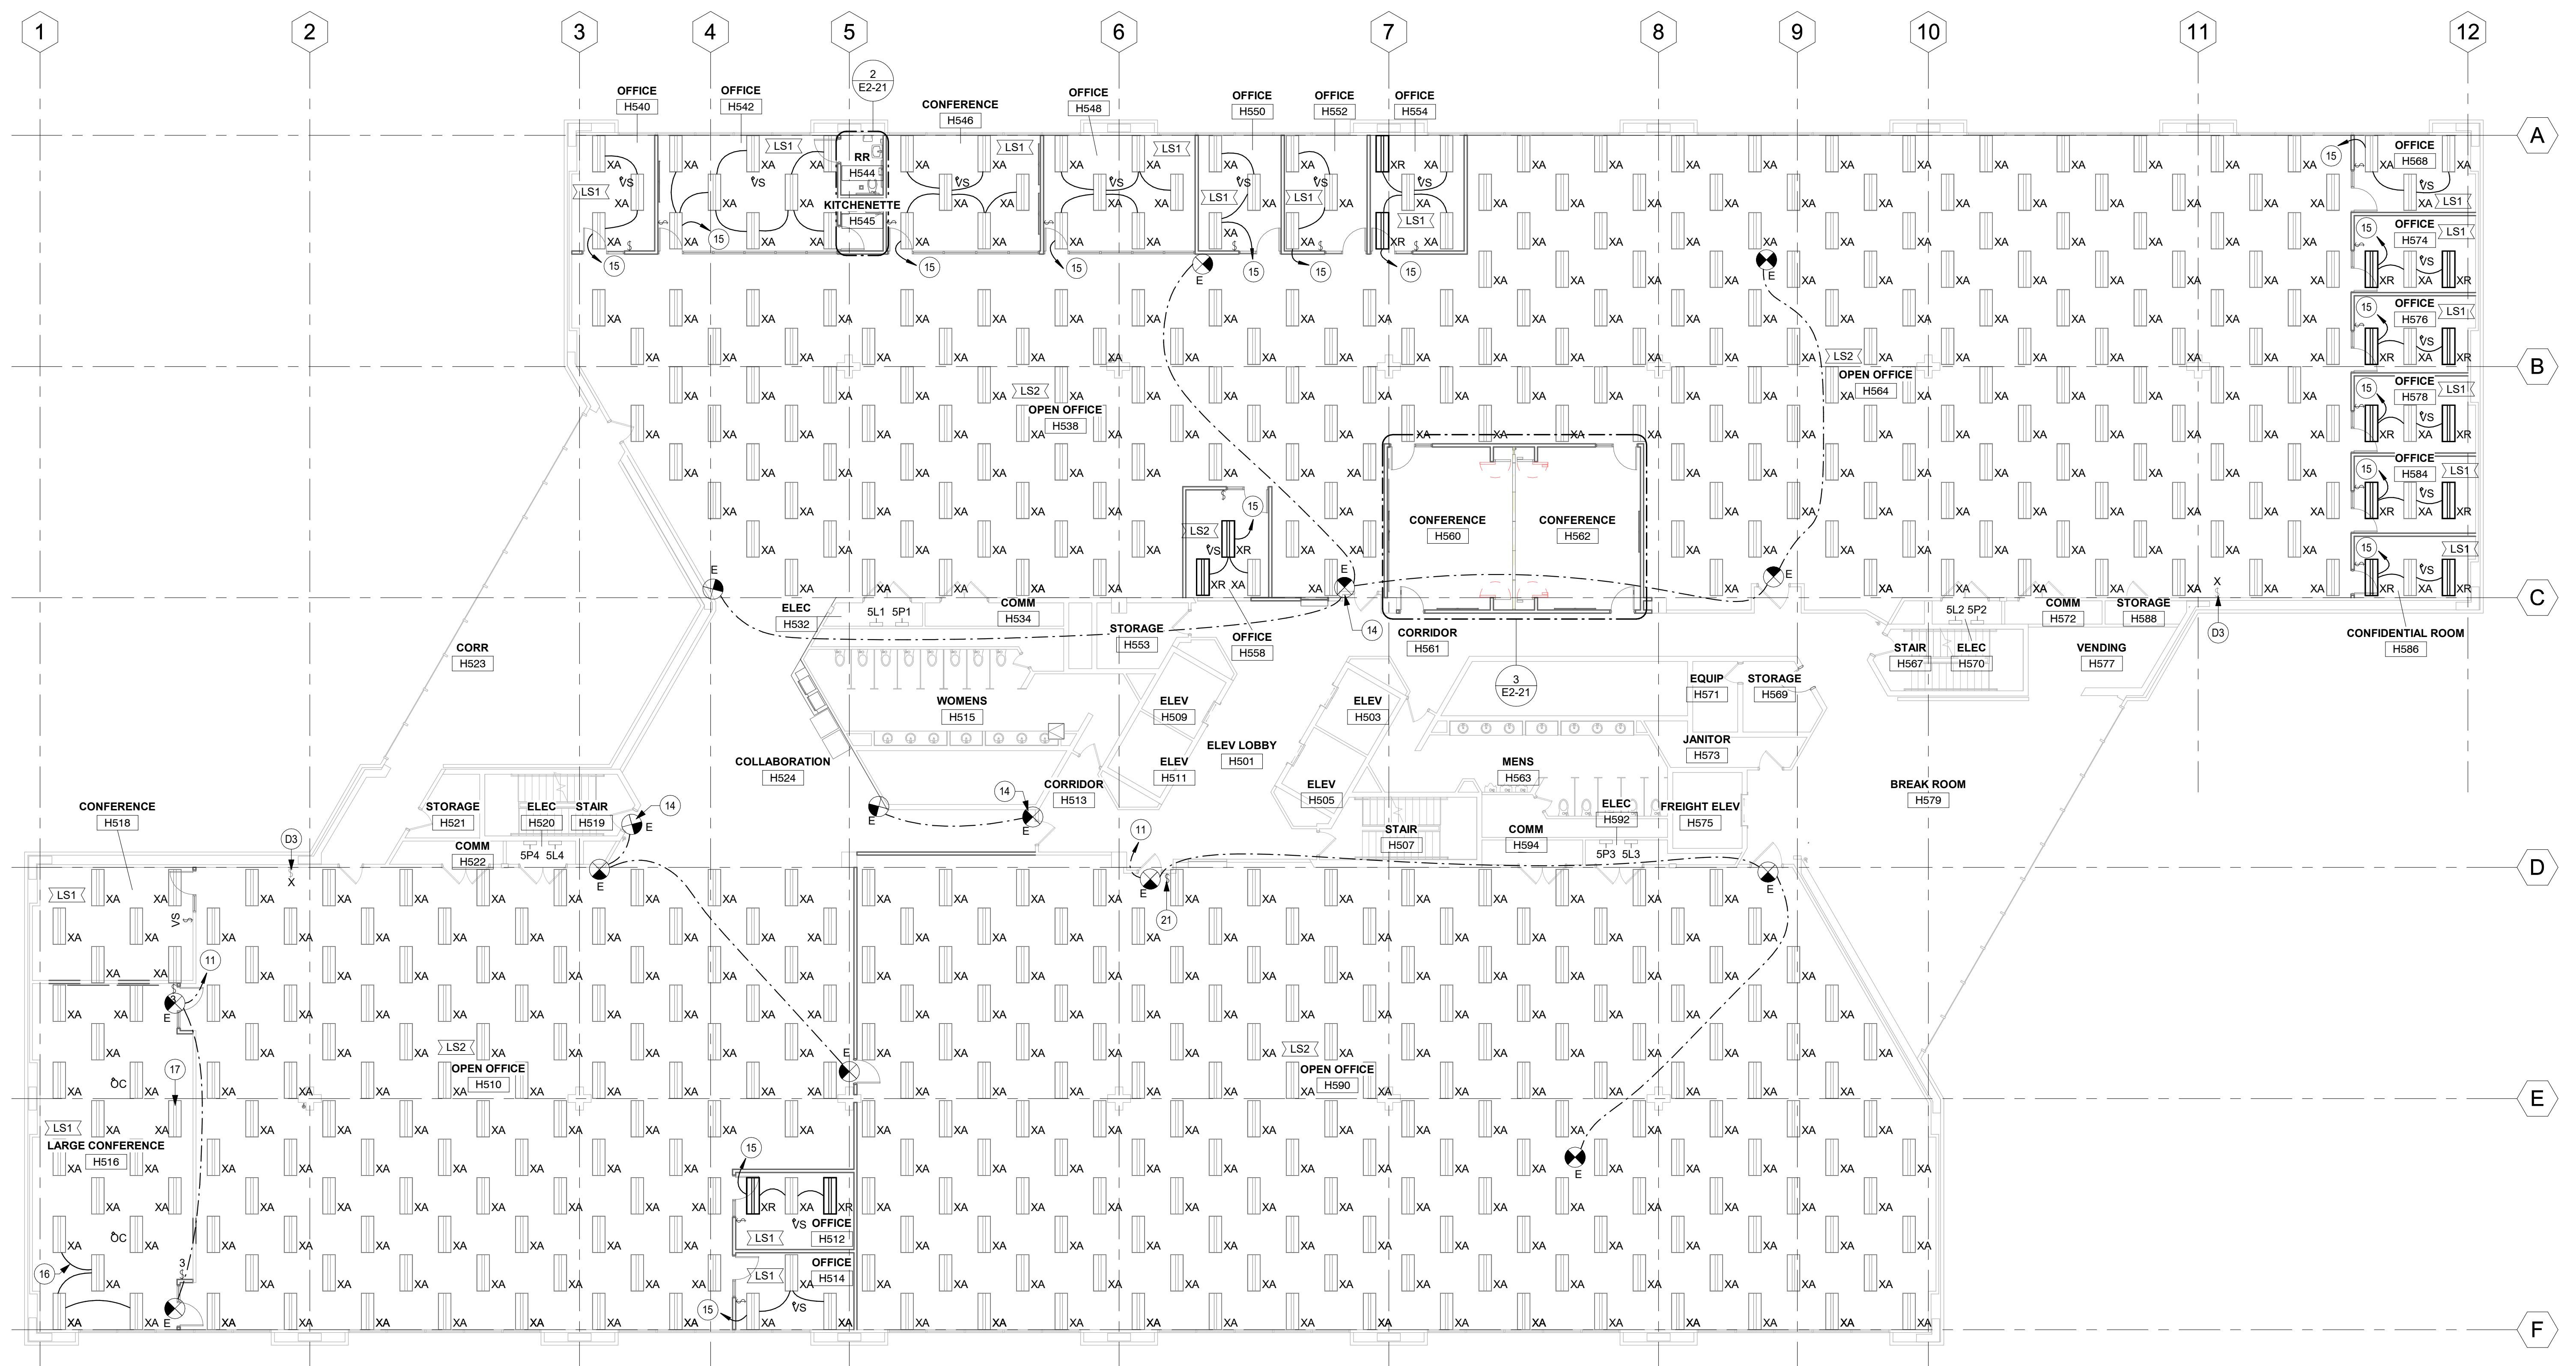




## SHEET NOTES

1. PROVIDE ALL ROUGH-IN FOR AND PATHWAYS FOR ACCESSED TRACING, HANGING AND PROGRAMMING SHALL BE OWNER COORDINATE ALL LOCATIONS WITH PRIOR TO ROUGH-IN.
2. CONDUITS FOR DATA ROUGH-INS SHALL BE FLUSH MOUNTED IN ALL SPACES UNLESS SPECIFICALLY NOTED TO BE SURFACE MOUNTED.
3. COORDINATE WORK WITH ALL APPLICABLE TRADES.
4. PROVIDE QUANTITIES AS REQUIRED BASED ON ROUGH-IN LOCATION COUNTS.
5. MAINTAIN FIRE RATING OF ALL WALLS AND FLOORS. PROVIDE FIRE PROOFING FOR ALL WALL AND FLOOR PENETRATIONS PER CODE.
6. COORDINATE DEVICE LOCATIONS WITH FURNITURE SUPPLIER AND OWNER PRIOR TO ROUGH-IN FOR FINAL LOCATIONS. IF CHANGE IN DIMENSIONS SHOWN IN PLANS IS REQUIRED, COORDINATE WITH OWNER PRIOR TO ROUGH-IN.

## TECH KEYNOTE LEGEND

- 3 APPROXIMATE LOCATION OF EXISTING ACCESS CONTROL HEAD END. SHOWN FOR REFERENCE AND COORDINATION.
- 4 APPROXIMATE LOCATION OF OWNER PROVIDED DOGHOUSE. CONTRACTOR TO CUT OPENING IN RAISED FLOOR FOR ACCESS TO SUB FLOOR LOCATION TO SUPPORT (1) OWNER FURNISHED AND INSTALLED DATA CABLES.
- 5 APPROXIMATE LOCATION OF OWNER PROVIDED DOGHOUSE. CONTRACTOR TO CUT OPENING IN RAISED FLOOR FOR ACCESS TO SUB FLOOR LOCATION TO SUPPORT (3) OWNER FURNISHED AND INSTALLED DATA CABLES.
- 6 APPROXIMATE LOCATION OF OWNER PROVIDED DOGHOUSE. CONTRACTOR TO CUT OPENING IN RAISED FLOOR FOR ACCESS TO SUB FLOOR LOCATION TO SUPPORT (6) OWNER FURNISHED AND INSTALLED DATA CABLES.
- 7 APPROXIMATE LOCATION OF OWNER PROVIDED DOGHOUSE. CONTRACTOR TO CUT OPENING IN RAISED FLOOR FOR ACCESS TO SUB FLOOR LOCATION TO SUPPORT (7) OWNER FURNISHED AND INSTALLED DATA CABLES.
- 8 APPROXIMATE LOCATION OF OWNER PROVIDED DOGHOUSE. CONTRACTOR TO CUT OPENING IN RAISED FLOOR FOR ACCESS TO SUB FLOOR LOCATION TO SUPPORT (8) OWNER FURNISHED AND INSTALLED DATA CABLES.
- 9 APPROXIMATE LOCATION OF OWNER PROVIDED DOGHOUSE. CONTRACTOR TO CUT OPENING IN RAISED FLOOR FOR ACCESS TO SUB FLOOR LOCATION TO SUPPORT (9) OWNER FURNISHED AND INSTALLED DATA CABLES.
- 10 APPROXIMATE LOCATION OF OWNER PROVIDED DOGHOUSE. CONTRACTOR TO CUT OPENING IN RAISED FLOOR FOR ACCESS TO SUB FLOOR LOCATION TO SUPPORT (10) OWNER FURNISHED AND INSTALLED DATA CABLES.
- 11 APPROXIMATE LOCATION OF OWNER PROVIDED DOGHOUSE. CONTRACTOR TO CUT OPENING IN RAISED FLOOR FOR ACCESS TO SUB FLOOR LOCATION TO SUPPORT (10) OWNER FURNISHED AND INSTALLED DATA CABLES.
- 12 APPROXIMATE LOCATION OF OWNER PROVIDED DOGHOUSE. CONTRACTOR TO CUT OPENING IN RAISED FLOOR FOR ACCESS TO SUB FLOOR LOCATION TO SUPPORT (11) OWNER FURNISHED AND INSTALLED DATA CABLES.
- 13 APPROXIMATE LOCATION OF OWNER PROVIDED DOGHOUSE. CONTRACTOR TO CUT OPENING IN RAISED FLOOR FOR ACCESS TO SUB FLOOR LOCATION TO SUPPORT (1) OWNER FURNISHED AND INSTALLED DATA CABLE AND FAX CABLE.
- 14 APPROXIMATE LOCATION OF OWNER PROVIDED DOGHOUSE. CONTRACTOR TO CUT OPENING IN RAISED FLOOR FOR ACCESS TO SUB FLOOR LOCATION TO SUPPORT (2) OWNER FURNISHED AND INSTALLED DATA CABLES.
- 20 PROVIDE SINGLE-GANG J-BOX WITH (1) 3/4" CONDUIT TO ACCESSIBLE CEILING OUTLET FOR OWNER PROVIDED DATA CABLING. TYPICAL UNLESS NOTED OTHERWISE.

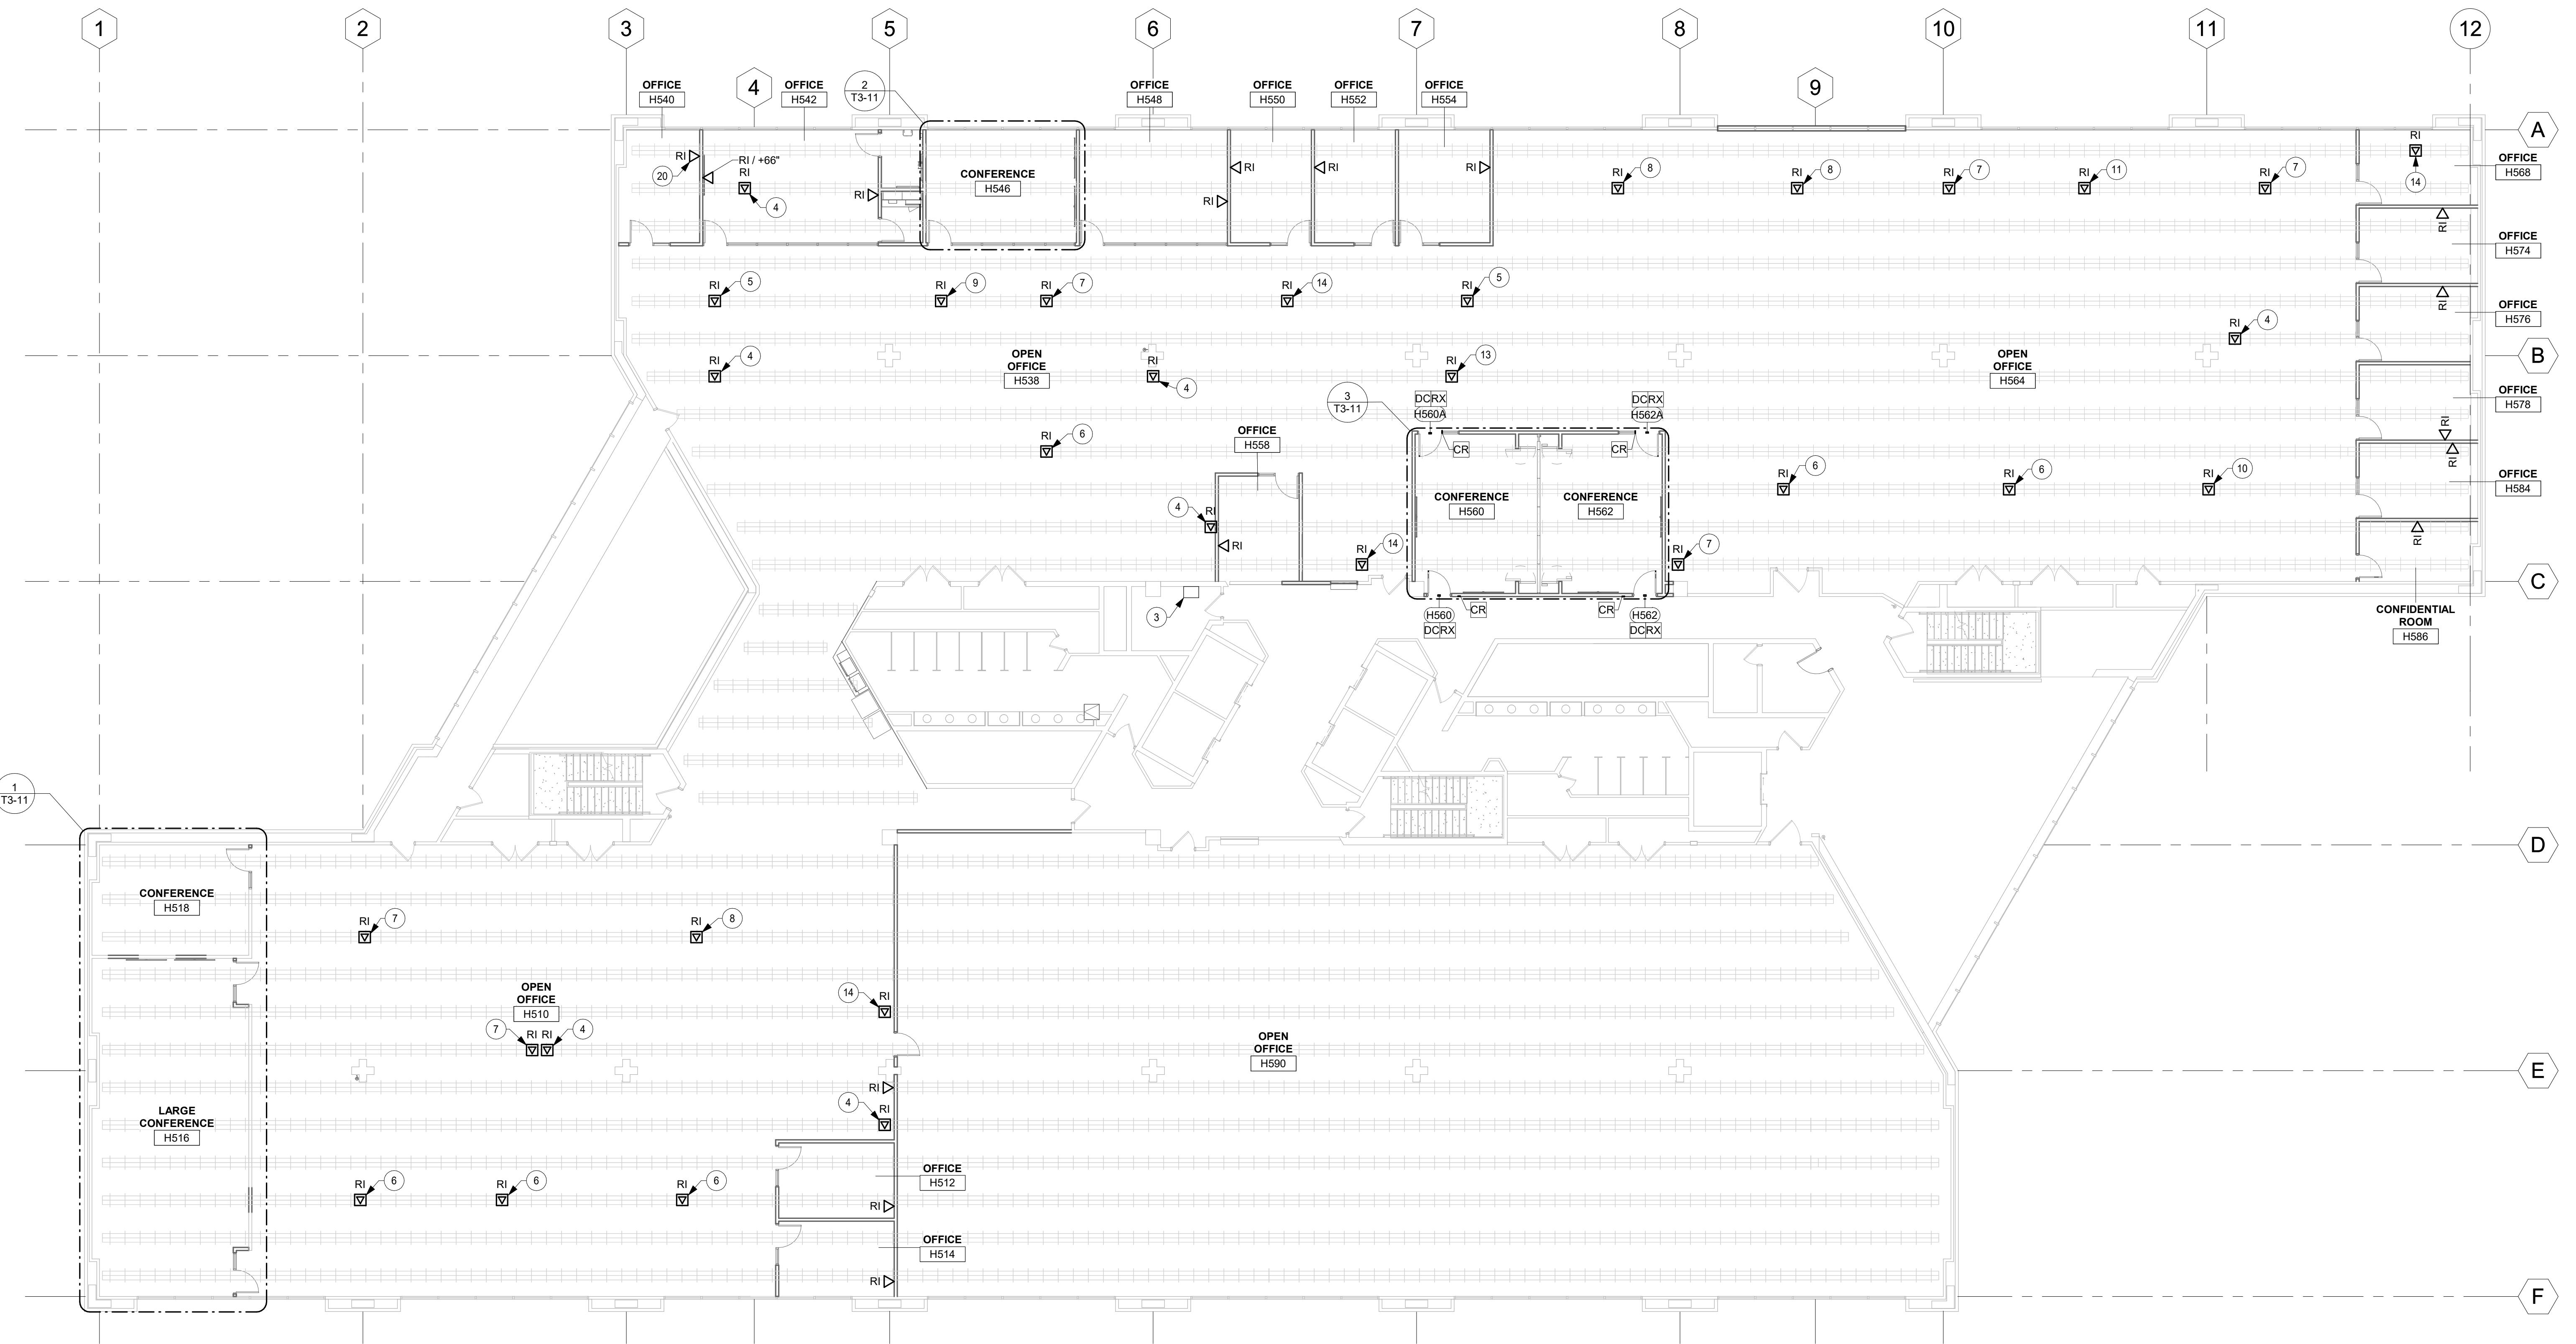

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PROJECT

## DACS CC IDALS HOOVER 5TH FLOOR RENOVATION

DES MOINES IOWA

REVISION SCHEDULE	DATE	DESCRIPTION	BY

PROJECT NO. 24-31954  
FILE NAME 31954 Tech R24  
DRAWN BY BLF  
DESIGNED BY BLF  
REVIEWED BY AAG  
ORIGINAL ISSUE DATE 01/21/25  
CLIENT PROJECT NO.

TITLE

## LEVEL 5 TECHNOLOGY PLAN


N  
T2-11  
SHEET

## SHEET NOTES

1. SOUND MASKING SYSTEM SHALL SERVE AS A BID ALTERNATE #1.
2. SOUND MASKING CONTRACTOR SHALL PROVIDE AND INSTALL ALL SOUND MASKING DEVICES, ACCESSORIES AND CABLING.
3. PROVIDE QUANTITIES AS REQUIRED BASED ON DEVICE COUNTS. REFER TO FLOOR PLANS AND SPECIFICATIONS FOR ADDITIONAL INFORMATION.
4. SOUND MASKING LAYOUT IS SHOWN FOR GENERAL DESIGN INTENT. CONTRACTOR SHALL PROVIDE MANUFACTURER RECOMMENDED LAYOUTS BASED ON SPECIFIC MODELS SELECTED.
5. MAINTAIN FIRE RATING OF ALL WALLS AND FLOORS. PROVIDE FIRE PROOFING FOR ALL WALL AND FLOOR PENETRATIONS PER CODE.




## TECH KEYNOTE LEGEND

1. SOUND MASKING Emitter (AV-SME-01) TO BE INSTALLED IN METAL CEILING GRID. PROVIDE ALL NECESSARY ACCESSORIES FOR INSTALLATION WITH-IN METAL CEILING GRID. (TYPICAL)
22. APPROXIMATE LOCATION OF EXISTING OWNER COMMUNICATION CLOSET RACK FOR MOUNTING SOUND MASKING CONTROLLER AND EQUIPMENT.

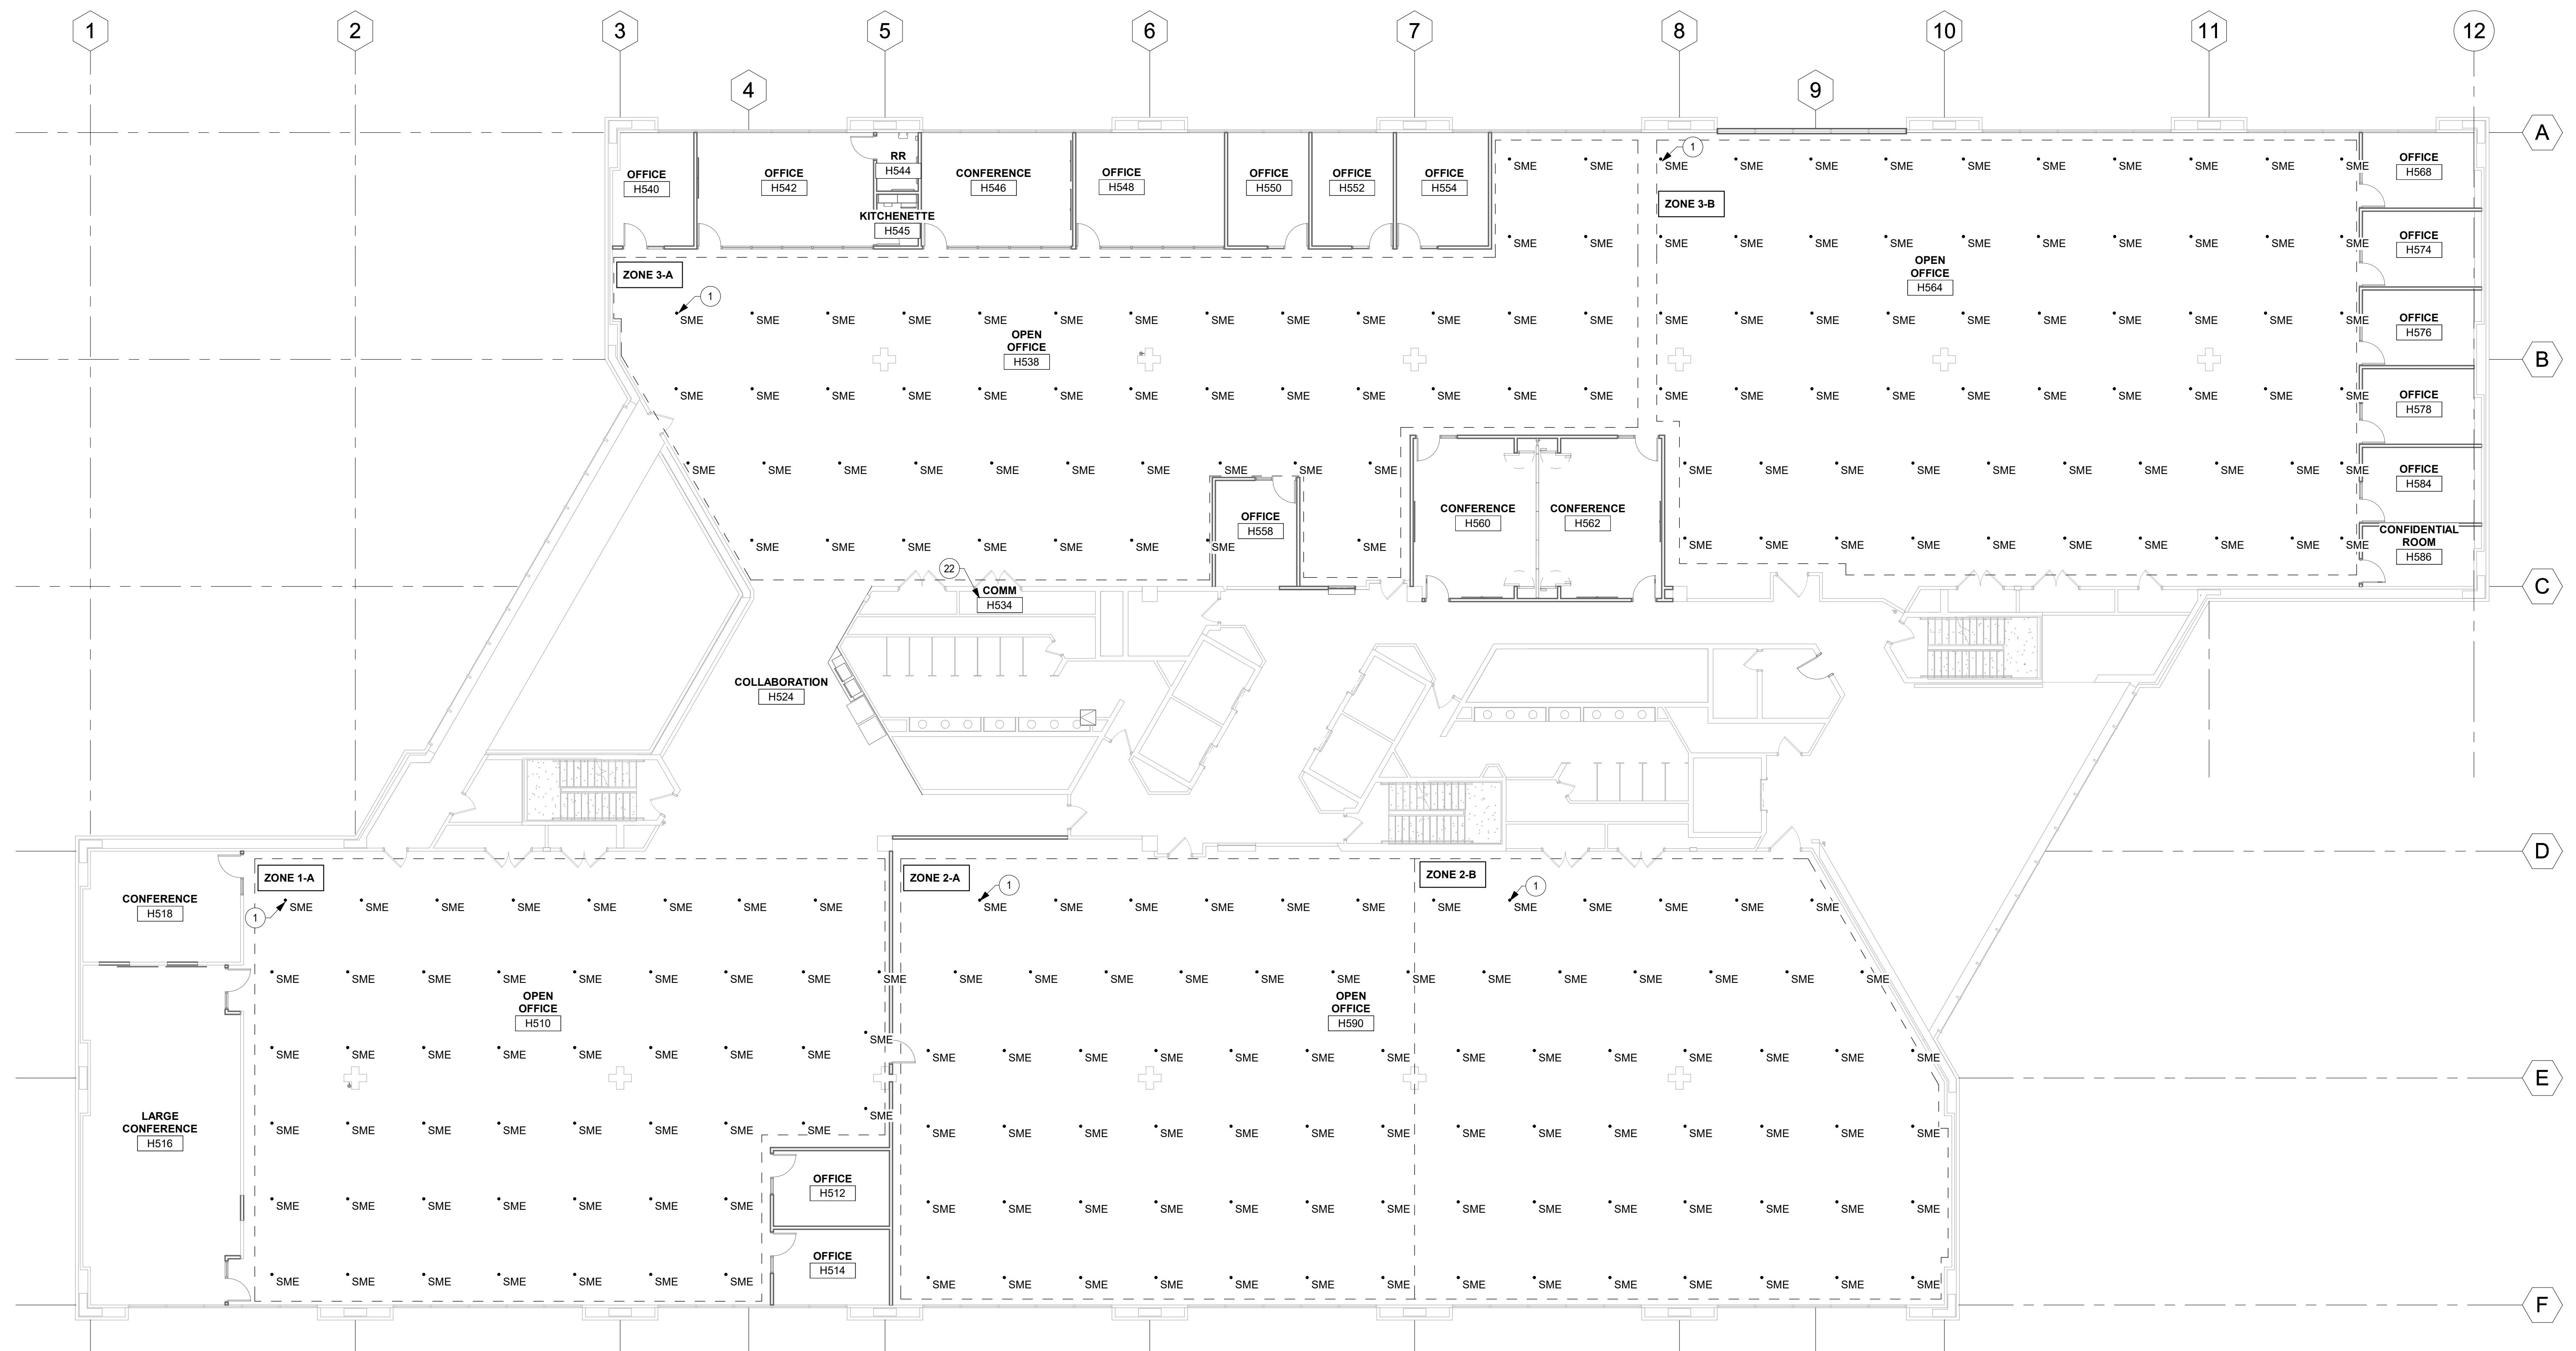

SHEET NOTES	
<ol style="list-style-type: none"> <li>1. PROVIDE ALL ROUGH-IN FOR AND PATHWAYS FOR ACCESS CONTROL, CABLING, HARDWARE AND PROGRAMMING SHALL BE BY OWNER. COORDINATE ALL LOCATIONS WITH PRIOR TO ROUGH-IN.</li> <li>2. CONDUITS FOR DATA ROUGH-INS SHALL BE FLUSH MOUNTED IN ALL SPACES UNLESS SPECIFICALLY NOTED TO BE SURFACE MOUNTED.</li> <li>3. COORDINATE WORK WITH ALL APPLICABLE TRADES.</li> <li>4. PROVIDE QUANTITIES AS REQUIRED BASED ON ROUGH-IN LOCATION COUNTS.</li> <li>5. MAINTAIN FIRE RATING OF ALL WALLS AND FLOORS. PROVIDE FIRE PROOFING FOR ALL WALL AND FLOOR PENETRATIONS PER CODE.</li> <li>6. COORDINATE DEVICE LOCATIONS WITH FURNITURE SUPPLIER AND OWNER PRIOR TO ROUGH-IN FOR FINAL DIMENSIONS. IF CHANGE IN DIMENSIONS SHOWN IN PLANS IS REQUIRED, COORDINATE WITH OWNER PRIOR TO ROUGH-IN.</li> <li>15. PROVIDE (1) SINGLE-GANG J-BOX WITH (1) 3/4" CONDUIT TO OWNER FURNISHED DISPLAY ABOVE FOR OWNER FURNISHED AND INSTALLED PTZ CAMERA. COORDINATE FINAL HEIGHT WITH OWNER PRIOR TO ROUGH-IN.</li> <li>16. PROVIDE (1) SINGLE-GANG J-BOX WITH (1) 1" CONDUIT TO ACCESSIBLE CEILING ABOVE FOR OWNER FURNISHED AND OWNER INSTALLED DISPLAY.</li> <li>17. PROVIDE (1) SINGLE-GANG J-BOX WITH 1/2" CONDUIT TO TV J-BOX ABOVE. COORDINATE FINAL HEIGHT AND DIMENSIONS FOR ACCESSIBLE CEILING ROUGH-IN.</li> <li>19. PROVIDE (1) SINGLE-GANG J-BOX WITH (1) 3/4" CONDUIT TO ACCESSIBLE CEILING ABOVE FOR OWNER FURNISHED AND INSTALLED PTZ CAMERA. COORDINATE FINAL HEIGHT WITH OWNER PRIOR TO ROUGH-IN.</li> <li>21. EXISTING OUTLET TO REMAIN.</li> </ol>	23. EXISTING OUTLET TO REMAIN.

TECH KEYNOTE LEGEND	
4	APPROXIMATE LOCATION OF OWNER PROVIDED DOGHOUSE. CONTRACTOR TO CUT OPENING IN RAISED FLOOR FOR ACCESS TO DOGHOUSE. CONTRACTOR TO SUPPORT (1) OWNER FURNISHED AND INSTALLED DATA CABLE.
5	APPROXIMATE LOCATION OF OWNER PROVIDED DOGHOUSE. CONTRACTOR TO CUT OPENING IN RAISED FLOOR FOR ACCESS TO SUB FLOOR LOCATION TO SUPPORT (3) OWNER FURNISHED AND INSTALLED DATA CABLES.
15	PROVIDE (1) SINGLE-GANG J-BOX WITH (1) 3/4" CONDUIT TO OWNER FURNISHED DISPLAY ABOVE FOR OWNER FURNISHED AND INSTALLED PTZ CAMERA. COORDINATE FINAL HEIGHT WITH OWNER PRIOR TO ROUGH-IN.
16	PROVIDE (1) SINGLE-GANG J-BOX WITH (1) 1" CONDUIT TO ACCESSIBLE CEILING ABOVE FOR OWNER FURNISHED AND OWNER INSTALLED DISPLAY.
17	PROVIDE (1) SINGLE-GANG J-BOX WITH 1/2" CONDUIT TO TV J-BOX ABOVE. COORDINATE FINAL HEIGHT AND DIMENSIONS FOR ACCESSIBLE CEILING ROUGH-IN.
19	PROVIDE (1) SINGLE-GANG J-BOX WITH (1) 3/4" CONDUIT TO ACCESSIBLE CEILING ABOVE FOR OWNER FURNISHED AND INSTALLED PTZ CAMERA. COORDINATE FINAL HEIGHT WITH OWNER PRIOR TO ROUGH-IN.
21	EXISTING OUTLET TO REMAIN.

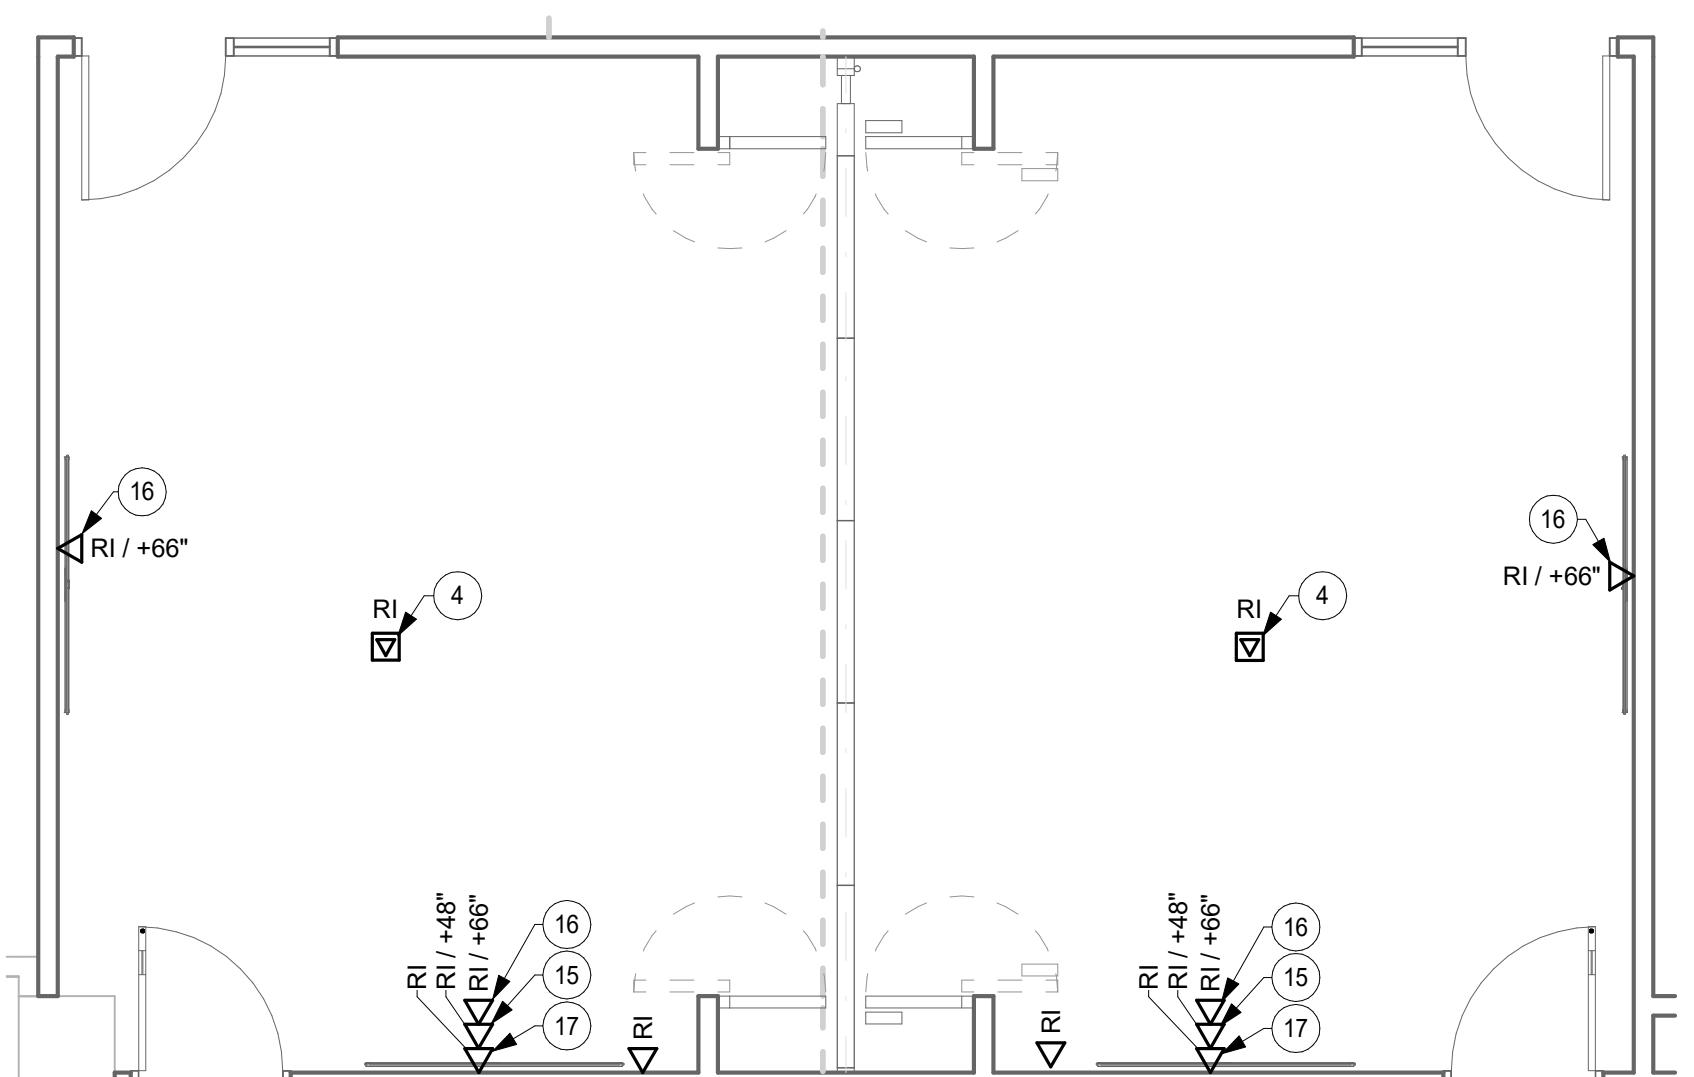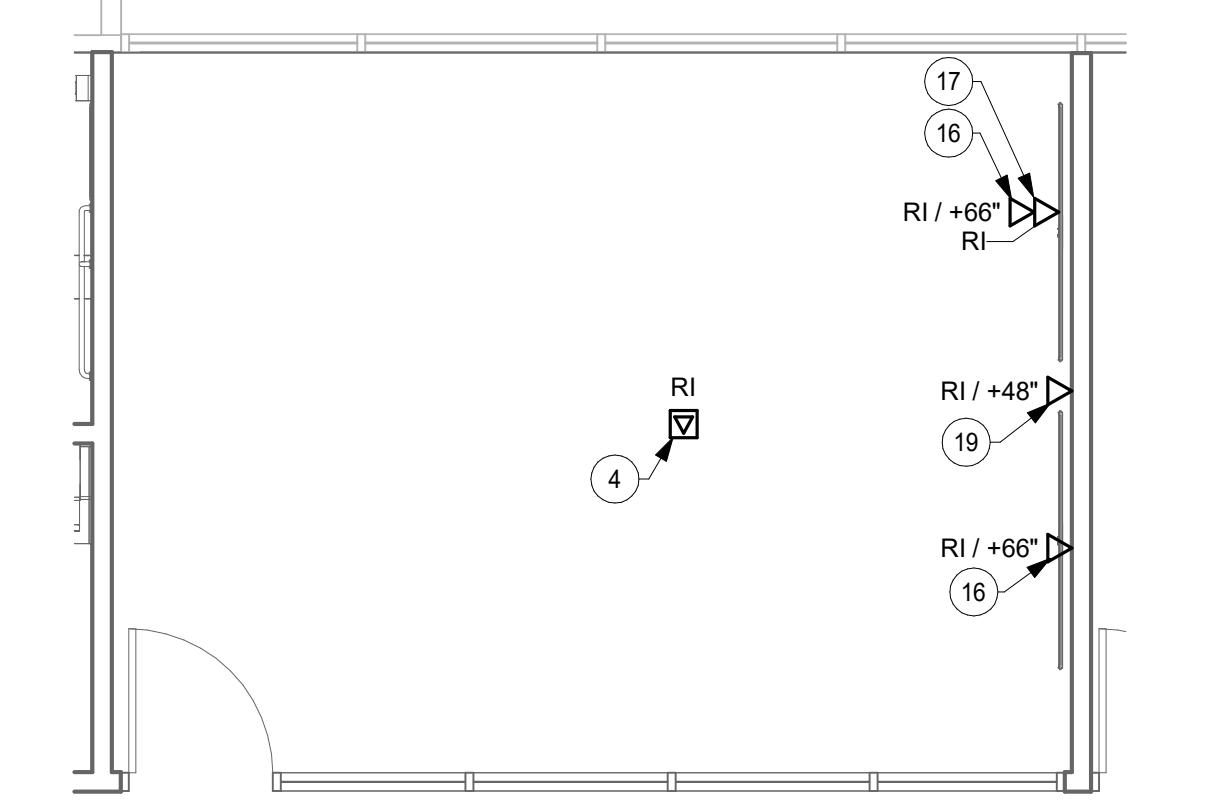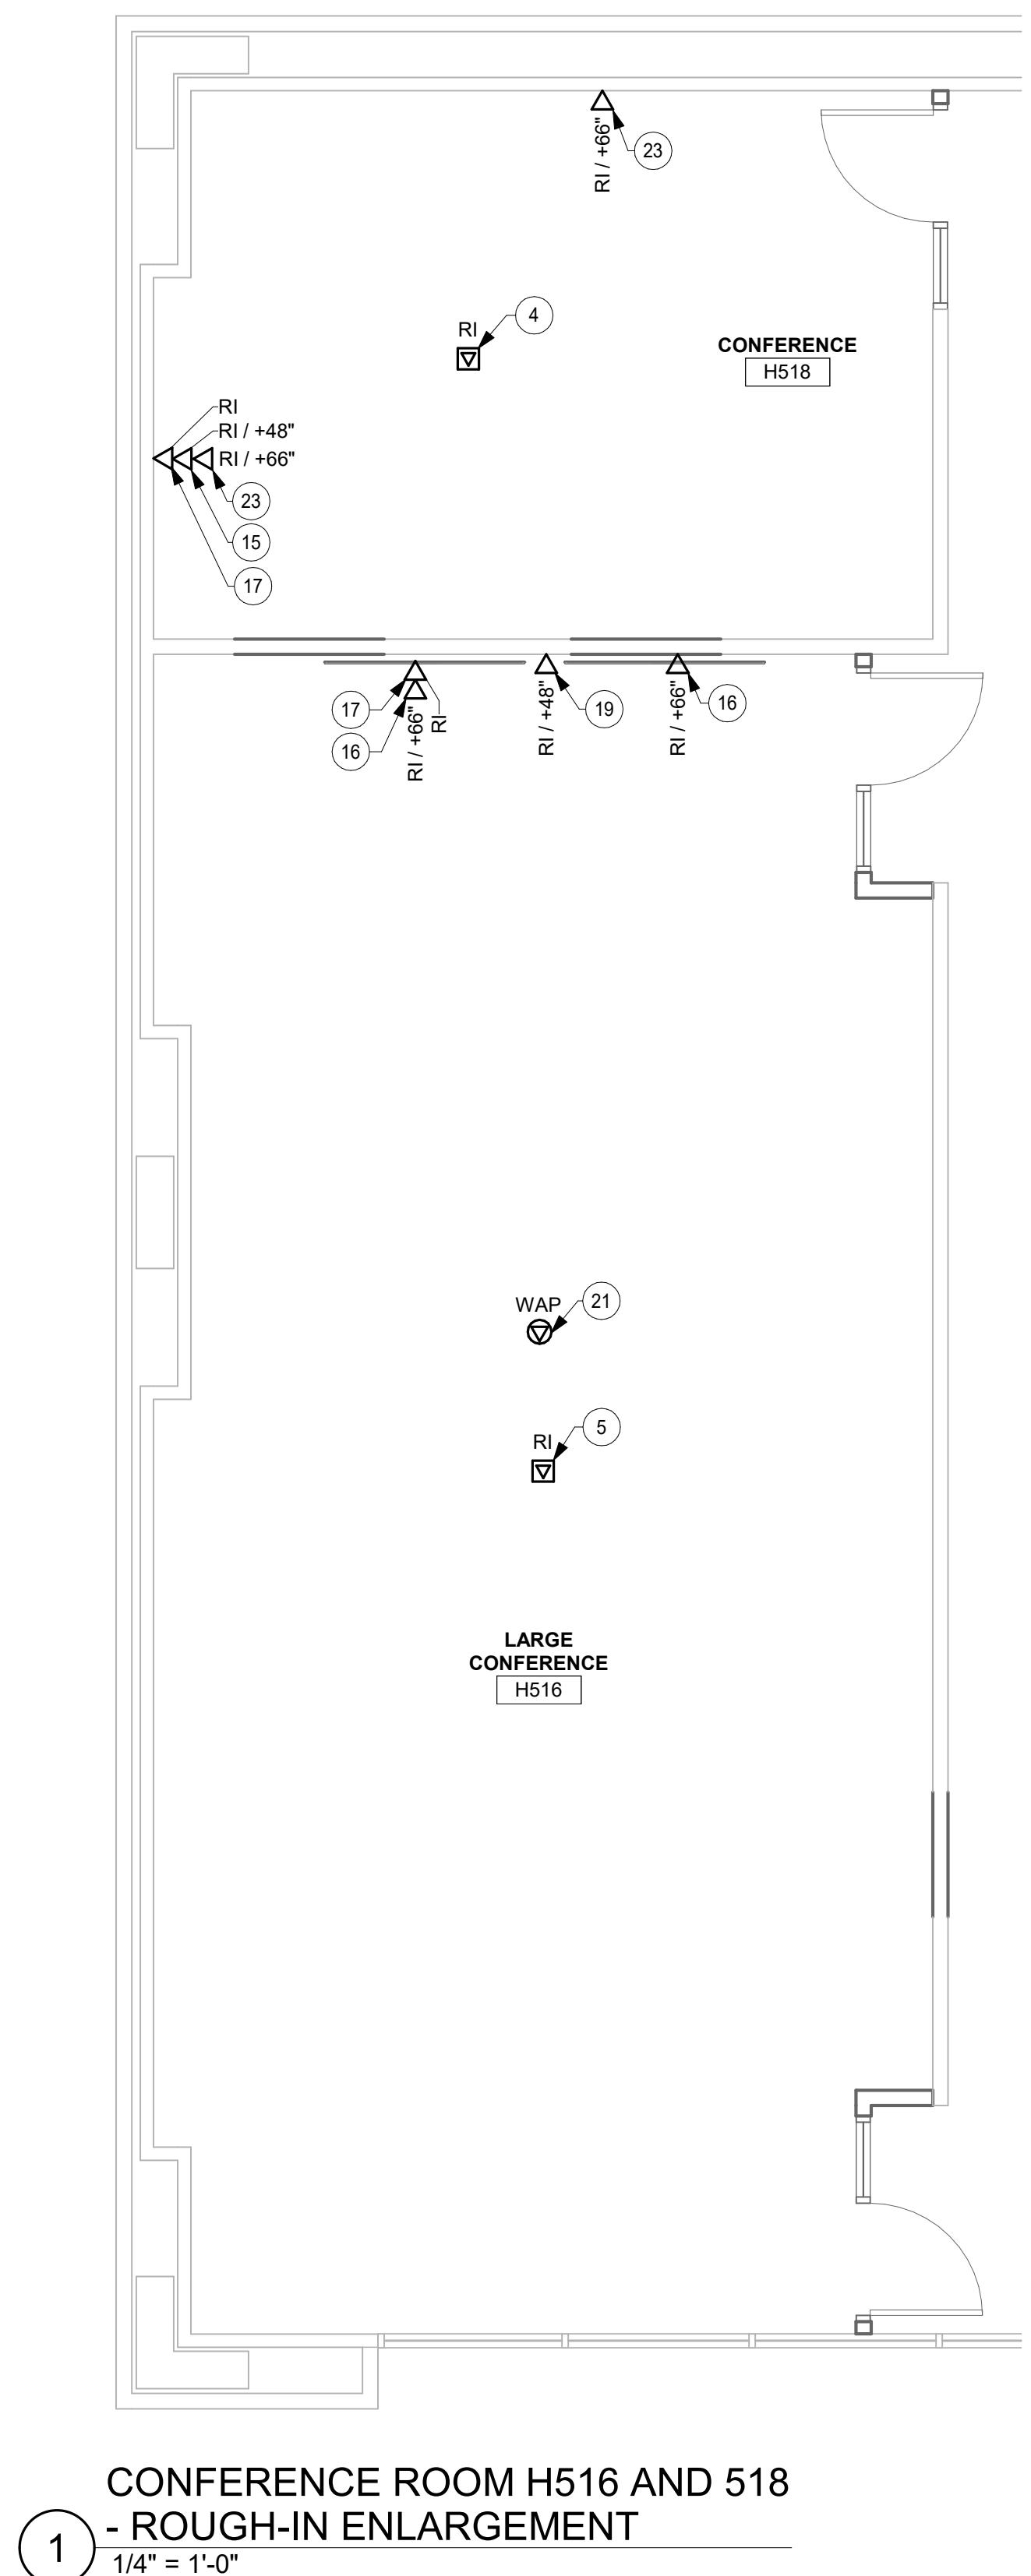

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PROJECT

## DACS CC IDALS HOOVER 5TH FLOOR RENOVATION


DES MOINES IOWA

REVISION SCHEDULE		
DATE	DESCRIPTION	BY

PROJECT NO. 24-31954  
FILE NAME 31954 Tech R24  
DRAWN BY BLF  
DESIGNED BY BLF  
REVIEWED BY AAG  
ORIGINAL ISSUE DATE 01/21/25  
CLIENT PROJECT NO.

TITLE

## TECHNOLOGY ENLARGEMENTS AND DETAILS

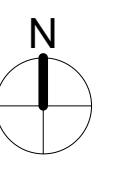


SHEET


T3-11

AUDIO VISUAL SCHEDULE		
DEVICE	DESCRIPTION	MODEL
AV-QT-01	SIX ZONE SOUND MASKING GENERATOR, CONTROLLER, BAND EQUALIZER AND AMPLIFIER. PROVIDE WITH RACK MOUNT KIT.	BIAMP/CAMBRIDGE QT X 600
AV-SME-01	PASSIVE SOUND MASKING EMITTERS. MODEL E-164. EIGHT ZONE SOUND MASKING EMITTERS. PROVIDE WITH NECESSARY ACCESSORIES FOR MOUNTING IN ACT CEILING.	BIAMP/CAMBRIDGE E-A-W-16-4

ACCESS CONTROL SCHEDULE		
DEVICE	DESCRIPTION	MODEL
AC-CR-01	CARD READER - ROUGH-IN ONLY.	OWNER FURNISHED
AC-DC-01	DOOR CONTACT - ROUGH-IN ONLY.	OWNER FURNISHED
AC-RX-01	REQUEST TO EXIT - ROUGH-IN ONLY.	OWNER FURNISHED

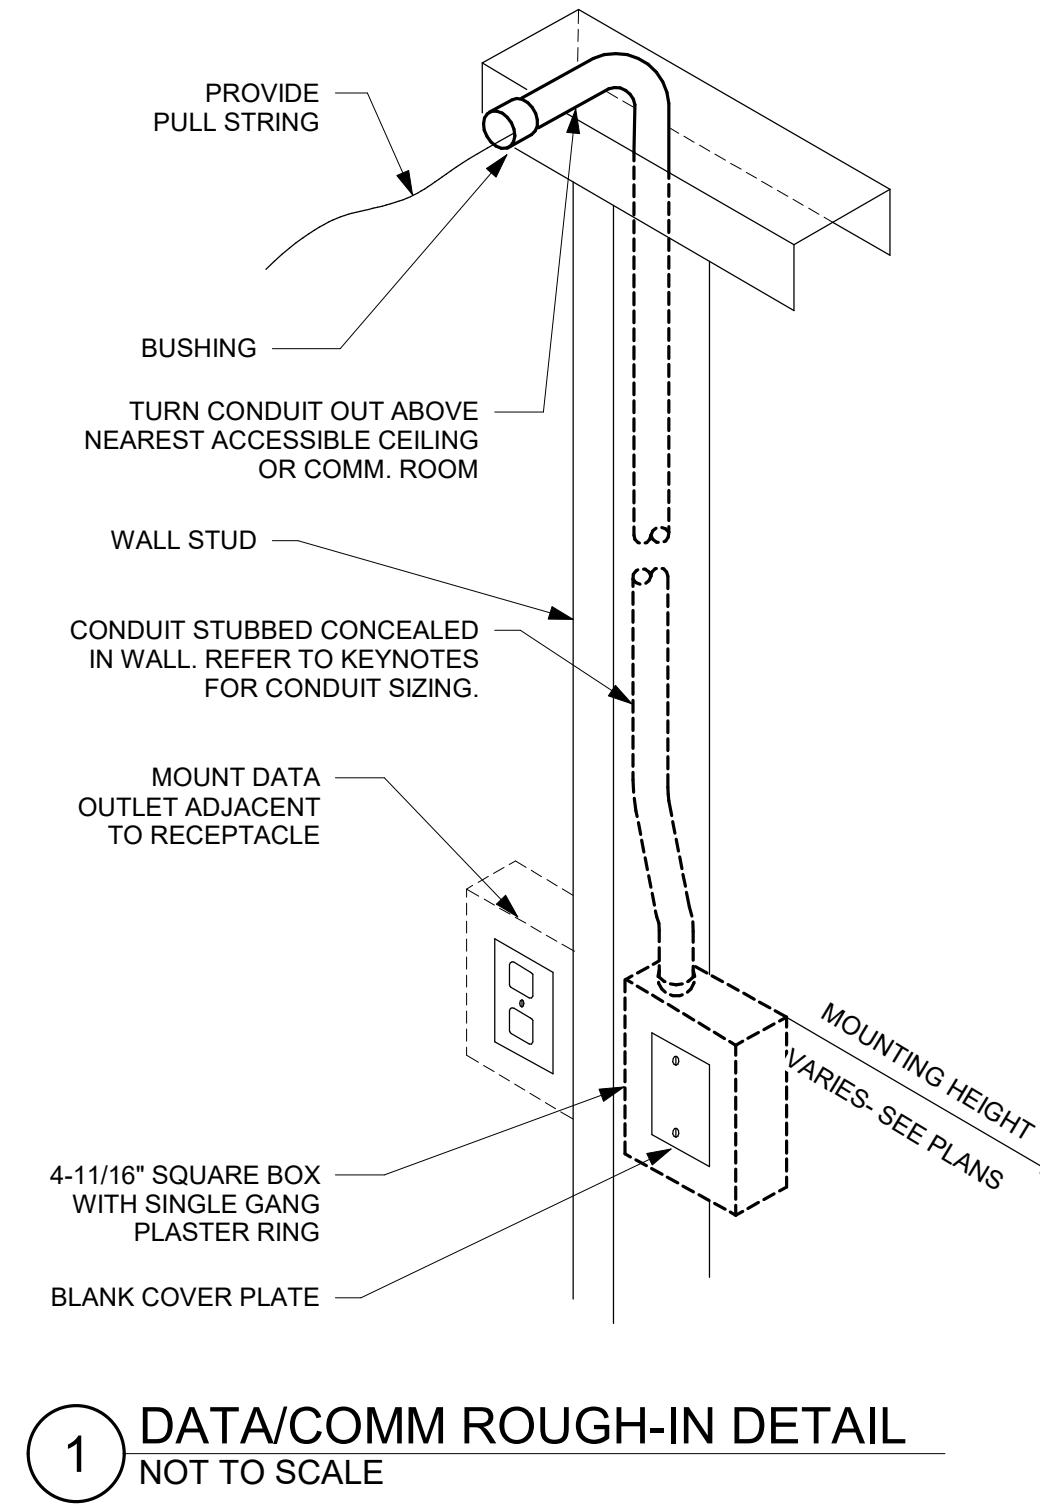


1 DATA/COMM ROUGH-IN DETAIL  
NOT TO SCALE

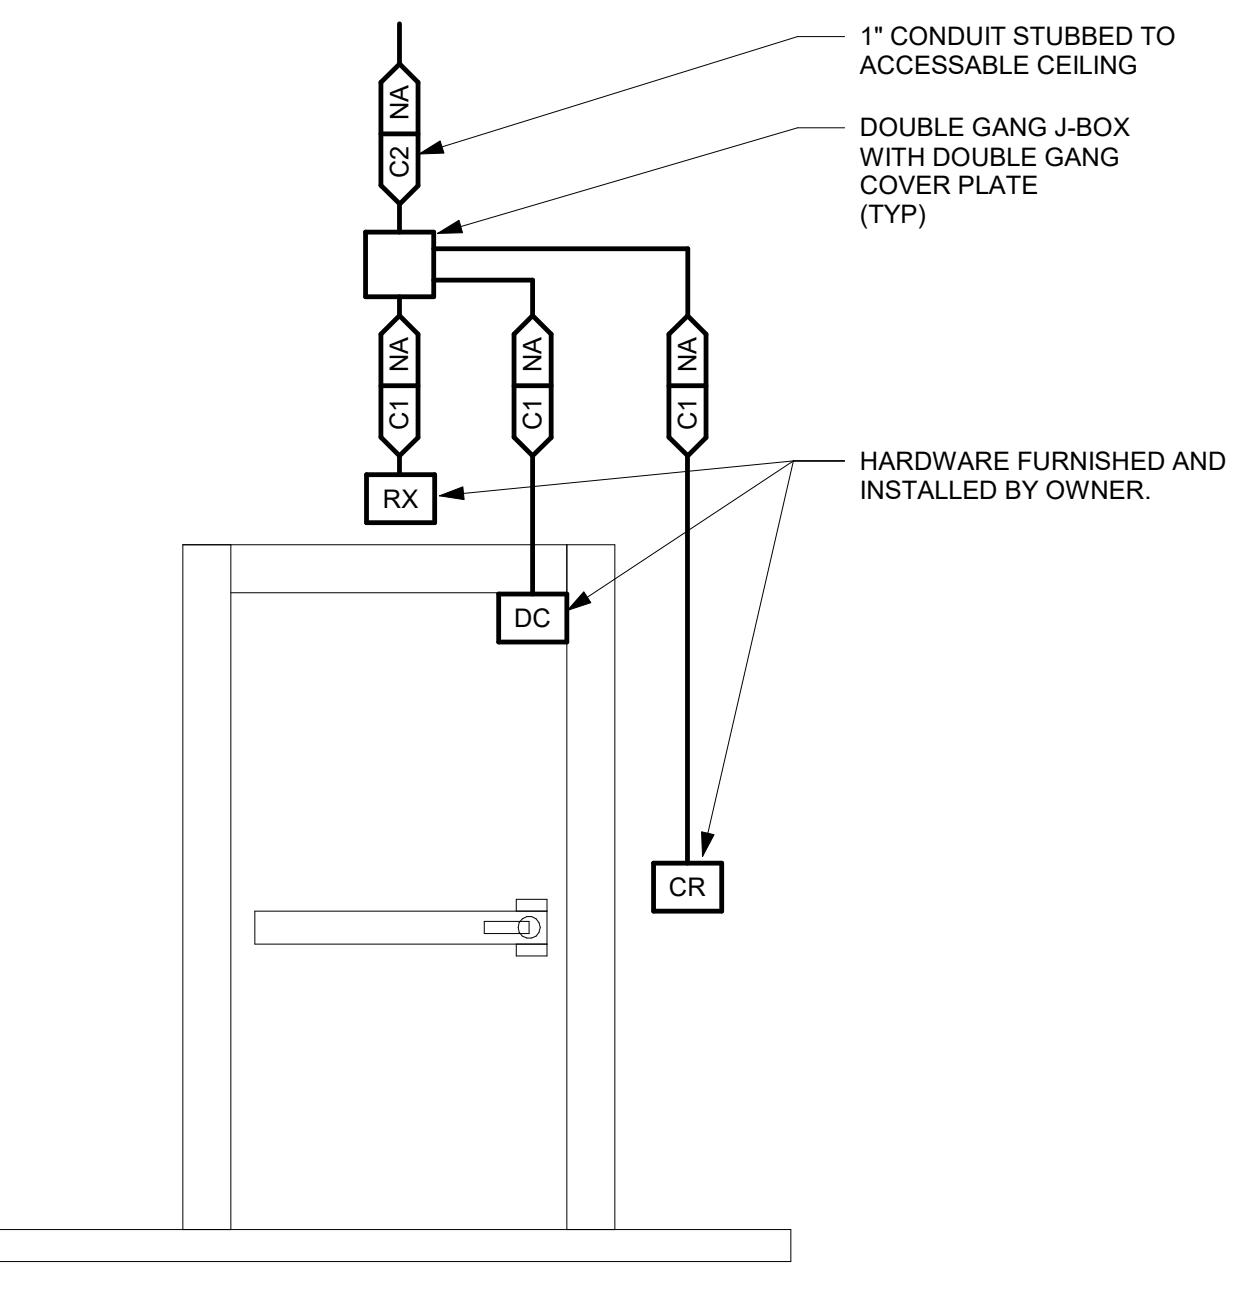

2 SINGLE DOOR - CARD READER - ROUGH-IN ONLY  
NOT TO SCALE

TECHNOLOGY SYMBOLS		
CR	AC-CR-01 / CARD READER ROUGH-IN	
DC	AC-DC-01 / DOOR CONTACT ROUGH-IN	
RX	AC-RX-01 / REQUEST TO EXIT ROUGH-IN	
□	AV-QT-01 / SOUND MASKING HEAD END	
● SME	AV-SME-01 / SOUND MASKING EMITTER	
▽	ROUGH-IN / WALL OUTLET	
▽	ROUGH-IN / FLOOR BOX	
▽	OWNER FURNISHED WIRELESS ACCESS POINT	

CONDUIT AND CABLING TYPES			
CONDUIT TYPE TAG	CABLE(S)	CABLING TYPE TAG	
C1	3/4" CONDUIT	01	4 - #22
C2	1" CONDUIT	02	2 - #18
C3	1-1/4" CONDUIT	03	6 - #22
C4	1-1/2" CONDUIT	04	CAT6
C5	2" CONDUIT	05	4 - #22, 2 - #18; 6 - #22, 2 - #22
C6	3" CONDUIT		
C7	4" CONDUIT		
EX	EXISTING	NA	NOT APPLICABLE

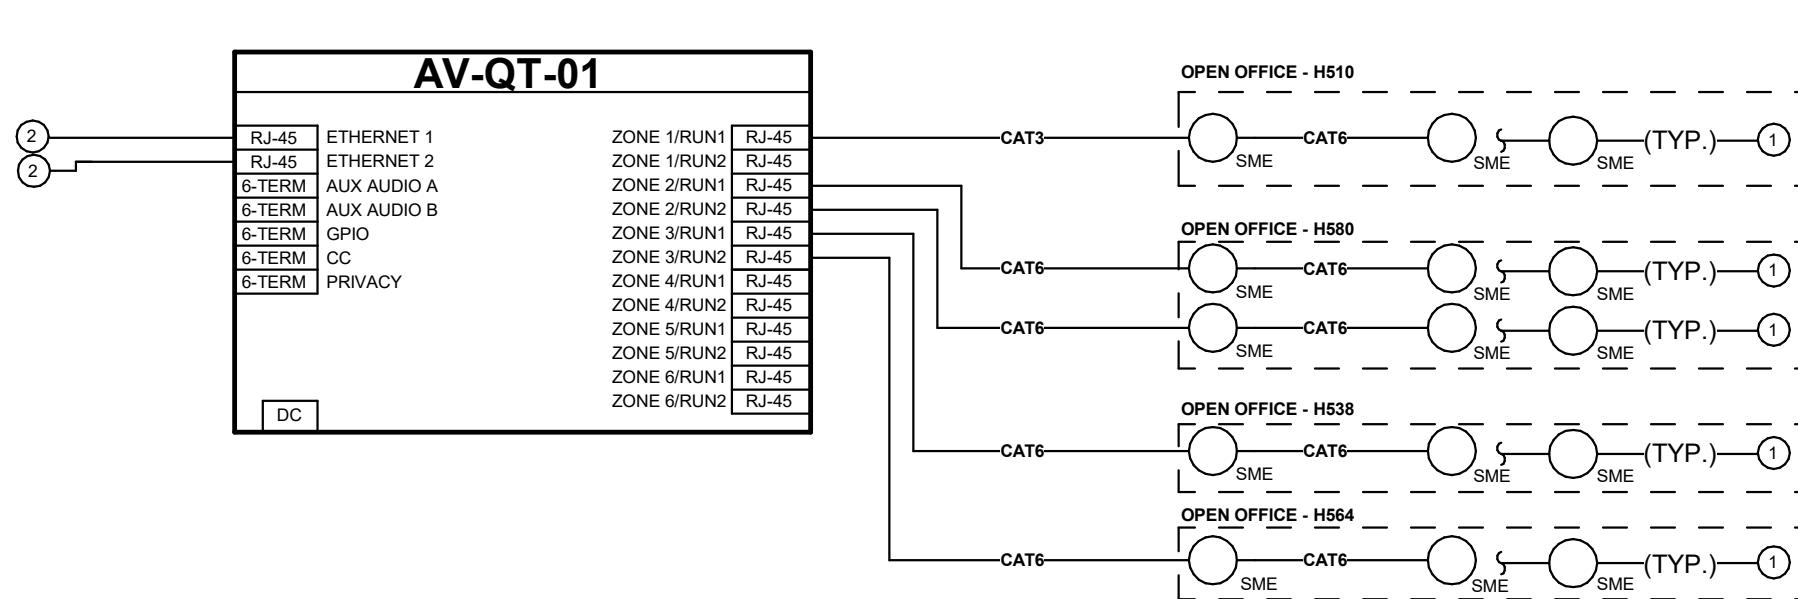

GENERAL NOTES:  
1. RISER IS DIAGRAMMATIC IN NATURE AND NOT MEANT TO SHOW EVERY PIECE OF HARDWARE OR CONNECTIONS. PROVIDE ALL NECESSARY ACCESSORIES, HARDWARE, MOUNTS, CABLING, CONNECTIONS AND PROGRAMMING FOR A FULLY FUNCTIONING SYSTEM.

2. REFER TO FLOOR PLANS FOR DEVICE QUANTITIES AND LOCATIONS.

KEYNOTES:

① Emitter zone shall not exceed 60 emitters per zone or 120 emitters per output  
② Connection to owner provided network provided by others.

3 SOUND MASKING RISER DIAGRAM  
NOT TO SCALE

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PROJECT

**DACS CC IDALS  
HOOVER  
5TH FLOOR  
RENOVATION**

DES MOINES IOWA

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**TECHNOLOGY  
DETAILS, RISERS,  
AND MATERIAL  
SCHEDULES**

SHEET