




# HHS IMHI REYNOLDS BUILDING NORTH ANNEX ROOF REPLACEMENT


2277 IOWA AVENUE INDEPENDENCE, IOWA 50644

RFB # 936800-01 DAS PROJECT No. 9368.00 GENESIS PROJECT No. 2404

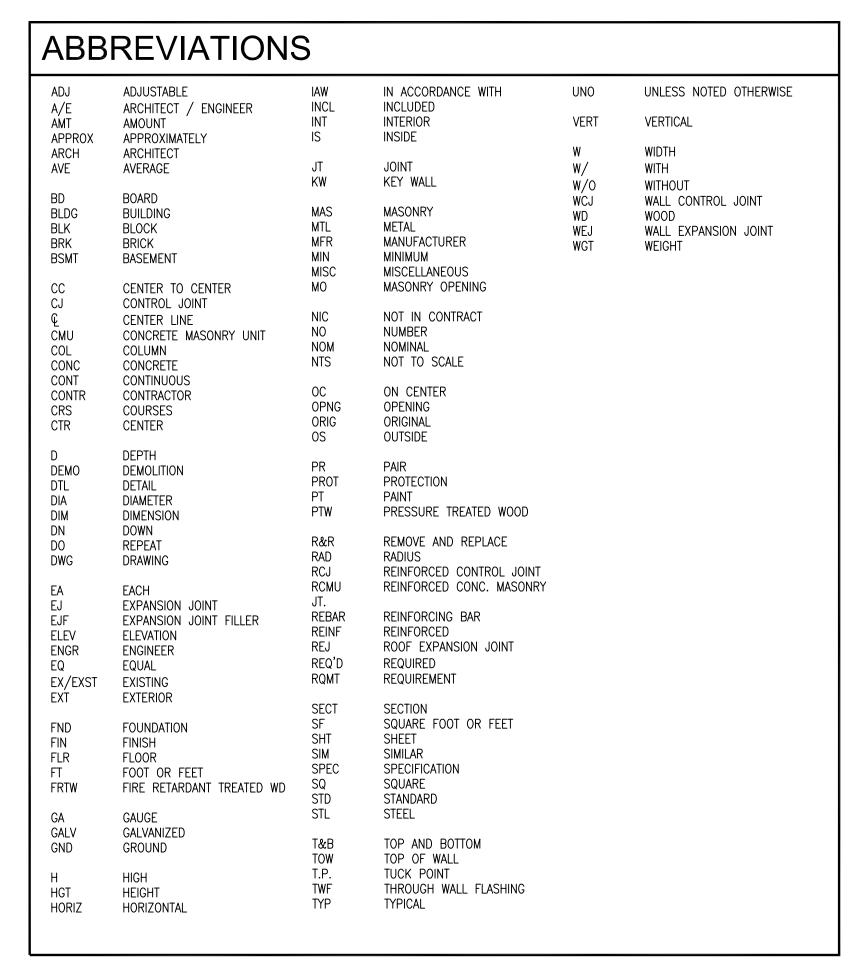

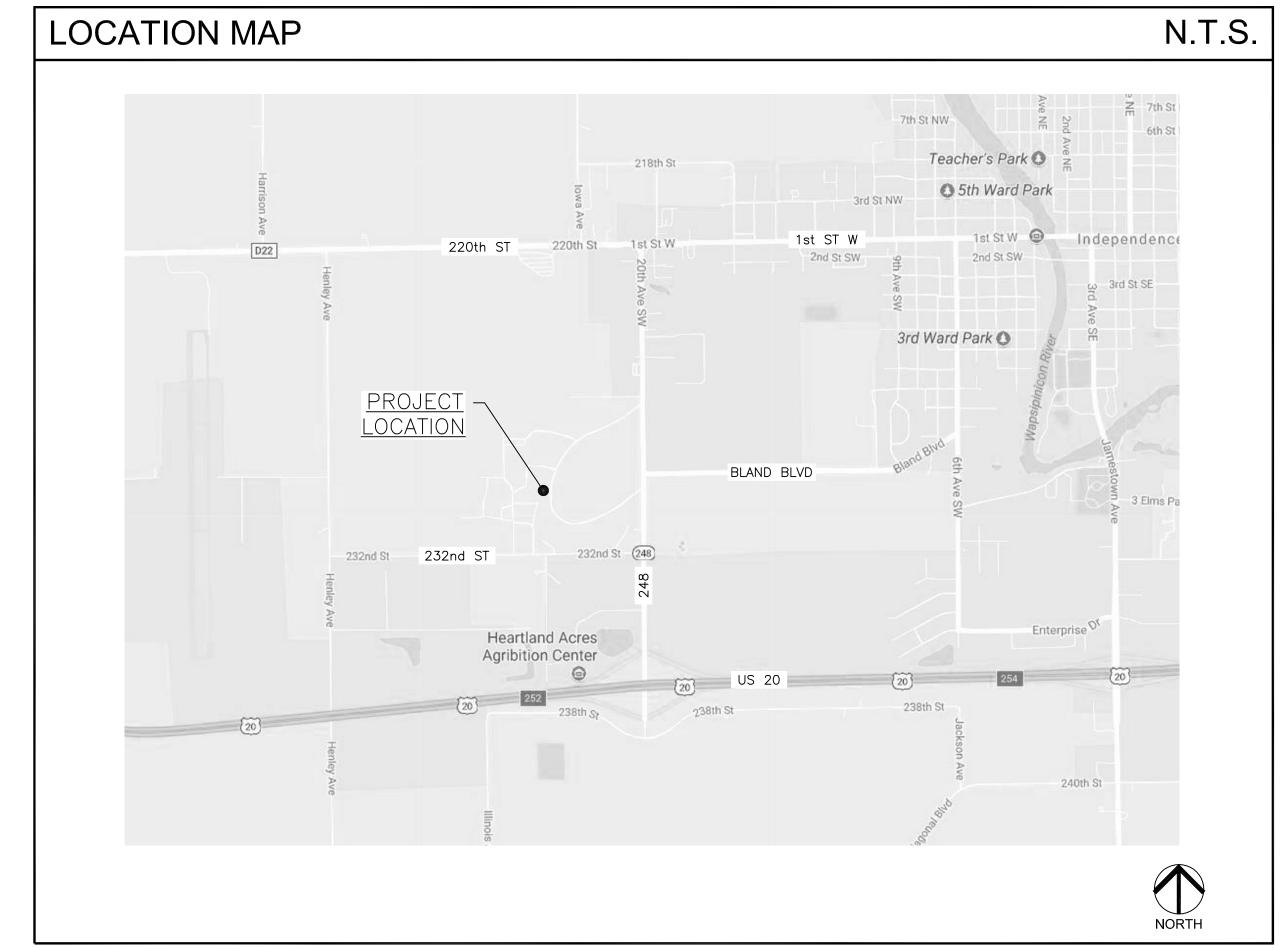

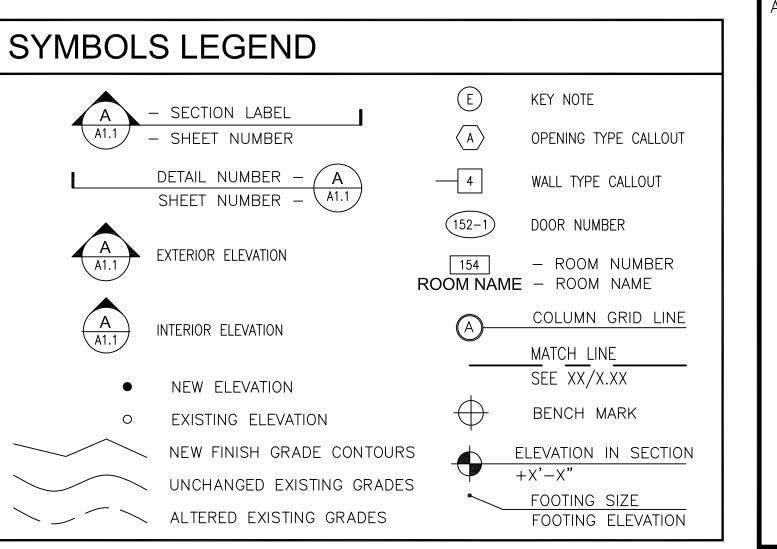


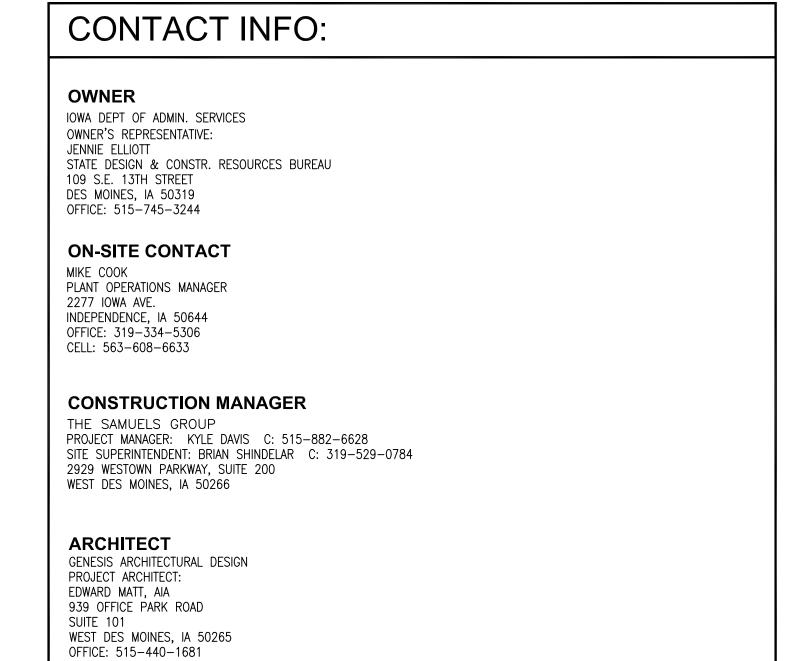



#### ARCHITECTURAL

- AO.O COVER, SHEET INDEX, CONTACTS, SYMBOLS, & ABBREVIATIONS
- AO.1 LOCATION AND STAGING MAPS
- A1.0 ROOF PLAN A2.0 DETAILS

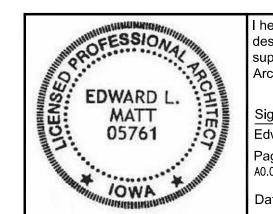

I hereby certify that the portion of this technical submission described below was prepared by me or under my supervisor and responsible charge. I am a duly registered Architect under the laws of the State of lowa.

Signature 0576
Edward L. Matt Reg. N
Pages or Sheets covered in part or whole by this seal:
A0.0, A0.1, A1.0, & A2.0

Date Issued: \_\_\_\_\_JUNE 5, 2024

PARK ROAD SUITE 101

IOINES, IOWA 50265-2505

1681

939 OFFICE PARK
WEST DES MOINE
TEL: 515-440-1687

GENES ARCHITECTURAL DESI

PROJECT TITLE

BUILDING EPLACEMENT

NORTH ANNEX ROOF REPL,

2277 IOWA AVENUE
INDEPENDENCE, IOWA 506

FINAL ISSUED DRAWINGS

SHEET CONTENTS

ER, SHEET INDEX, TACTS, SYMBOLS, ABBREVIATIONS

REVISIONS IOTE DATE

DAS PROJECT NO.

9368.00

GENESIS PROJECT NO

GENESIS PROJECT NO.

ISSUE DATE 06-05-2024

SHEET NUMBER


1 OF: 4


# SITE & STAGING NOTES:

- 1. CONTRACTOR'S PERSONNEL ARE TO FOLLOW ALL RULES FOR CONSTRUCTION WORKERS. SEE SPECIFICATION FOR REQUIREMENTS.
- 2. CONTRACTOR TO COORDINATE PROPOSED DAILY WORK SCHEDULE WITH IMHI STAFF AND CONSTRUCTION MANAGER.
- 3. ALL WORK AREAS ARE TO BE THOROUGHLY CLEANED UP AT THE END OF EACH DAY.
- 4. SEE SPECIFICATION FOR WORK HOURS. COORDINATE ANY PROPOSED EXTENDED WORK HOURS INCLUDING WEEKENDS.
- 5. PROTECT SIDEWALKS & PAVEMENT FROM HEAVY EQUIPMENT.

# SITE & STAGING MAP:

N.T.S.

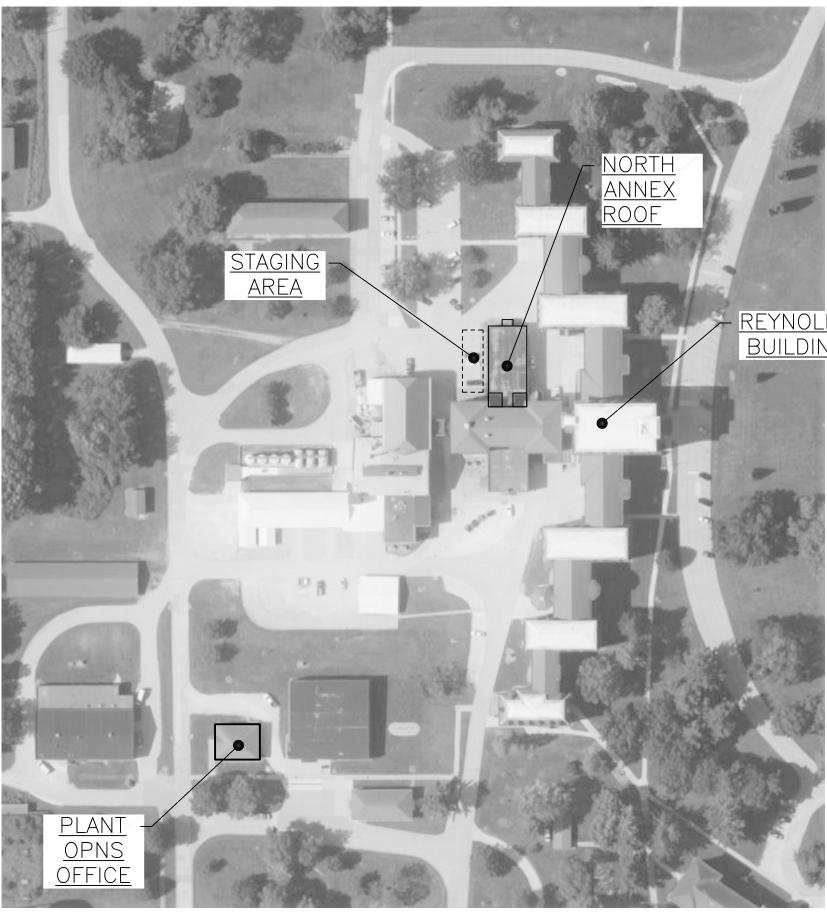

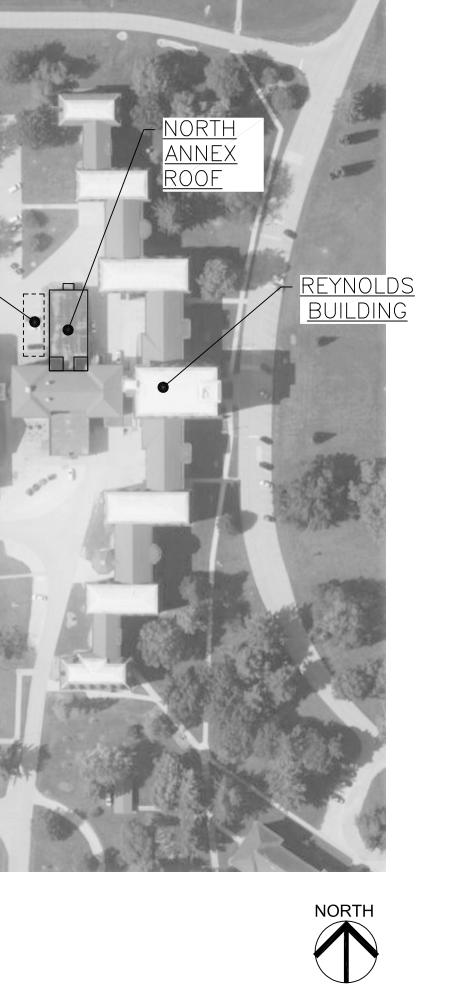



PROJECT TITLE

S BUILDING REPLACEMENT

HS TH NOR

FINAL ISSUED **DRAWINGS** 

SHEET CONTENTS

REVISIONS	
NOTE	DATE

DAS PROJECT NO. 9368.00


GENESIS PROJECT NO.

2404 ISSUE DATE

06-05-2024

SHEET NUMBER


2 OF: 4

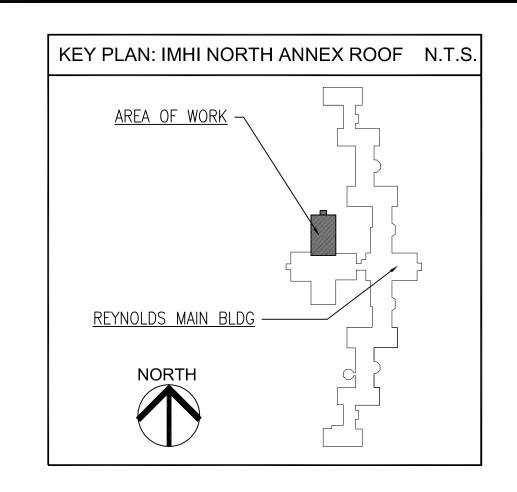

- REPLACE S.D (8"X6" H) EXISTING C.H. & D.S. (4"X6")

20'-2"


10" HIGH -PARAPET

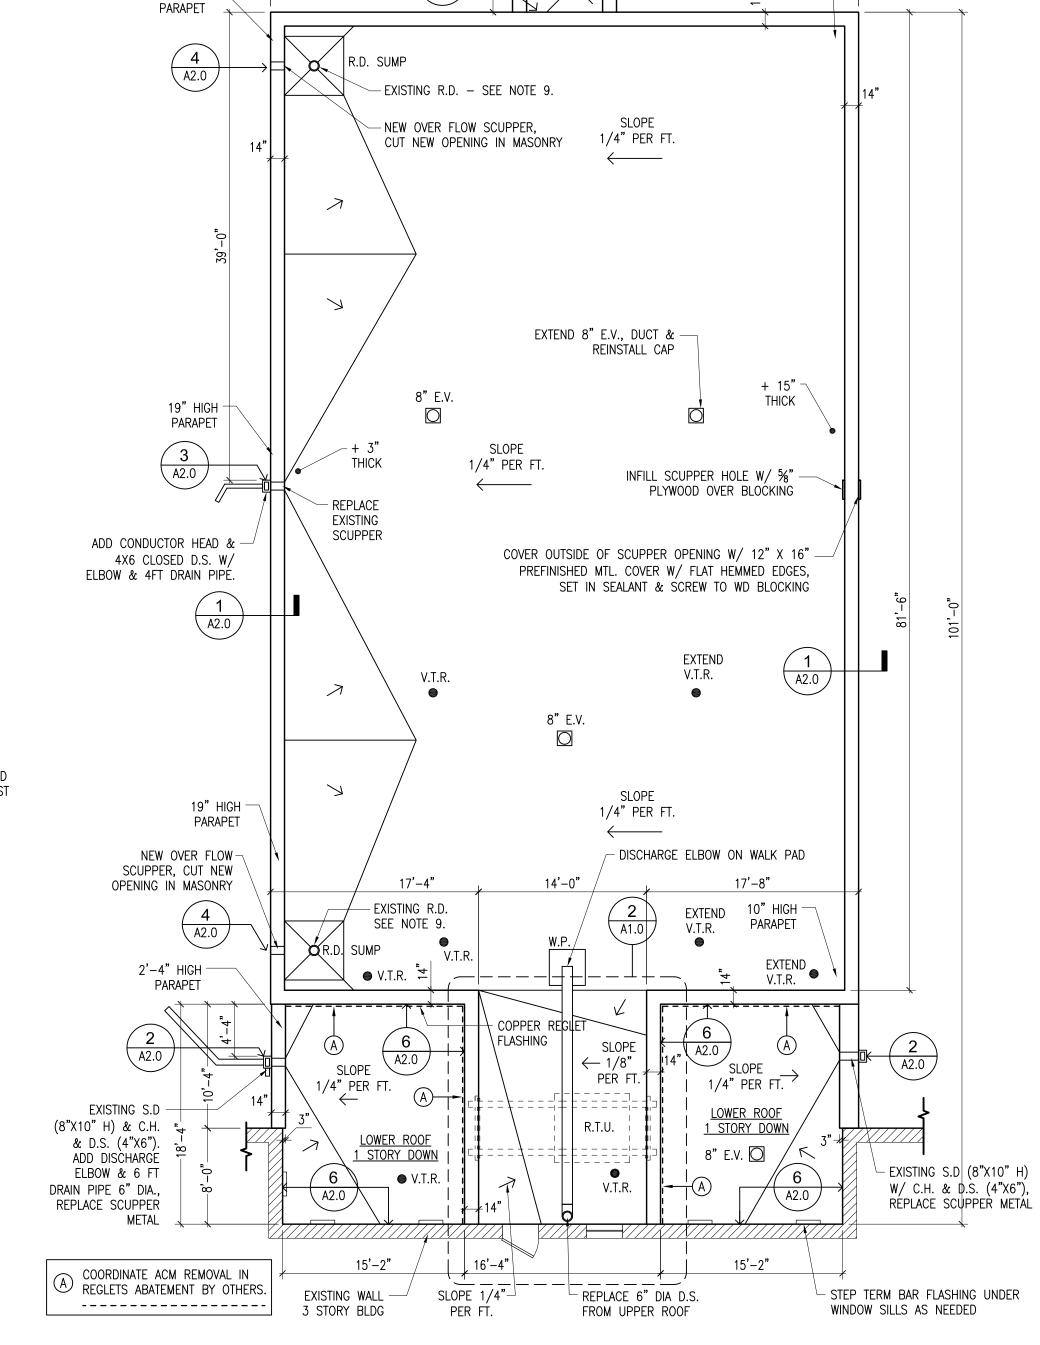

20'-2"

19" HIGH -

LOWER VESTIBULE ROOF

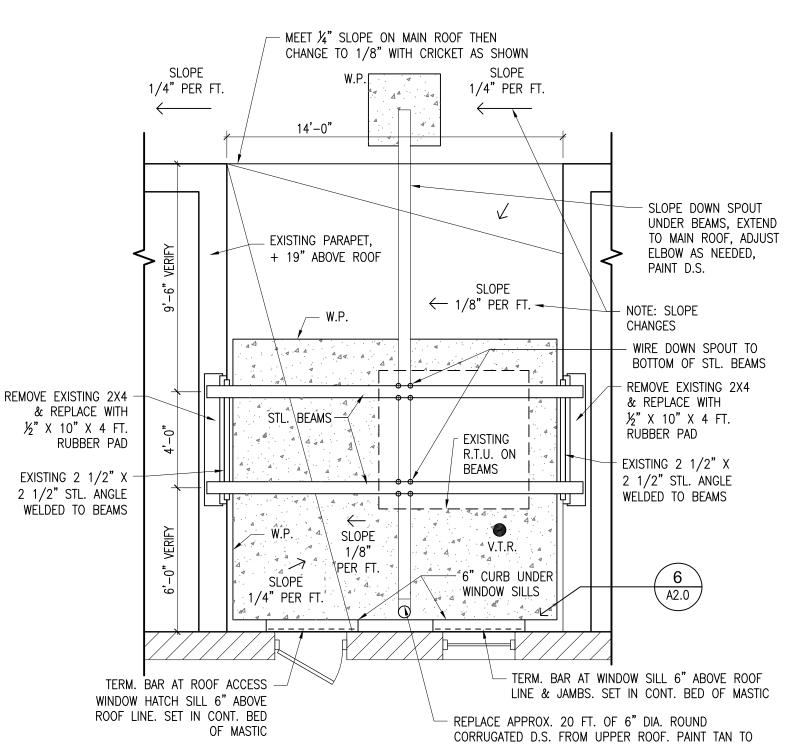

**ENLARGED PLAN** 

SCALE: 1/4" = 1'-0"

MATCH EXISTING. USE WIRE CLIPS AT 6 FT. O.C.

SCALE: 1/8" = 1'-0"



**GENERAL NOTES:** 

1. REMOVE AND DISPOSE OFF SITE ALL EXISTING MEMBRANE INSULATION, AND METAL TRIM COPINGS AND FLASHINGS.

2. CONTRACTOR TO VERIFY ALL DIMENSIONS AND QUANTITIES. 3. SF QUANTITIES ARE ESTIMATES ONLY. CONTRACTOR TO FIELD VERIFY ACTUAL SF. 4. AFTER EXISTING ROOF TEAR-OFF, CONTRACTOR TO INSPECT CONCRETE ROOF DECK &

REPAIR/TOUCHUP MASTIC VAPOR BARRIER. 5. DETAILS MAY VARY DEPENDING ON MANUFACTURER'S WARRANTY REQUIREMENTS.

6. QUANTITY, SIZE & LOCATIONS OF ALL ROOF PENETRATIONS ARE APPROXIMATED. CONTRACTOR TO FIELD VERIFY. 7. CONTRACTOR TO FIELD VERIFY ALL SITE CONDITIONS. REPORT ANY

DISCREPANCIES TO ARCHITECT PRIOR TO PROCEEDING WITH ANY WORK. 8. CONTRACTOR TO COORDINATE ALL WORK WITH OTHER TRADES AND COORDINATE SCHEDULE WITH CONSTRUCTION MANAGER.

9. CONTRACTOR TO VERIFY ALL ROOF SLOPES. 10. CLEAR ALL D.S. & ROOF DRAINS. CLEAN EXISTING ROOF DRAIN BOWLS OF DEBRIS & MASTIC. PROVIDE NEW CLAMPING RINGS AND CAST IRON DOME GRATES. 11. ALL SADDLES & CRICKETS TO BE 1/2" SLOPE EXCEPT AT 2/A1.0.

#### COLOR SELECTIONS

PREFINISHED METAL: MEDIUM BRONZE

#### **EXISTING ROOF CONSTRUCTION:**

EXISTING ROOF AREAS, SLOPES AND DETAILS HAVE BEEN REPRESENTED AS ACCURATELY AS POSSIBLE. FIELD VERIFY ALL CONDITIONS.

1/2" COVER BOARD

ÉPS & XPS TAPERED INSULATION -SEE CORE SAMPLES BELOW

### ROOF CLASSIFICATION:

NEW ROOF TO MEET EXISTING ROOF CLASSIFICATION "C".

#### **NEW ROOF CONSTRUCTION:**

60 MIL FULLY ADHERED EPDM TAPERED POLISO RIGID INSULATION, FULLY ADHERED

MASTIC VAPOR BARRIER -REPAIR/TOUCH UP CONCRETE DECK -EXISTING FLAT DECK

SHEET METAL TRIM ACCESSORIES NOTES EXISTING DOWNSPOUTS TO REMAIN. CHECK AND CLEAR ALL ROOF DRAINS &

CHECK, CLEAR EXISTING & CLEAN

SIM: 2/A2.0

DOWNSPOUTS. EXISTING PREFINISHED METAL COPING & TRIM TO BE REMOVED & REPLACED.

#### ROOF SYMBOLS, ABBREV. & NOTES:

● V.T.R. - VENT THRU ROOF SEE DETAIL: 5/A2.0

E.V. — EXHAUST VENT

R.D. – ROOF DRAIN

SCP., C.H., S.D. - SCUPPER SEE DETAIL: 3/A2.0


CONDUCTOR HEAD, DOWN SPOUT

C.H. — CONDUCTOR HEAD

O.F.S.D. – OVER FLOW SCUPPER DRAIN SEE DETAIL: 4/A2.0

D.S. - DOWN SPOUT (CLOSE FACE) SIZE: 4" X 6"

W.P. - WALK PAD

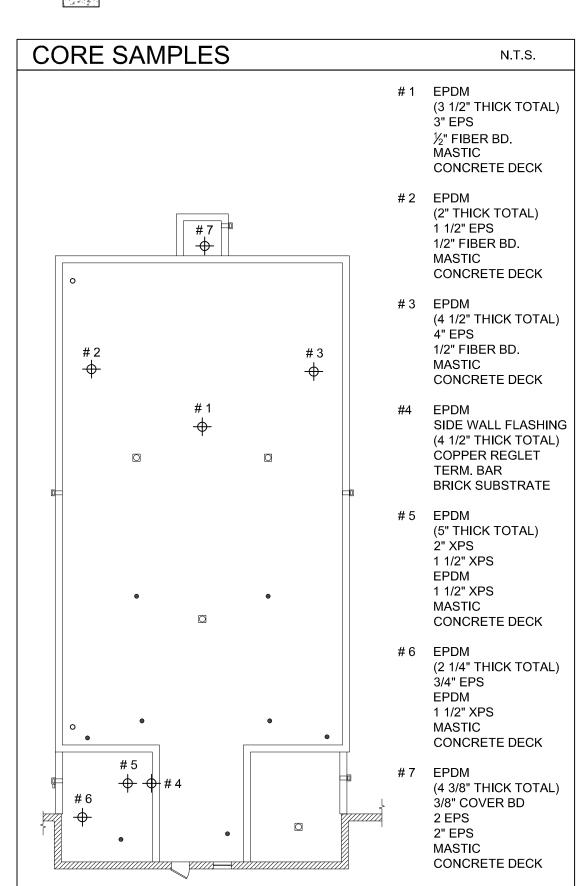

ARCHITECT

PROJECT TITLE

ΩШ žΣ LAC  $\mathbf{m}$   $\mathbf{\sigma}$ 

R 00 ZO Ош DE SI  $T \vdash$ 0

**FINAL ISSUED DRAWINGS** 

SHEET CONTENTS

REVISIONS DATE

DAS PROJECT NO.

9368.00 GENESIS PROJECT NO.

2404

SSUE DATE 06-05-2024

SHEET NUMBER

3 OF: 4

