



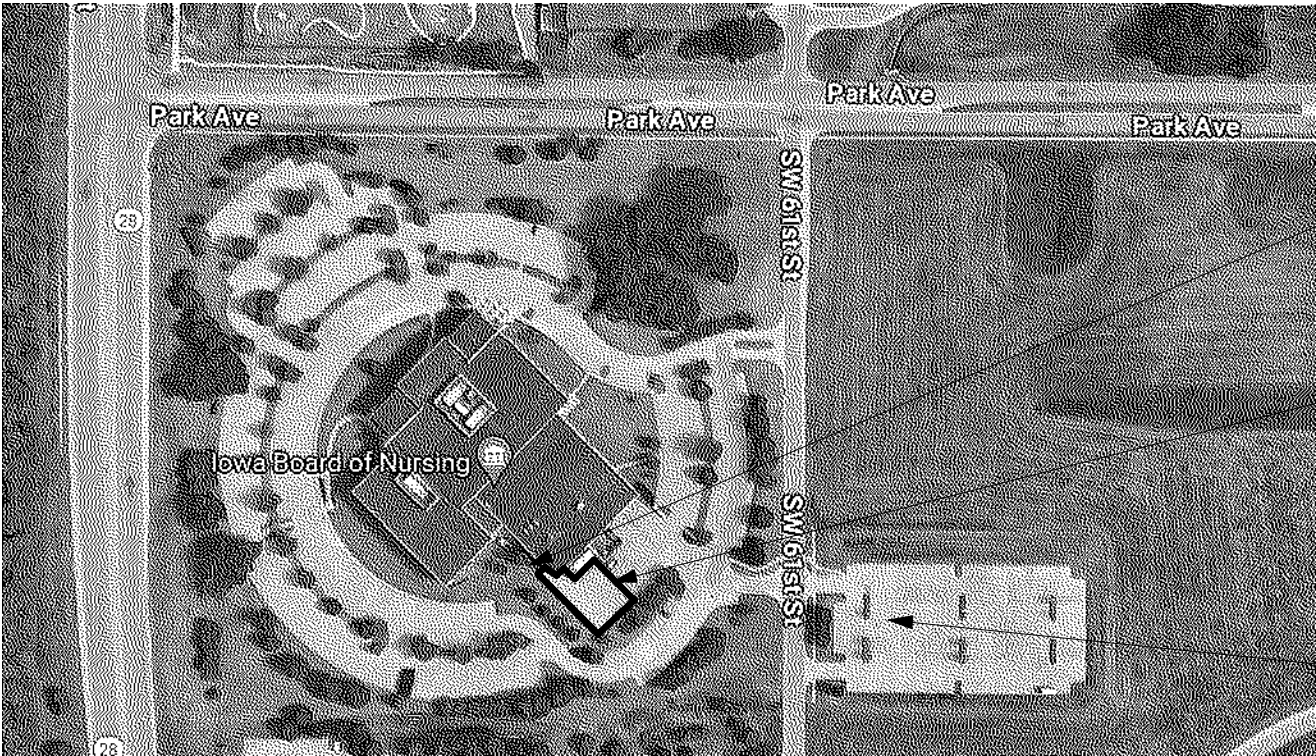

PROJECT LOCATION MAP

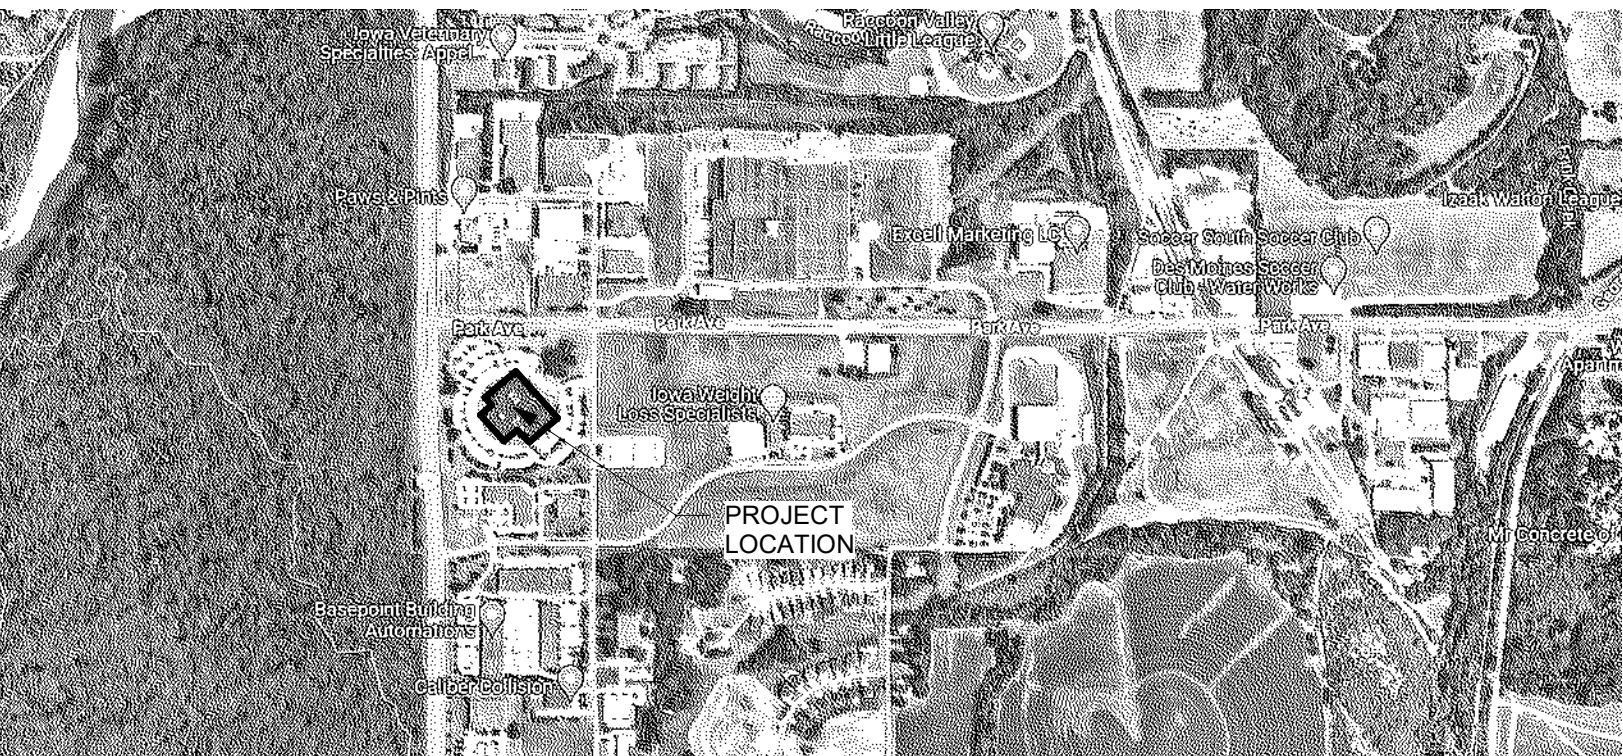


EXIST. GREASE INTERCEPTOR LOCATION

CONTRACTOR STAGING AREA AND TEMPORARY FACILITIES -
COORDINATE FINAL LAYOUT WITH CONSTRUCTION
MANAGER AND OWNER. PROVIDE TEMPORARY FENCING AS
REQUIRED.

COORDINATE CONTRACTOR PARKING WITH
CONSTRUCTION MANAGER AND OWNER.

STATE OF IOWA - DEPARTMENT OF ADMINISTRATIVE SERVICES - 9411.00 - DAS 6200 PARK ALJ - WORKMAN'S COMP RENOVATION

6200 PARK AVE, DES MOINES, IA 50321

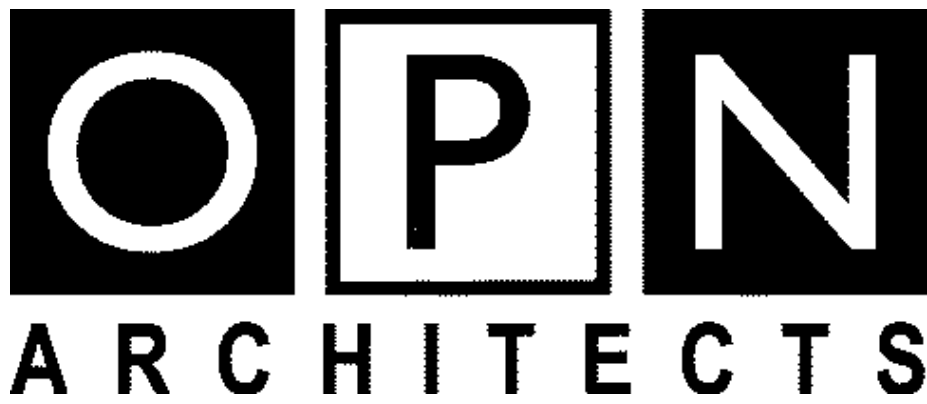

100 Court Ave. Suite 100, Des Moines, IA 50309
P: 515-309-0722 F: 515-309-0725 www.opnarchitects.com

SHEET INDEX

GENERAL DRAWINGS

SHEET NUMBER	SHEET NAME
G001	LIFE SAFETY AND CODE SUMMARY

CIVIL DRAWINGS

SHEET NUMBER	SHEET NAME
C01	CIVIL COVER SHEET
C02	DEMOLITION PLAN
C03	GRADING PLAN

STRUCTURAL DRAWINGS

SHEET NUMBER	SHEET NAME
S100	STRUCTURAL NOTES
S101	FOUNDATION AND FRAMING PLANS
S102	STRUCTURAL DETAILS

ARCHITECTURAL DRAWINGS

SHEET NUMBER	SHEET NAME
A000	GENERAL DRAWING INFORMATION
A001	DOOR AND FINISH INFORMATION
AD101	DEMO FLOOR PLANS
AD102	DEMO REFLECTED CEILING PLANS
AD103	DEMO PHOTOS
AD104	DEMO PHOTOS
A101	FLOOR PLAN
A102	REFLECTED CEILING PLANS
A201	EXTERIOR ELEVATIONS & WALL SECTIONS
A401	INTERIOR ELEVATIONS
A800	FURNITURE PLAN (REFERENCE ONLY)

MECHANICAL, PLUMBING, FIRE PROTECTION DRAWINGS

SHEET NUMBER	SHEET NAME
M000	MECHANICAL GENERAL NOTES & SYMBOLS
MD101	MECHANICAL DEMOLITION
M101	MECHANICAL HVAC PLAN
M301	MECHANICAL DETAILS
M501	MECHANICAL SCHEDULES
PD100	UNDER FLOOR PLUMBING DEMOLITION
PD101	PLUMBING DEMOLITION
P100	PLUMBING FOUNDATION PLAN
P101	PLUMBING PLAN
P301	PLUMBING DETAILS
P501	PLUMBING SCHEDULES
F101	FIRE PROTECTION PLAN

ELECTRICAL DRAWINGS

SHEET NUMBER	SHEET NAME
E000	ELECTRICAL GENERAL NOTES & SYMBOLS
ED101	ELECTRICAL POWER & SYSTEMS DEMO
ED102	ELECTRICAL LIGHTING DEMO
E101	ELECTRICAL POWER & SYSTEMS
E201	ELECTRICAL LIGHTING
E301	ELECTRICAL SCHEDULES
E302	ELECTRICAL PANEL SCHEDULES

All questions regarding these plans and specifications should be directed to:

Nate Stielor, AIA
Project Manager
nstielor@opnarchitects.com
(515) 309-6882




I hereby certify these plans and specifications were prepared by me or under my direct personal supervision and that I am a duly licensed professional architect under the laws of the state of Iowa.

Signature: *Terry Gebard*

Name: Terry Gebard, AIA

Iowa Registration No: 05219 Renewal Date: 6/30/2026

Sheets covered by this seal: Listed As "Architectural"

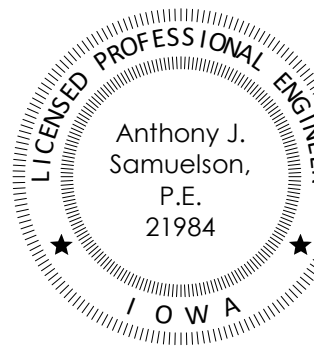


I hereby certify this engineering document was prepared by me or under my direct personal supervision and that I am a duly licensed professional engineer under the laws of the state of Iowa.

Signature: *Anthony J. Samuelson*

Name: Anthony J. Samuelson, P.E.

Iowa Registration No: 21984 Renewal Date: 12/31/2025

Sheets covered by this seal: Listed As "Structural"

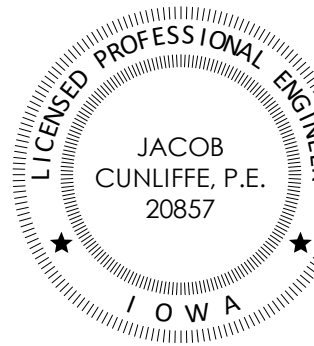


I hereby certify this engineering document was prepared by me or under my direct personal supervision and that I am a duly licensed professional engineer under the laws of the state of Iowa.

Signature: *Jacob Cunliffe*

Name: JACOB CUNLIFFE, P.E.

Iowa Registration No: 20857 Renewal Date: 12/31/2025

Sheets covered by this seal: Listed As "Mechanical, Plumbing"

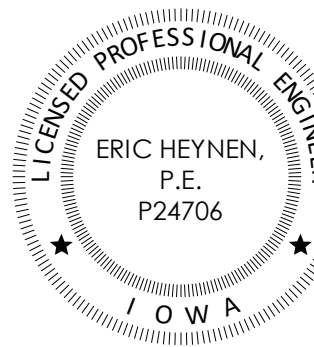


I hereby certify this engineering document was prepared by me or under my direct personal supervision and that I am a duly licensed professional engineer under the laws of the state of Iowa.

Signature: *Eric Heynen*

Name: ERIC HEYNEN, P.E.

Iowa Registration No: P24706 Renewal Date: 12/31/2025

Sheets covered by this seal: Listed As "Electrical"

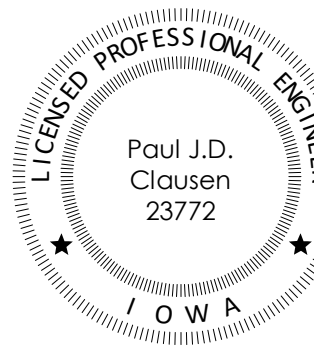

I hereby certify this engineering document was prepared by me or under my direct personal supervision and that I am a duly licensed professional engineer under the laws of the state of Iowa.

Signature: *Paul J.D. Clausen*

Name: Paul J.D. Clausen

Iowa Registration No: 23772 Renewal Date: 12/31/2025

Sheets covered by this seal: Listed As "Civil"

ARCHITECT

OPN ARCHITECTS
100 COURT AVENUE
DES MOINES, IA 50309

CONSTRUCTION MANAGER

DCI GROUP
200 SE 6TH STREET, SUITE 200
DES MOINES, IA 50309

MECHANICAL ENGINEER/ BUILDER

KCL ENGINEERING
4717 GRAND AVENUE
WEST DES MOINES, IA 50265

STRUCTURAL ENGINEER

RAKER RHODES ENGINEERING
4717 GRAND AVENUE
DES MOINES, IA 50312

ELECTRICAL ENGINEER/BUILDER

KCL ENGINEERING
300 4TH STREET
WEST DES MOINES, IA 50265

CIVIL ENGINEER

CIVIL ENGINEERING CONSULTANTS, INC
2400 86TH STREET, UNIT 12
DES MOINES, IA 50322

SITE PLAN - MINOR MOD
6200 PARK AVENUE
6200 PARK AVENUE, DES MOINES, IA 50321

GENERAL NOTES

- ONE WEEK PRIOR TO CONSTRUCTION THE CONTRACTOR SHALL NOTIFY:
 - OPN ARCHITECTS
 - ALL - WORKMANS COMP
 - CIVIL ENGINEERING CONSULTANTS, INC.
 - "ONE CALL" UTILITY LOCATE SERVICE
 - DES MOINES WATER WORKS
- ALL DIMENSIONS ARE TO BACK OF CURB, OUTSIDE OF BUILDING WALL, AND TO PROPERTY LINES.
- LOCATIONS AND DIMENSIONS SHOWN ON PLANS FOR EXISTING FACILITIES ARE IN ACCORDANCE WITH AVAILABLE INFORMATION WITHOUT UNCOVERING AND MEASURING. ENGINEER DOES NOT GUARANTEE ACCURACY OF INFORMATION OR THAT ALL EXISTING UNDERGROUND FACILITIES ARE SHOWN. IT IS RESPONSIBILITY OF CONTRACTOR TO CONTACT ALL PUBLIC AND/OR PRIVATE UTILITIES SERVING AREA TO DETERMINE PRESENT EXTENT AND EXACT LOCATION OF FACILITIES BEFORE BEGINNING WORK.
- CONTRACTOR IS REQUIRED TO TAKE DUE PRECAUTIONARY MEASURES TO PROTECT UTILITIES OR STRUCTURES AT SITE. IT SHALL BE CONTRACTOR'S RESPONSIBILITY TO NOTIFY OWNERS OF UTILITIES OR STRUCTURES CONCERNED BEFORE STARTING WORK. CONTRACTOR SHALL NOTIFY PROPER UTILITY IMMEDIATELY UPON BREAKING OR DAMAGE TO ANY UTILITY LINE OR APPURTENANCE, OR INTERRUPTION OF SERVICE. HE SHALL NOTIFY PROPER UTILITY INVOLVED. IF EXISTING UTILITY LINES ARE ENCOUNTERED THAT CONFLICT IN LOCATION WITH NEW CONSTRUCTION, CONTRACTOR SHALL NOTIFY ENGINEER SO CONFLICT MAY BE RESOLVED.
- ALL CONSTRUCTION SHALL BE IN ACCORDANCE WITH URBAN STANDARD SPECIFICATIONS.
- ALL DEBRIS SPILLED ON COUNTY R.O.W. AND ADJOINING PROPERTY SHALL BE REMOVED BY OWNER/CONTRACTOR IN TIMELY FASHION.
- ALL SITEWORK, SODDING AND LANDSCAPING SHALL BE IN ACCORDANCE WITH CITY OF DES MOINES STANDARD SPECIFICATIONS UNLESS SPECIFIED OTHERWISE.
- ANY AMENDMENTS OR CHANGES TO PROJECT SITE NOT MEETING WHAT IS SHOWN ON SITE PLAN NEED TO BE APPROVED WITH PERMIT AND DEVELOPMENT CENTER PRIOR TO INSTALLATION / CONSTRUCTION.
- REQUIRED LANDSCAPING, BOTH EXISTING AND PROPOSED, SHALL BE MAINTAINED FOR LIFE OF CERTIFICATE OF OCCUPANCY.
- ALL DISTURBED AREAS SHALL BE RESTORED BY SEEDING OR SODDING.
- CONTACT CITY TRAFFIC AND TRANSPORTATION (283-4473) BEFORE CONSTRUCTION BEGINS AND COORDINATE WORK AS NECESSARY.
- SITE SHALL BE MAINTAINED IN COMPLIANCE WITH ALL CITY CODES APPLICABLE ON DATE OF SITE PLAN APPROVAL.
- ALL PLANTING BEDS SHALL INCLUDE NON-LIVING PERMEABLE MATERIALS SUCH AS MULCH, BUT NOT INCLUDING ROCK.



VICINITY MAP
1" = 500'



GENERAL LEGEND

- PROPOSED**
- PLAT BOUNDARY
 - SECTION LINE
 - LOT LINE
 - CENTERLINE
 - EASEMENT LINE
 - FLARED END SECTION
 - DRAIN BASIN OR SEDIMENT RISER
 - DRAIN BASIN WITH SOLID GRATE
 - WATER VALVE
 - FIRE HYDRANT ASSEMBLY
 - BLOW-OFF HYDRANT
 - SCOUR STOP MAT
 - TURF REINFORCEMENT MAT
 - STORM SEWER WITH SIZE
 - WATER SEWER WITH SIZE
 - WATER SERVICE
 - PROPOSED CONTOUR
 - SILT FENCE
 - ADDRESS
 - RIPRAP

EXISTING

- LOT LINE
- SANITARY/STORM MANHOLE
- WATER VALVE
- FIRE HYDRANT
- STORM SEWER SINGLE INTAKE
- STORM SEWER DOUBLE INTAKE
- STORM SEWER ROUND INTAKE
- FLARED END SECTION
- DECIDUOUS TREE
- CONIFEROUS TREE
- SHRUB
- POWER POLE
- STREET LIGHT
- GUY ANCHOR
- ELECTRIC TRANSFORMER
- GAS METER
- TELEPHONE RISER
- SIGN
- UNDERGROUND TELEVISION
- UNDERGROUND ELECTRIC
- UNDERGROUND GAS
- UNDERGROUND FIBER OPTIC
- UNDERGROUND TELEPHONE
- OVERHEAD ELECTRIC
- SANITARY SEWER WITH SIZE
- STORM SEWER WITH SIZE
- WATER MAIN WITH SIZE
- EXISTING CONTOUR
- TREELINE
- BUILDING SETBACK LINE
- PUBLIC UTILITY EASEMENT
- MINIMUM OPENING ELEVATION

SITE PLAN

APPROVED APPROVED WITH CONDITIONS

IN ACCORDANCE WITH (SECTION 82-207(C.) 2000 DES MOINES MUNICIPAL CODE. AS AMENDED.
NO CHANGES TO THIS PLAN UNLESS APPROVED IN WRITING FROM THE PLANNING DIRECTOR OR NEW AMENDED DATED PLAN.

DATE PLANNING DIRECTOR

APPLICANT:

STATE OF IOWA
800 LINCOLN WAY
AMES, IA 50010-6415

PROPERTY OWNER:

AIRPORT DEVELOPMENT LC
KNAFF PROPERTIES
5000 WESTOWN PKWY STE 400
WEST DES MOINES, IA 50266-5421

PROJECT ADDRESS

6000 PARK AVENUE
DES MOINES, IOWA 50321

PROJECT MANAGER:

PAUL CLAUSEN, PE
CIVIL ENGINEERING CONSULTANTS
2400 86TH STREET, #12
DES MOINES, IOWA 50322
PH. 515-276-4884 EXT. #217
EMAIL: CLAUSEN@CECLAC.COM

PROFESSIONAL LAND SURVEYOR:

CIVIL ENGINEERING CONSULTANTS, INC.
PH: JEFFERY A. GADDIS, PLS
2400 86TH STREET, SUITE 12
URBANDALE, IA 50322
PH. 515-276-4884 EXT. 221
EMAIL: GADDIS@CECLAC.COM

MUNICIPALITY PLANNER:

JILLIAN SOMMER
PERMIT and DEVELOPMENT CENTER
SITE PLANNING REVIEW
PHONE: (515) 283-4581
EMAIL: JLSommer@dmgov.org

LEGAL DESCRIPTION

LOT 1 AIRPORT COMMERCE PARK WEST PLAT 3 RECORDED IN BOOK 8401, PAGE 1-15 AT THE POLK COUNTY RECORDER'S OFFICE.

ZONING

RUD - AIRPORT COMMERCE PARK WEST

BULK REGULATIONS

RUD

- BUILDING SETBACKS
- FRONT YARD: 50 FEET
 - SIDE YARD: 20 FEET
 - REAR YARD: 20 FEET TOTAL, 5 FEET MINIMUM, ONE SIDE

- PARKING SETBACKS
- FRONT YARD: 15 FEET
 - REAR & SIDE YARD: 5 FEET

NUMBER OF EMPLOYEES

SPECULATIVE SPACE. QUANTITY OF EMPLOYEES
INDETERMINANT.

DEVELOPMENT SCHEDULE

SITE DEMO JULY, 2024
SITE PAVING AUGUST, 2024
PROJECT COMPLETE SEPTEMBER, 2024

FLOOD ZONE CLASSIFICATION

ZONE 'X' ACCORDING TO FEMA FLOOD INSURANCE RATE MAPS.
COMMUNITY-PANEL NUMBER 19159C0340F
MAP REVISED: 2/1/2019

BENCHMARKS

CITY OF DES MOINES BENCHMARK #4412

BRASS TABLET ON SW CORNER TRAFFIC SIGNAL BASE AT THE NE CORNER OF
PARK AVENUE & SW 56TH STREET

ELEVATION: (CITY OF DES MOINES DATUM) 51.328 FT

CITY OF DES MOINES BENCHMARK #4416

BRASS TABLET ON NE CORNER TRAFFIC SIGNAL BASE AT 5501 PARK AVENUE
(NORTH SIDE).

ELEVATION: (CITY OF DES MOINES DATUM) 45.658 FT

GENERAL USE

OFFICE / WAREHOUSE - MULTIPLE USER

UTILITIES

WATER SUPPLY: DES MOINES WATER WORKS.
SANITARY SEWER: CITY OF DES MOINES.
STORM SEWER: CITY OF DES MOINES.

Sheet List Table

Sheet Number	Sheet Title
01	COVER
02	DEMOLITION PLAN
03	GRADING PLAN

SUBMITTAL TABLE

SUBMITTAL DATE	SUBMITTAL NOTES
JULY 03, 2024	INITIAL SUBMITTAL
JULY 25, 2024	
AUGUST 01, 2024	
AUGUST 07, 2024	
AUGUST 13, 2024	

Civil Engineering Consultants, Inc.

2400 86th Street, Unit 12, Des Moines, Iowa 50322
515.276.4884 . Fax: 515.276.7084 . mail@ceclac.com

CEC

PUBLISH DATE: August 13, 2024

DATE OF SURVEY: MARCH 23, 2020

DESIGNED BY: PC

DRAWN BY: NEH


6200 PARK AVENUE
6200 PARK AVENUE, DES MOINES, IA 50321

COVER

SHEET
01
OF 03

E9249

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PLOT BY: MARTIN HILL - 2024/08/13 - q:\e-files\9000\9249_c34 drawings\construction documents\Site Plan Minor Mod\9249 SP DEMO.dwg - ANBI EXPAND D (34.00 X 22.00 INCHES) - AUTOCAD PDF (GENERAL DOCUMENTATION)P23 - CEC-XEB TEST.CTB - PLOT SCALE = 1:1

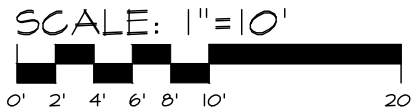

1"=10' PRINTED ON 22"x34" SHEET
1"=20' PRINTED ON 11"x17" SHEET



6200 PARK AVENUE
6200 PARK AVENUE, DES MOINES, IA 50321


DEMOLITION PLAN

PUBLISH DATE:	August 13, 2024
DATE OF SURVEY:	MARCH 23, 2020
DESIGNED BY:	PC
DRAWN BY:	MEH

Civil Engineering Consultants, Inc.
2400 86th Street, Unit 12, Des Moines, Iowa 50322
515.276.4884 · Fax: 515.276.7084 · mail@ceciac.com




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CURB RAMP
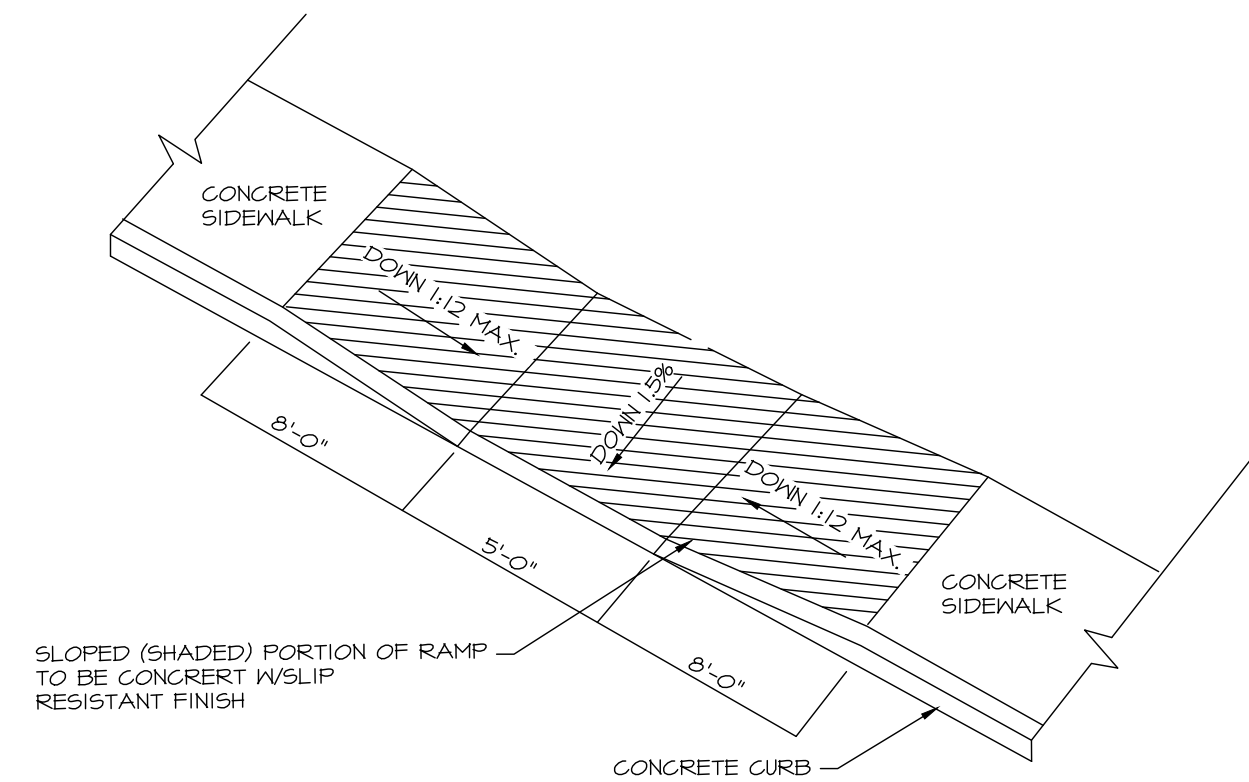
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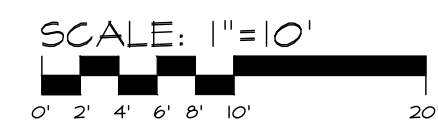
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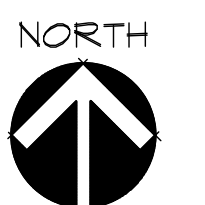


NOTES

1. CONTRACTOR SHALL INCLUDE PAVEMENT STRIPING.
2. PAVEMENT STRIPING SHALL MATCH EXISTING PAINT TYPE AND COLOR.

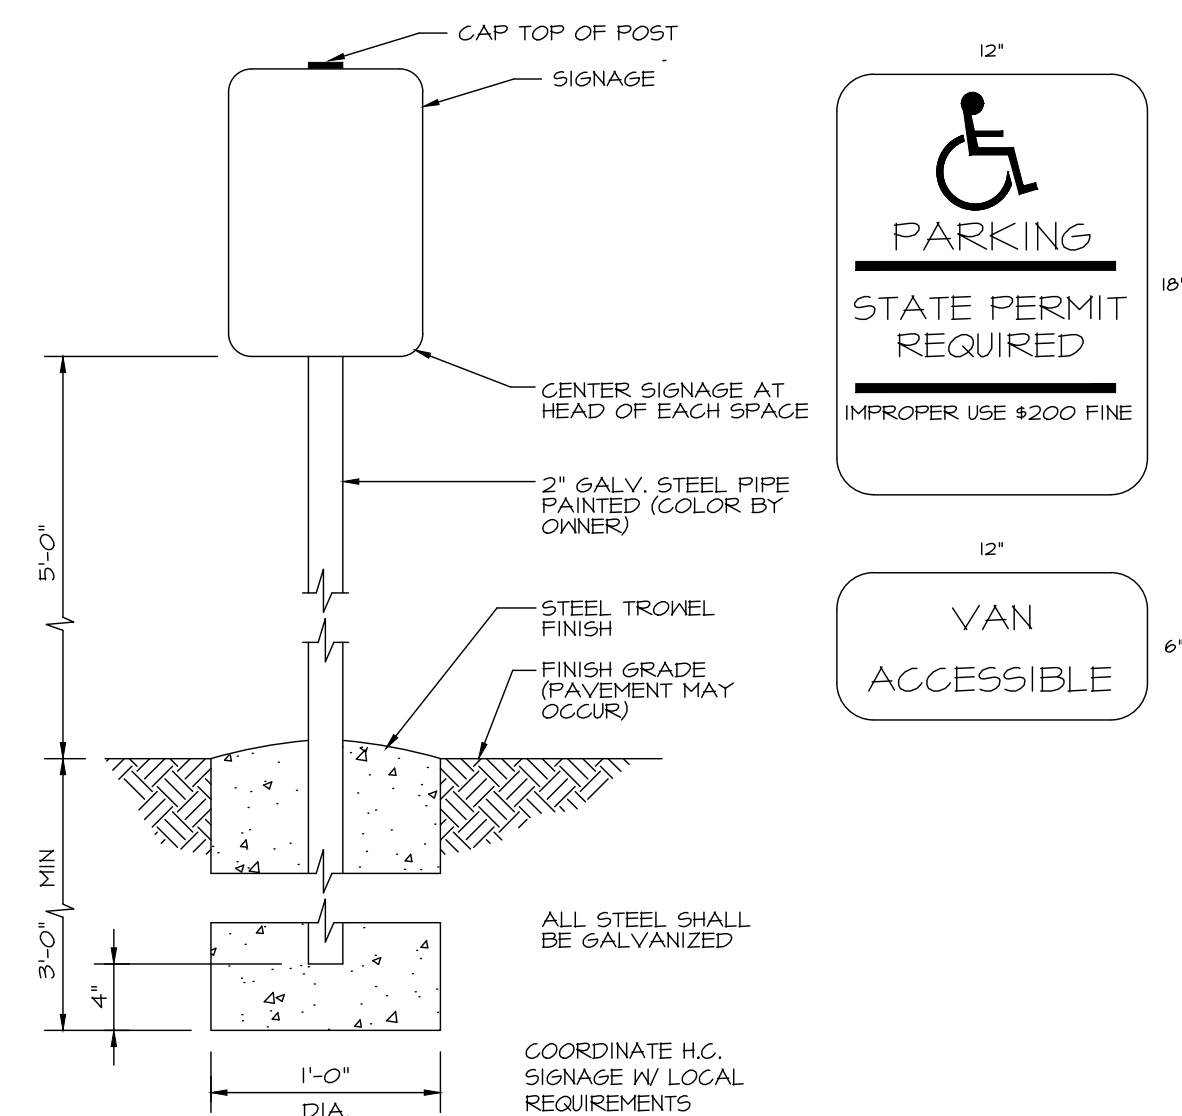

1"=10' PRINTED ON 22"x34" SHEET
1"=20' PRINTED ON 11"x17" SHEET



6200 PARK AVENUE
6200 PARK AVENUE, DES MOINES, IA 50321

6200 PARK AVENUE, DES MOINES, IA 50321

GRADING PLAN

SHEET
03
OF 03

E9249

PUBLISH DATE: August 13, 2024

MARCH 23, 2020

DATE OF SURVEY:


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DRAWN BY:DESIGNED BY:
DRAWN BY:

Civil Engineering Consultants, Inc.


2400 86th Street . Unit 12 . Des Moines, Iowa 50322
515.276.4884 . Fax: 515.276.7084 . mail@ceclac.com

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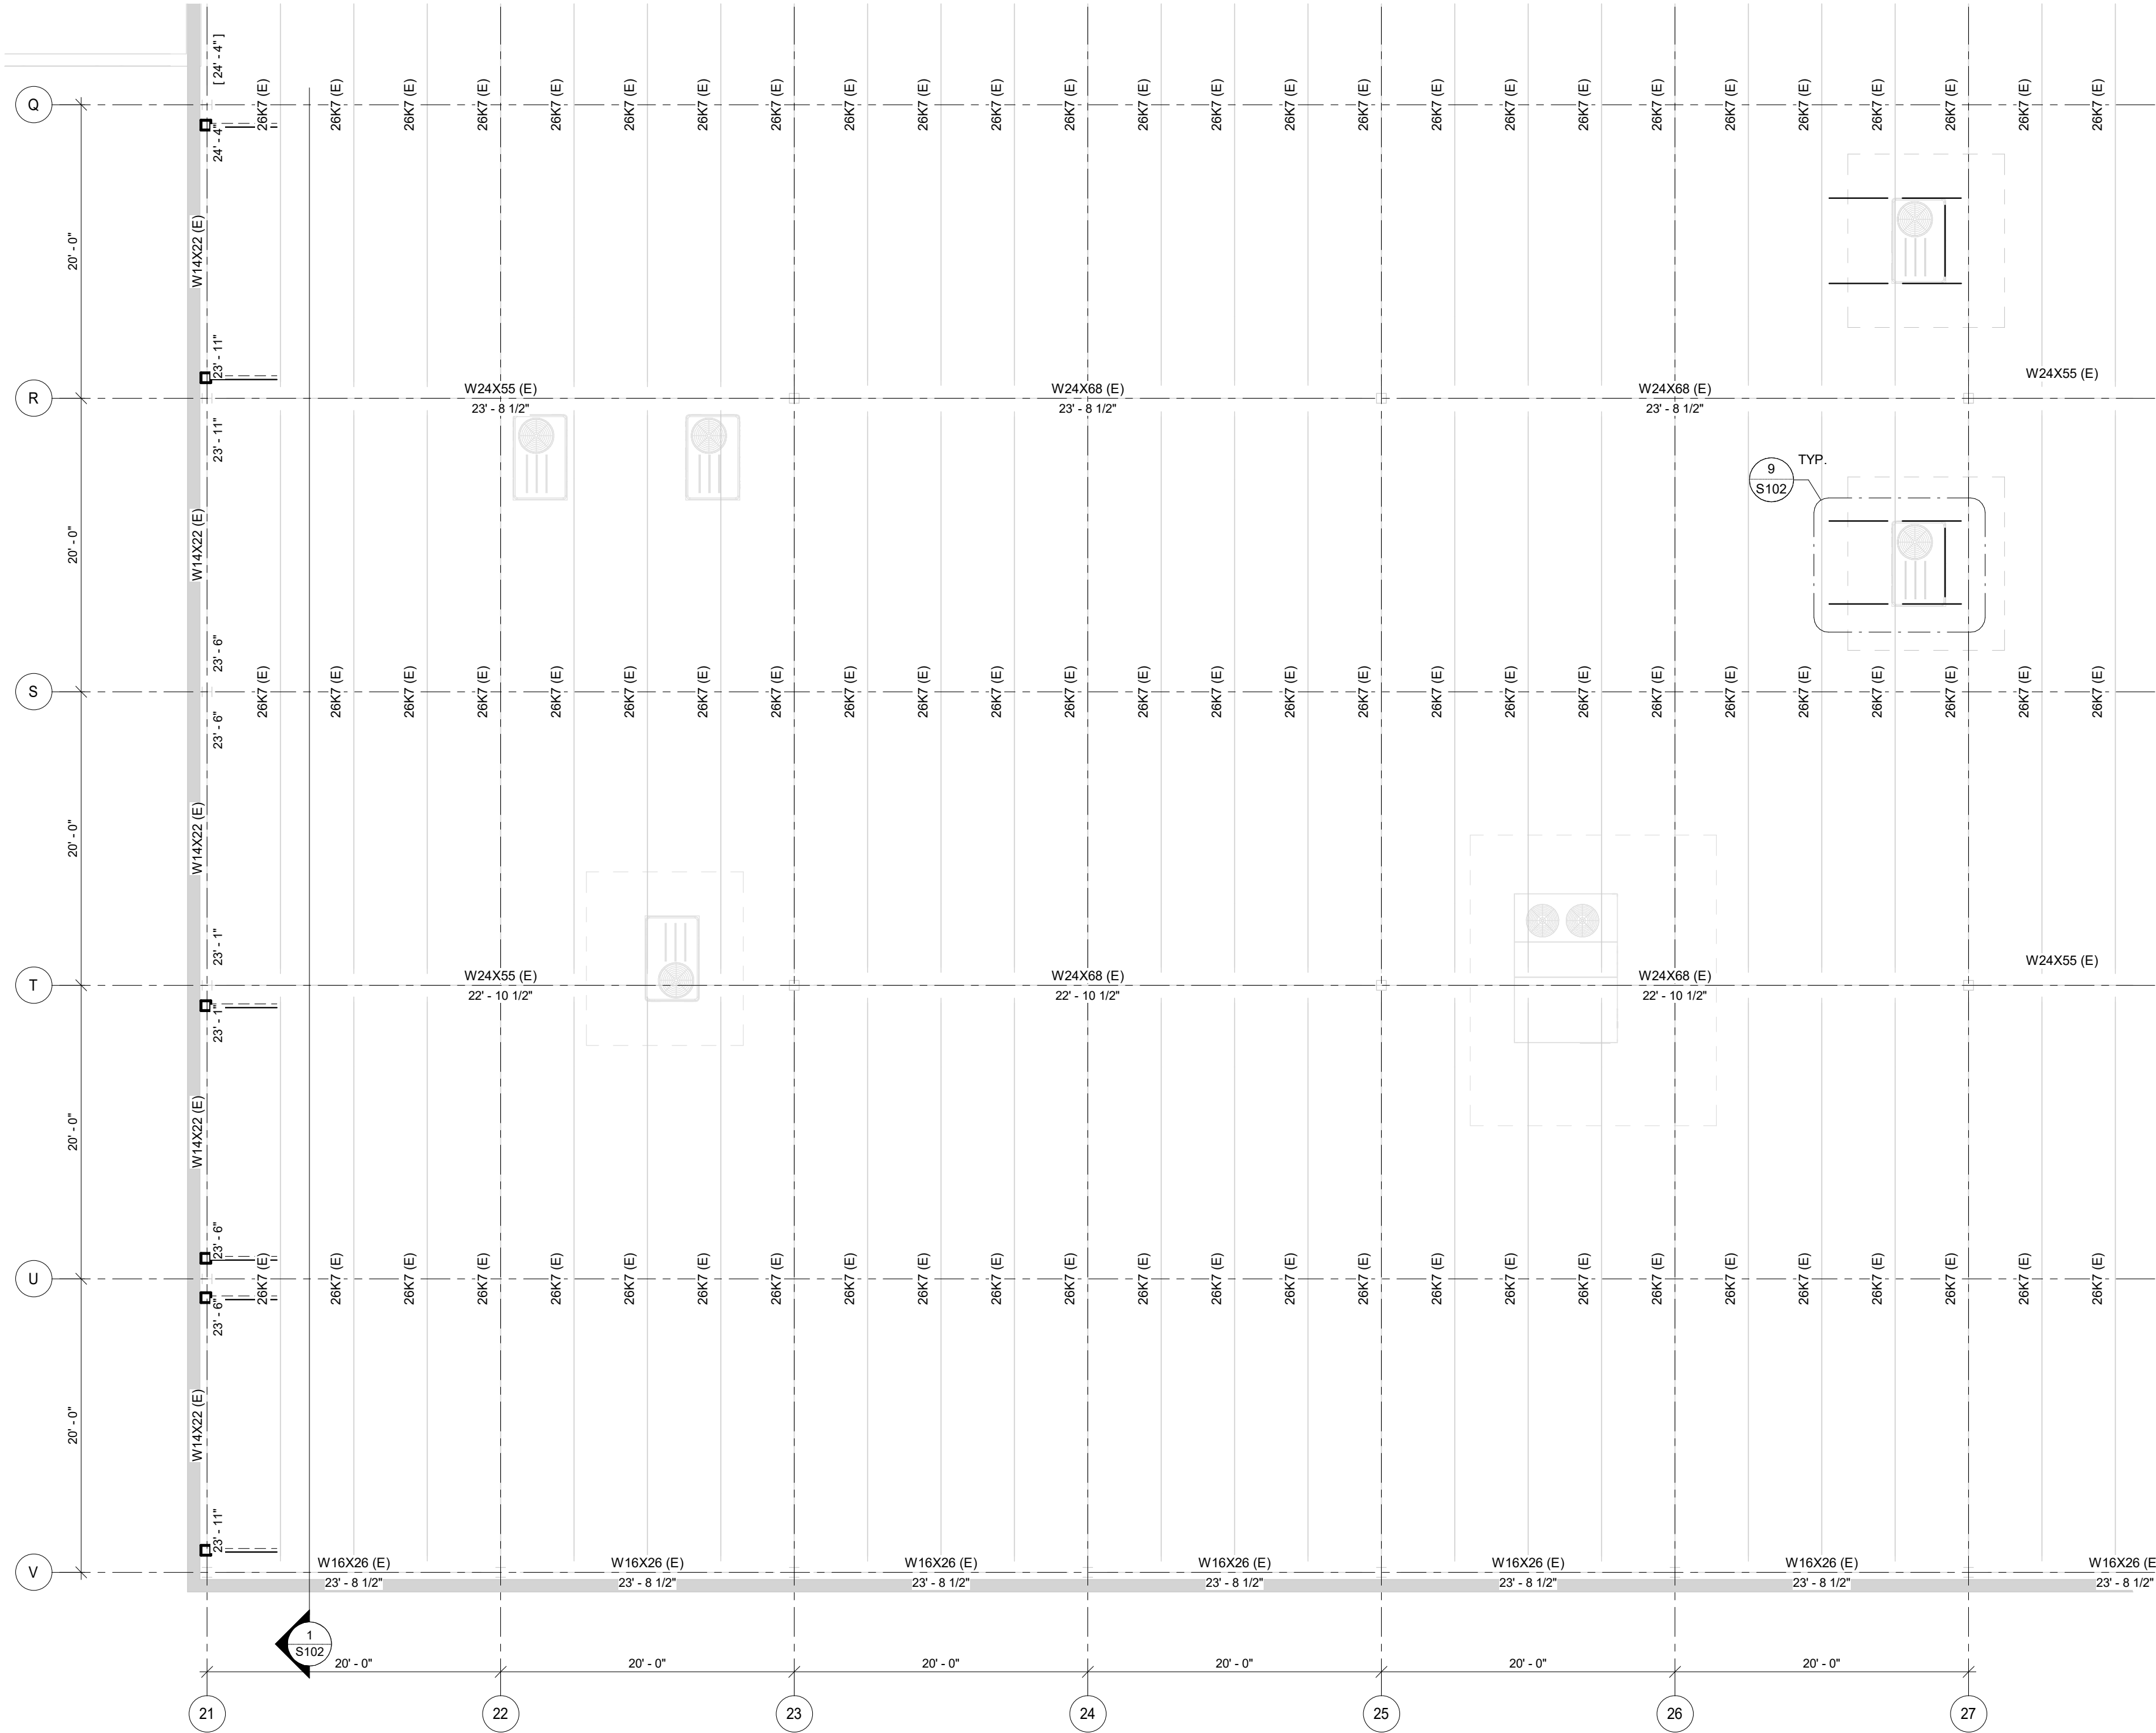
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A

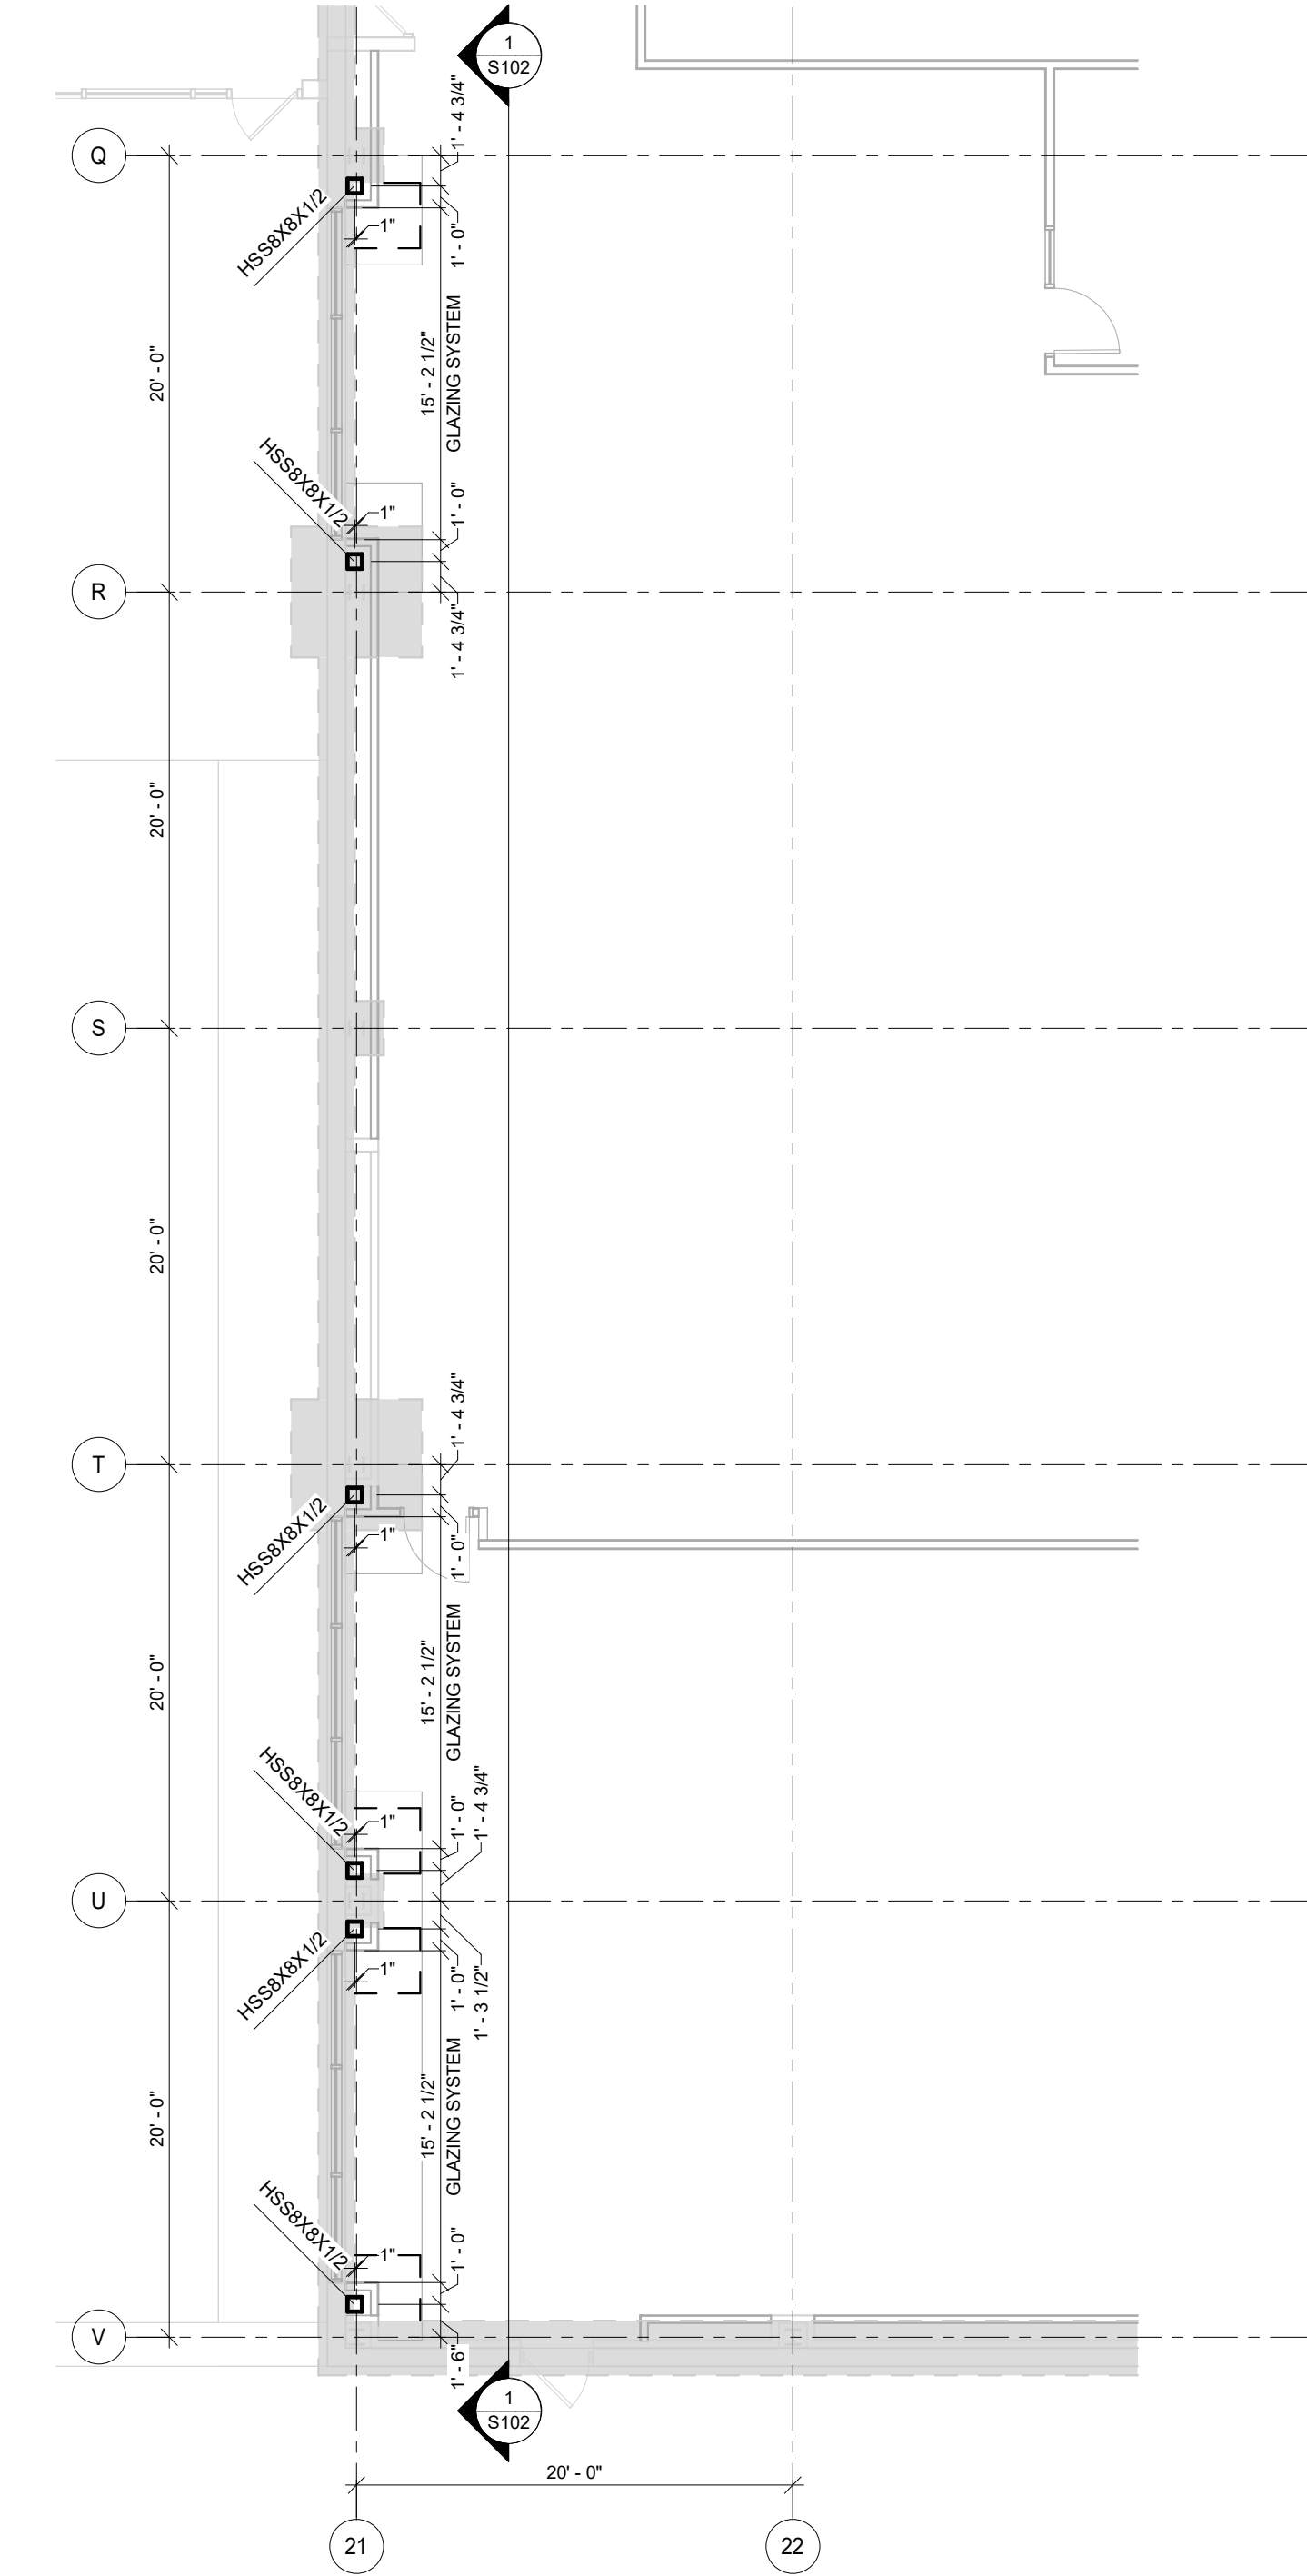

A FOUNDATION PLAN
1/8" = 1'-0"

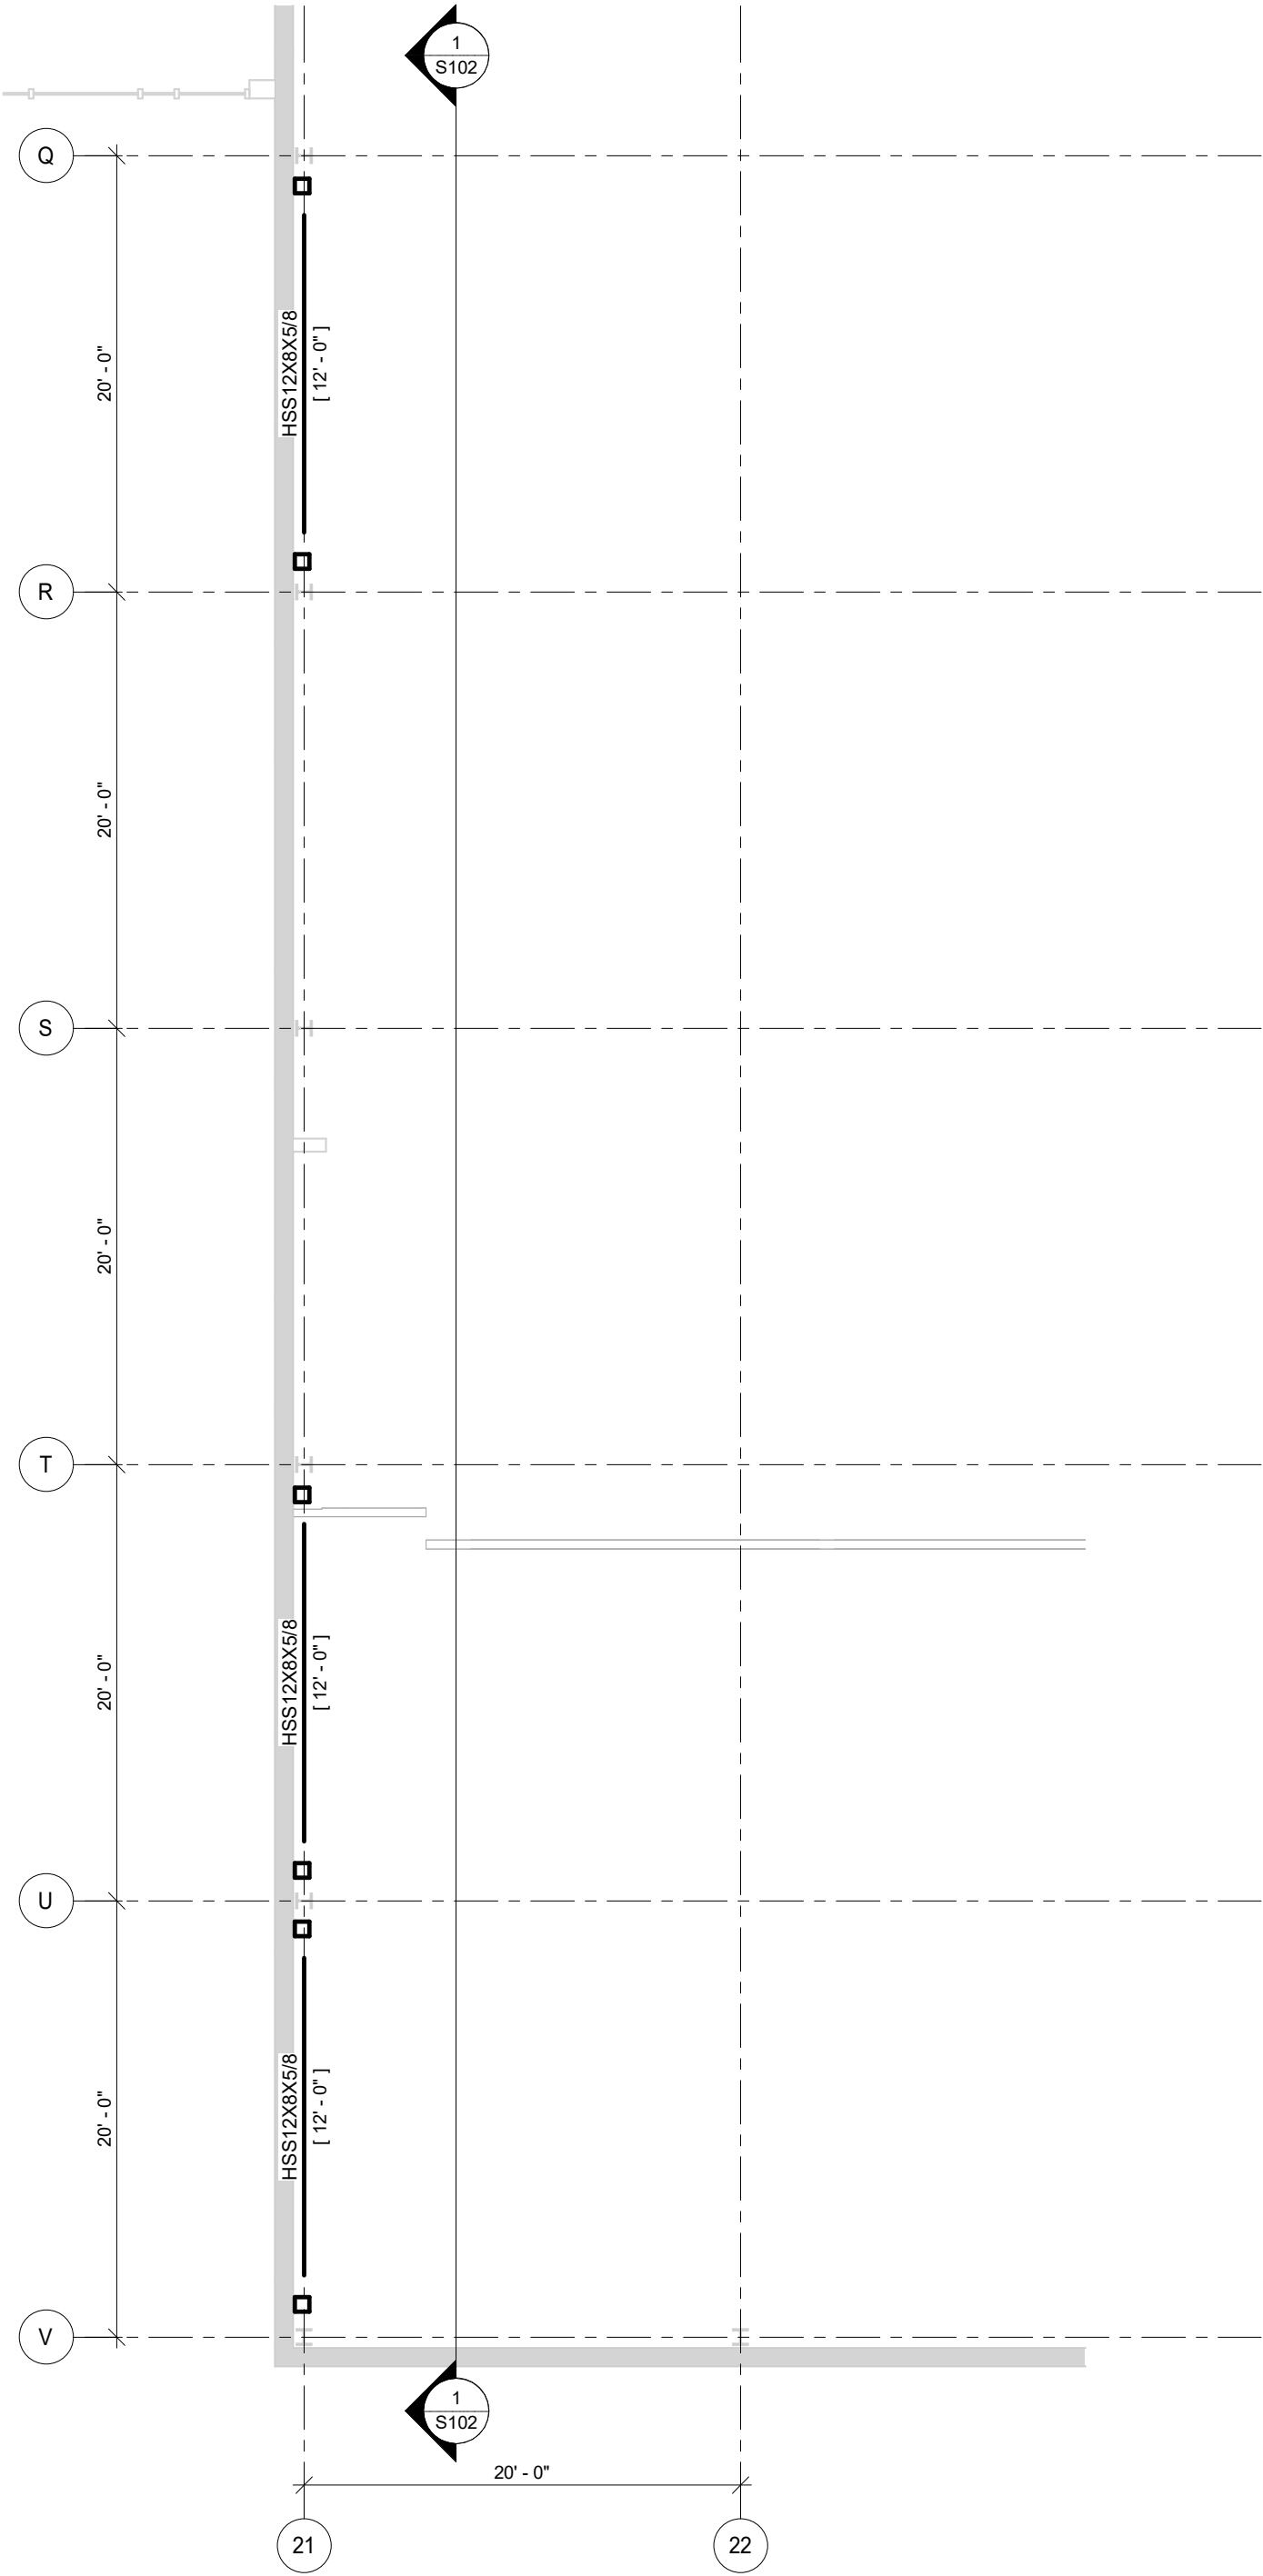

B WINDOW HEAD FRAMING PLAN
1/8" = 1'-0"



C WAREHOUSE ROOF FRAMING PLAN
1/8" = 1'-0"

OPNARCHITECTS

100 Court Ave., Suite 100
Des Moines, IA 50309
P: 515-309-0722
www.opnarchitects.com

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Owner

STATE OF IOWA - DEPARTMENT OF ADMINISTRATIVE SERVICES
1305 E WALNUT ST
DES MOINES, IA 50319

Project

9411.00 - DAS 6200 PARK ALI - WORKMAN'S CAMP RENOVATION
6200 PARK AVE
DES MOINES, IA 50321

Construction Manager

DCI GROUP
220 SE 6TH ST - SUITE 200
DES MOINES, IA 50309
P. 515-244-5043

Civil Engineer

CIVIL ENGINEERING CONSULTANTS
2400 86TH ST - UNIT 12
DES MOINES, IA 50322
P. 515-276-7084

Structural Engineer

RAKER RHODES ENGINEERING
4717 GRAND AVE
DES MOINES, IA 50312
P. 515-277-0275

Mechanical Engineer

KCL ENGINEERING
300 4TH ST
WEST DES MOINES, IA 50265
P. 515-724-7938

Electrical Engineer

KCL ENGINEERING
300 4TH ST
WEST DES MOINES, IA 50265
P. 515-724-7938

Key Plan

Revision	Description	Date
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OPN Project No.
24816000

Sheet Issue Date
100% CONSTRUCTION
DRAWING SET


08/16/24

Sheet Name
FOUNDATION AND FRAMING PLANS


Sheet Number

S101


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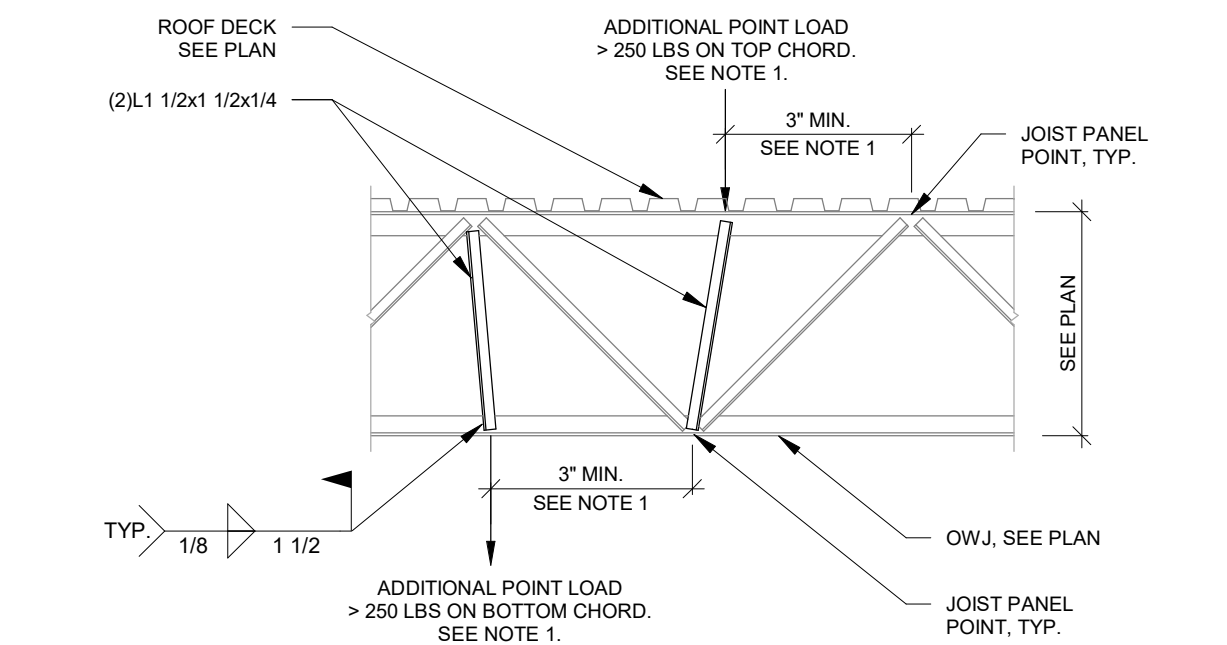
1 WALL FRAMING ELEVATION
1/4" = 1'-0"

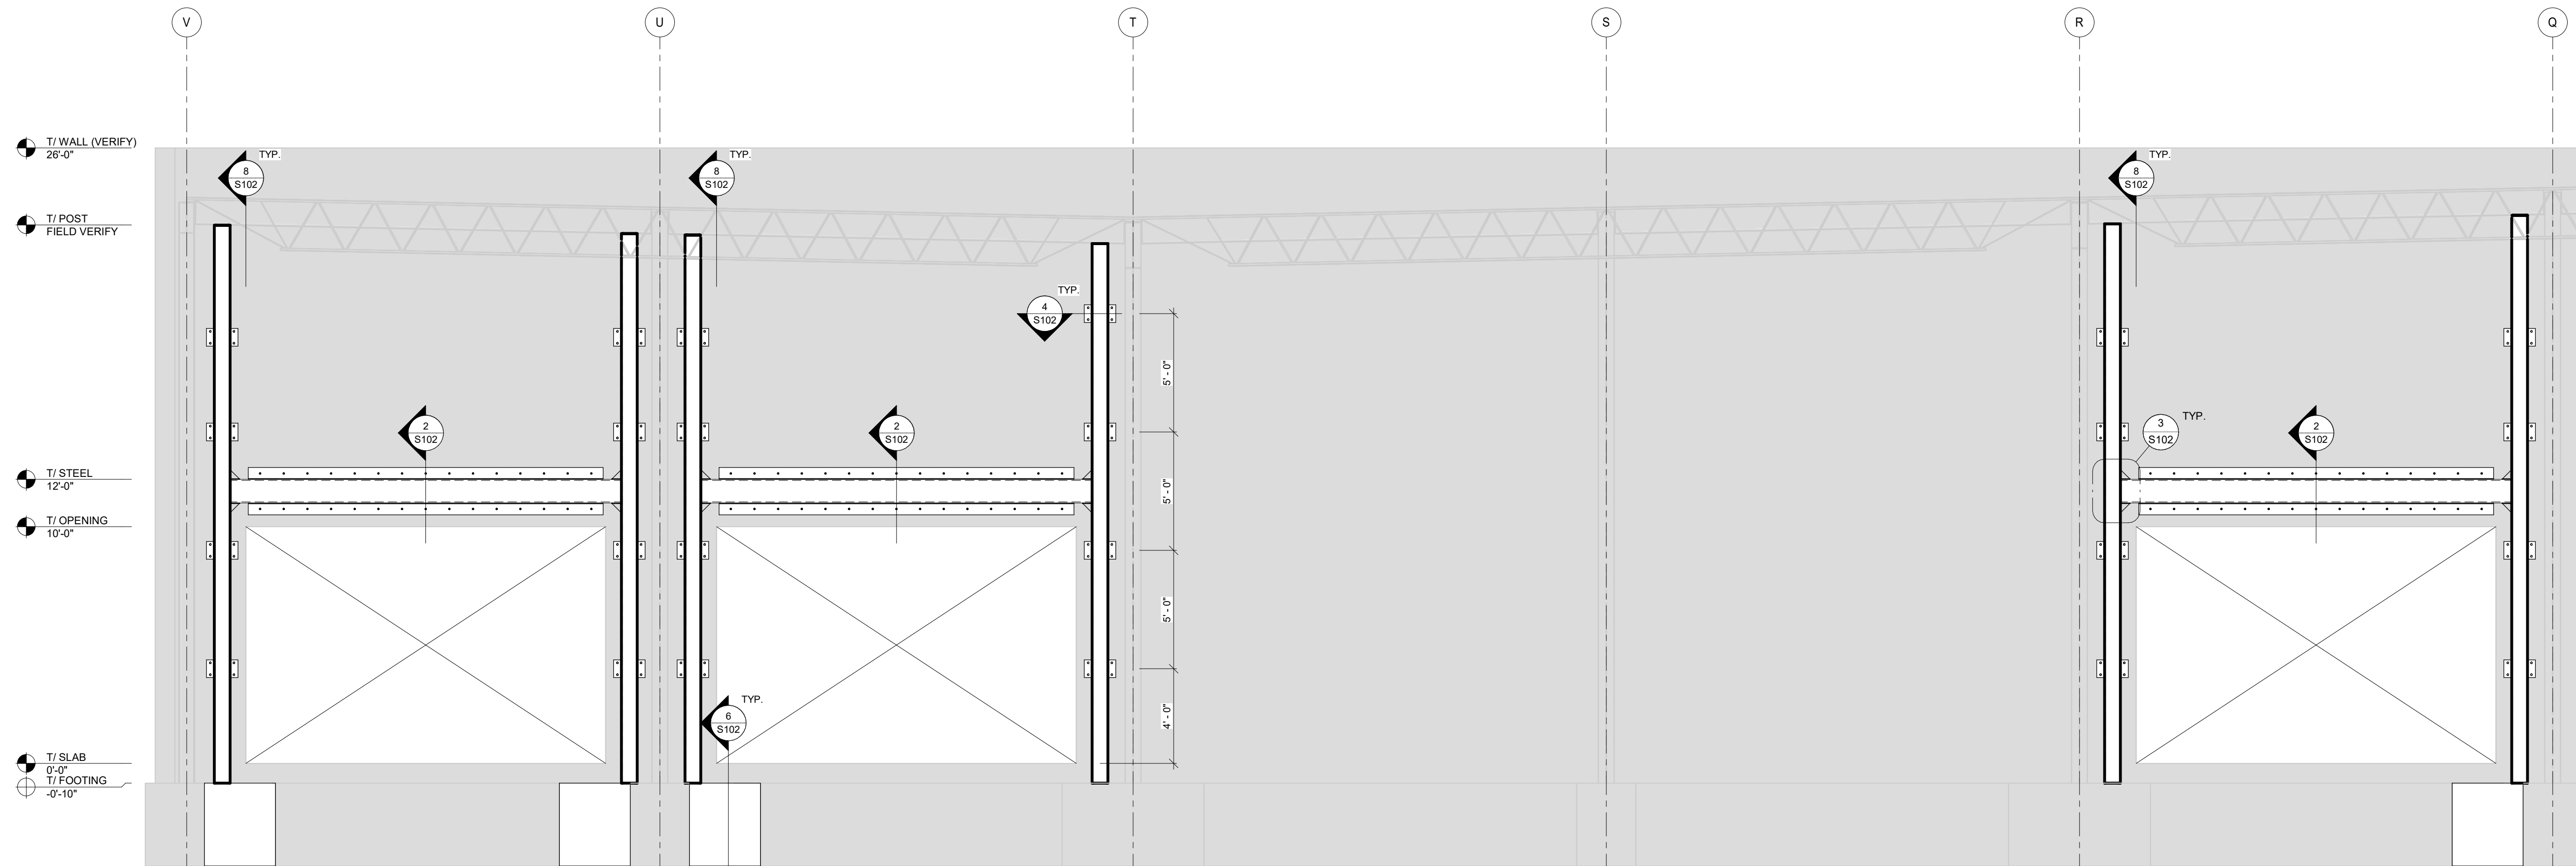

2 HEADER TO EXISTING PRECAST DETAIL
1" = 1'-0"

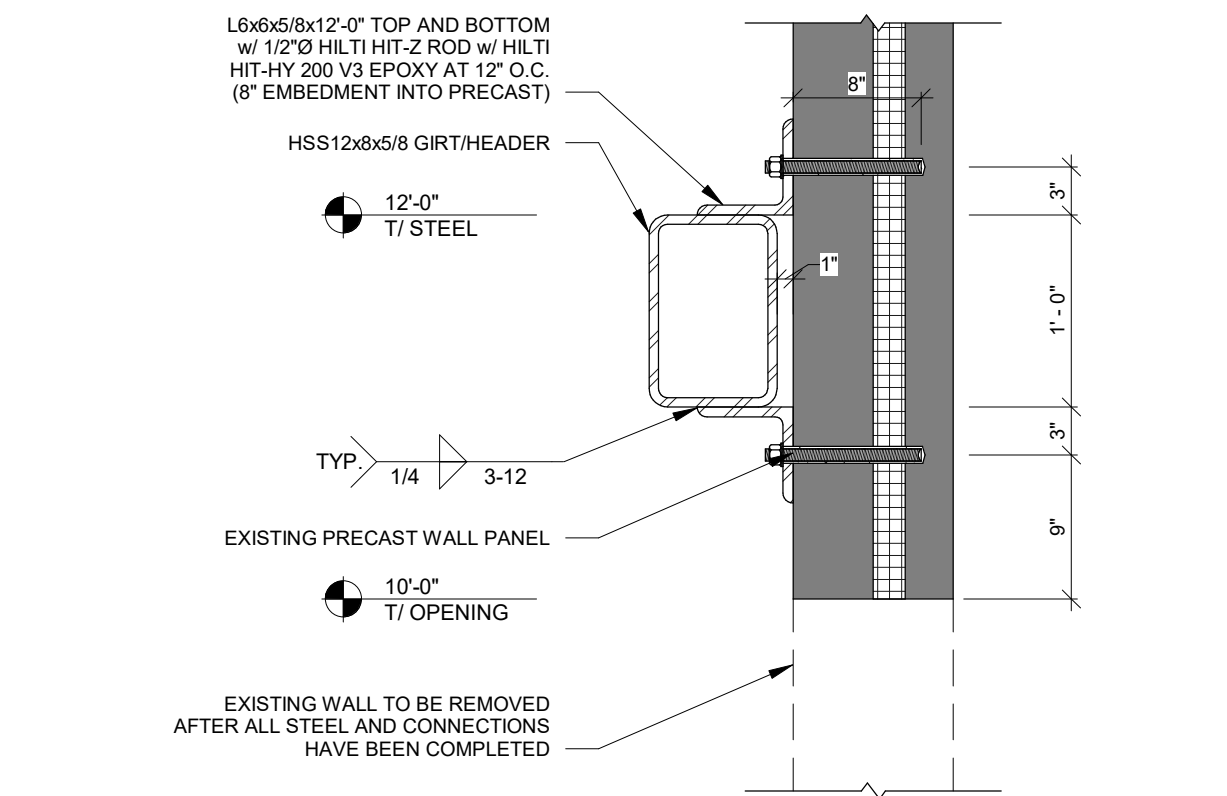


6 NEW FOOTING DETAIL
3/4" = 1'-0"

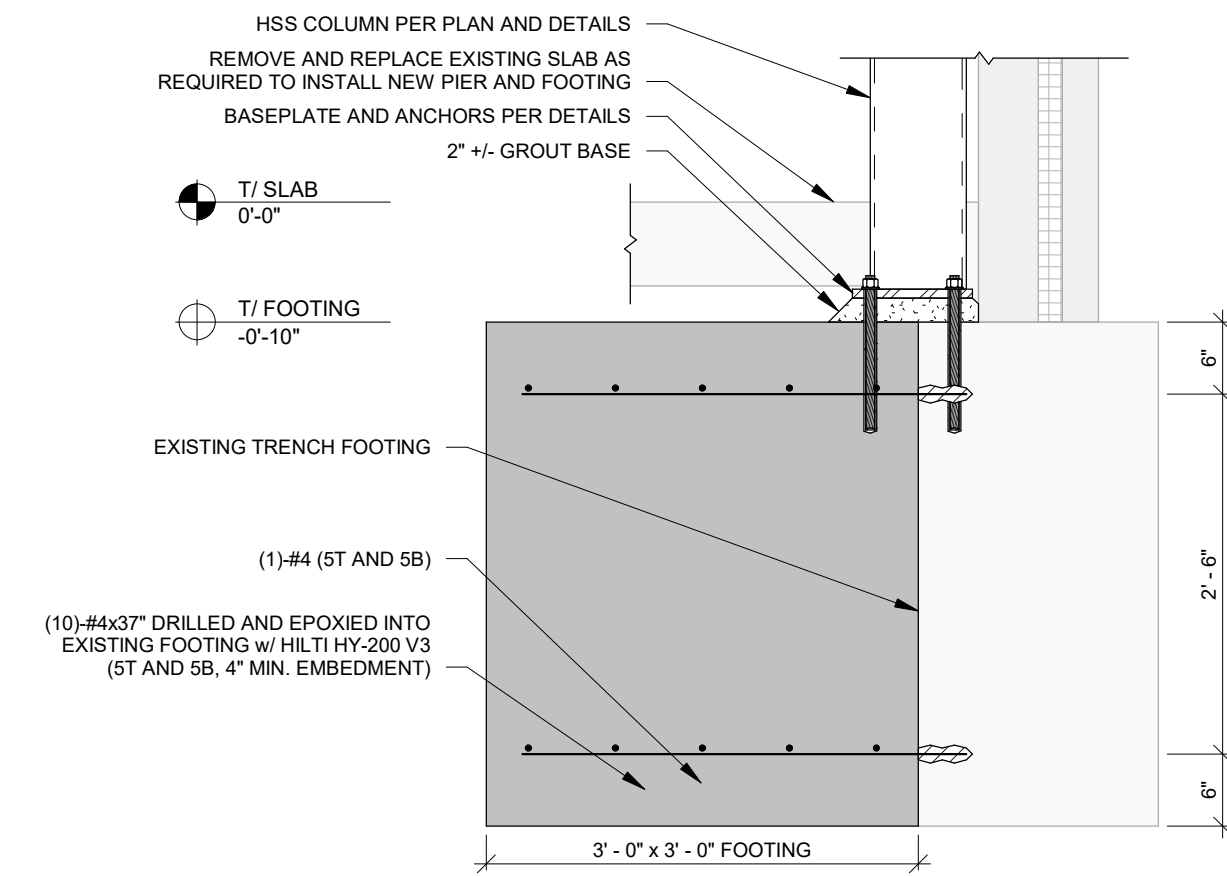

NOTES:
1. ADDITIONAL ANGLE STRUTS SHOWN SHALL BE PROVIDED @ ALL POINT LOADS GREATER THAN 250 LBS. OCCURRING @ A LOCATION GREATER THAN 3' AWAY FROM JOIST PANEL POINT.
2. CONTRACTOR TO FIELD VERIFY REQ'D LOCATIONS WITH FINAL WEB LAYOUT.

10 TYP. POINT LOAD @ OWJ
1/2" = 1'-0"

3 HEADER TO POST CONNECTION DETAIL
1" = 1'-0"

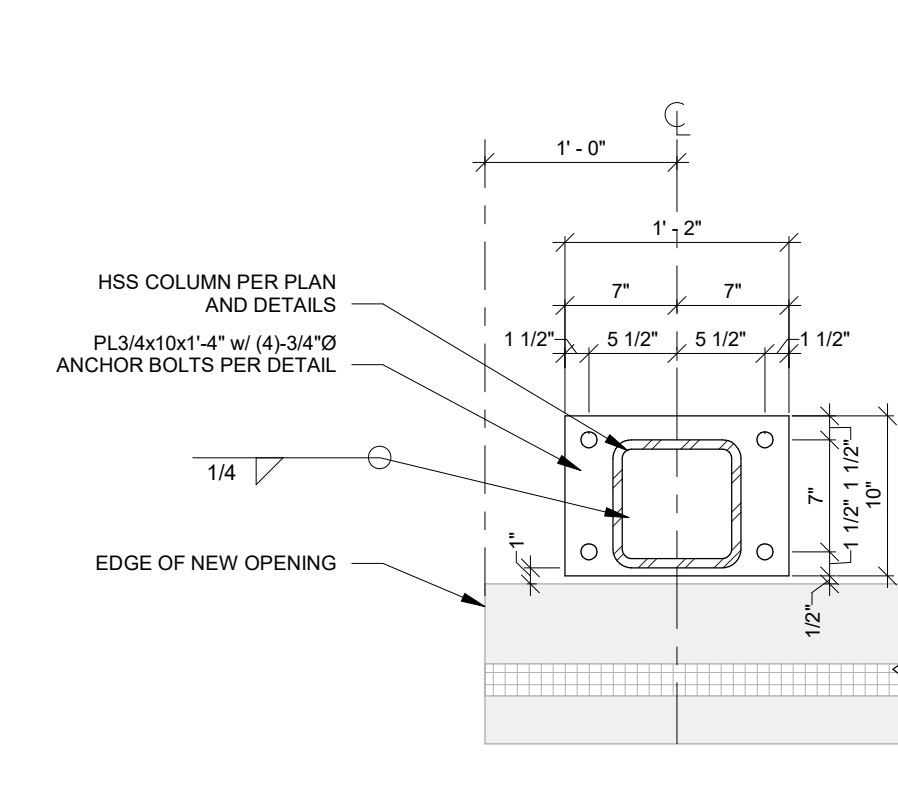


7 BASEPLATE DETAIL
1" = 1'-0"



NOTES:
1. SEE GENERAL STRUCTURAL NOTES FOR DECK WELDS TO ANGLES.
2. CONTRACTOR IS RESPONSIBLE TO COORDINATE LOCATION OF OPENINGS W/ MEP AND ARCH DRAWINGS

8 TWALL DETAIL
1" = 1'-0"

4 ANCHORAGE DETAIL
1" = 1'-0"

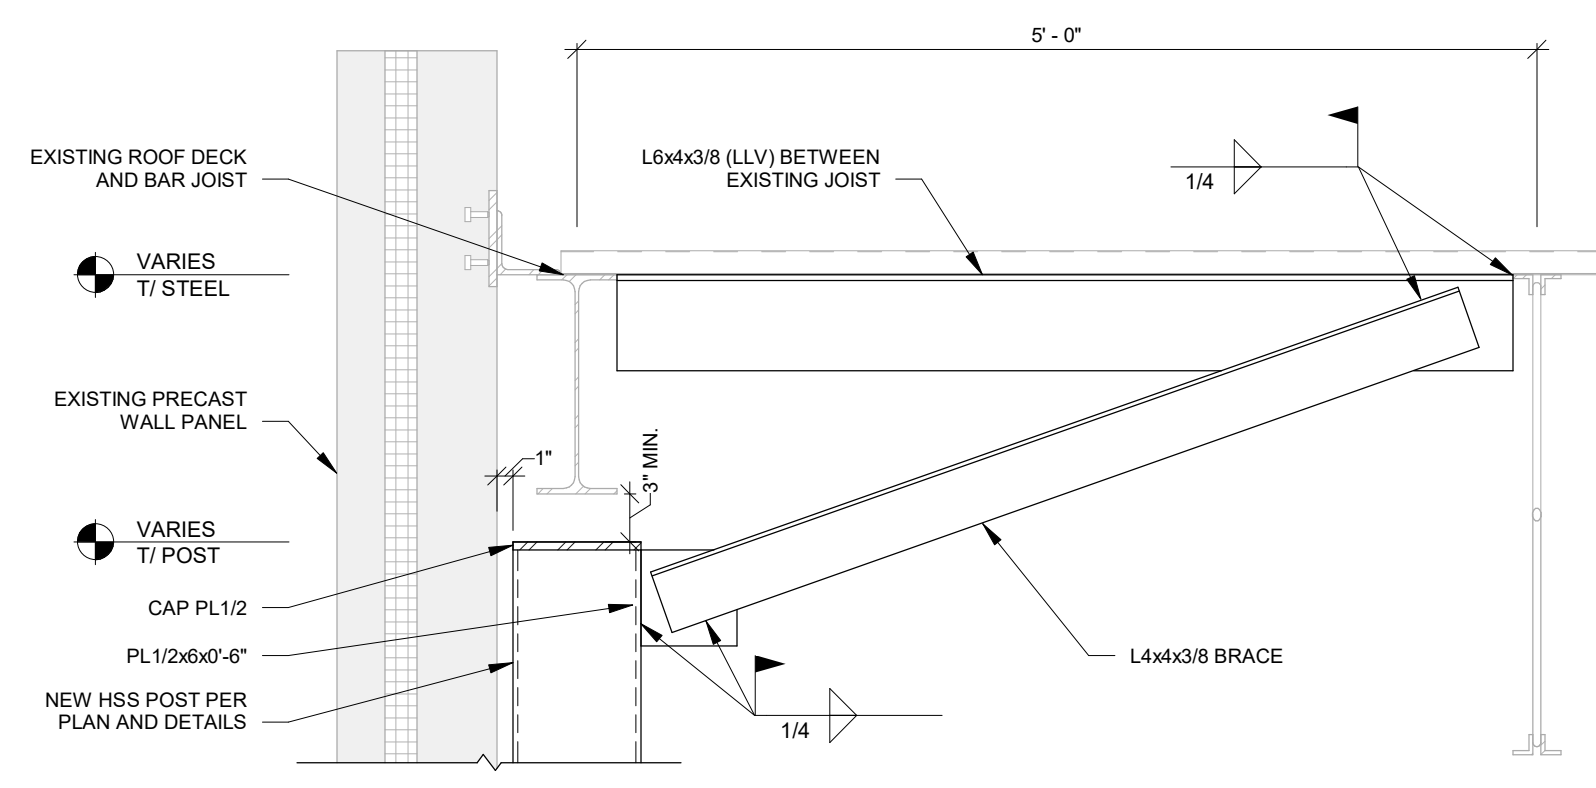


9 TYP. ANGLE FRAME
3/4" = 1'-0"




NOTES:
1. SEE GENERAL STRUCTURAL NOTES FOR DECK WELDS TO ANGLES.
2. CONTRACTOR IS RESPONSIBLE TO COORDINATE LOCATION OF OPENINGS W/ MEP AND ARCH DRAWINGS

5 TYP. ANCHOR ROD SETTING DETAIL (POST-INSTALLED)
3" = 1'-0"

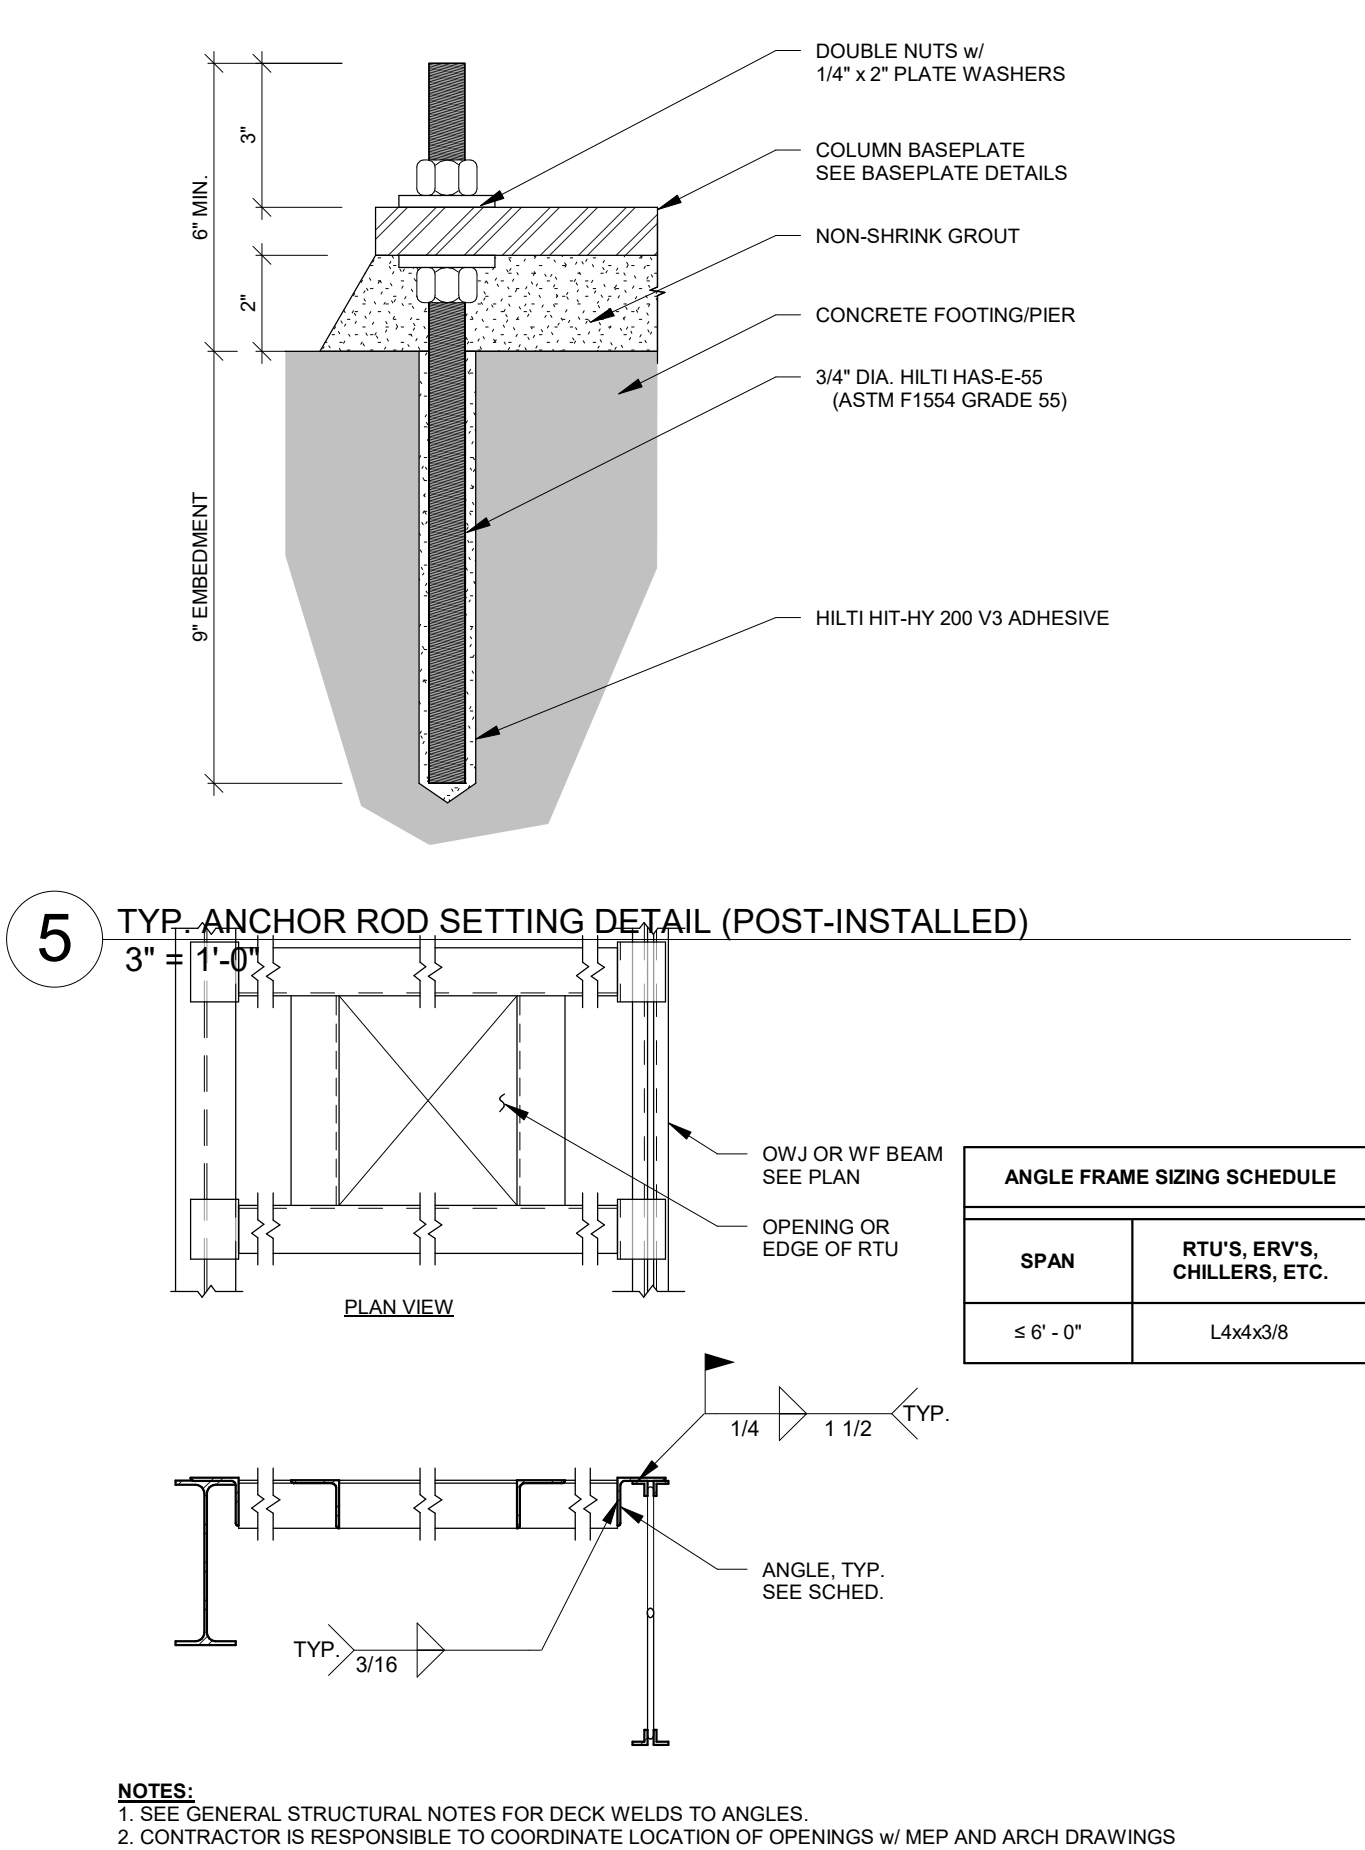

9 TYP. ANGLE FRAME
3/4" = 1'-0"

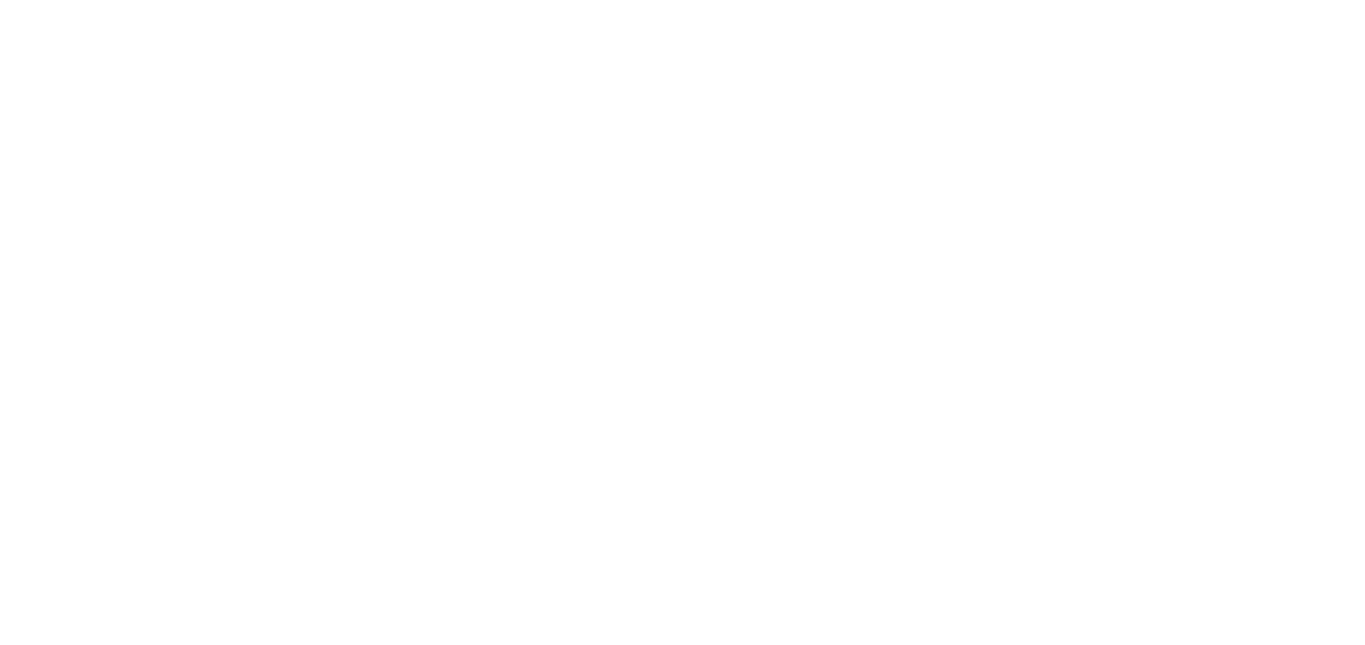

NOTES:
1. SEE GENERAL STRUCTURAL NOTES FOR DECK WELDS TO ANGLES.
2. CONTRACTOR IS RESPONSIBLE TO COORDINATE LOCATION OF OPENINGS W/ MEP AND ARCH DRAWINGS

5 TYP. ANCHOR ROD SETTING DETAIL (POST-INSTALLED)
3" = 1'-0"



OPNARCHITECTS

100 Court Ave., Suite 100
Des Moines, IA 50309
P: 515-309-0722
www.opnarchitects.com

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Owner

STATE OF IOWA - DEPARTMENT OF ADMINISTRATIVE SERVICES
1305 E WALNUT ST
DES MOINES, IA 50319

Project

9411.00 - DAS 6200 PARK ALI - WORKMAN'S CAMP RENOVATION
6200 PARK AVE
DES MOINES, IA 50321

Construction Manager

DCI GROUP
220 SE 6TH ST - SUITE 200
DES MOINES, IA 50309
P: 515-244-5043

Civil Engineer

CIVIL ENGINEERING CONSULTANTS
2400 86TH ST - UNIT 12
DES MOINES, IA 50322
P: 515-276-7084

Structural Engineer

RAKER RHODES ENGINEERING
4717 GRAND AVE
DES MOINES, IA 50312
P: 515-277-0275

Mechanical Engineer

KCL ENGINEERING
300 4TH ST
WEST DES MOINES, IA 50265
P: 515-724-7938

Electrical Engineer

KCL ENGINEERING
300 4TH ST
WEST DES MOINES, IA 50265
P: 515-724-7938

Key Plan

Revision

Description

Date

OPN Project No.

24816000

Sheet Issue Date

100% CONSTRUCTION

08/16/24

DRAWING SET

Sheet Name

STRUCTURAL DETAILS

Sheet Number

S102

INTERIOR FINISH SPECIFICATION

ACOUSTIC CEILING PANEL:

ACP-1/ACP-1.1/ACP-1.2
MANUFACTURER: ARMSTRONG
STYLE: LE TWA HANGARD PLUS
COLOR: WHITE
GRID: 1516
GRID COLOR: WHITE

BASE:

B8.1
MANUFACTURER: TARKETT
STYLE: TRACONAL
COLOR: 40 COVE
APPLICATION: 26 CHARCOAL WS WALL BASE

CARPET:

CPT-1
MANUFACTURER: MOHAWK
STYLE: WORMS PASS B7082
COLOR: 24 2 26
SIZE: 24' X 26'
INSTALLATION: OPEN OFFICES & RECEPTION

CORNER GUARD:

CG-1
MANUFACTURER: INFRO
STYLE: STAINLESS STEEL AS SPECIFIED IN SECTION 10 20 00
SIZE: 2" WINGS 4" HEIGHT
INSTALLATION: REFER TO FLOOR PLANS

COUNTERS/LAVATOIRES:

B8.1
MANUFACTURER: STARON
COLOR: ASPEN ALDER A4025
SIZE: 1/2"
APPLICATION: COUNTERTOPS AT RESTROOMS, KITCHENETTE, & DNR LAB

B8.2
MANUFACTURER: CORIAN
COLOR: CAMEL WHITE
APPLICATION: INTERNAL BOWLS

SHOUT:

B7.1
MANUFACTURER: BOETK
COLOR: DOLBYAN GRAY H10
APPLICATION: TO BE USED WITH T1 & T2

PAINT/EPoxy PAINT:

P1.1/EP1.1
MANUFACTURER: SHERWIN WILLIAMS
COLOR: SW 7028 KERSHARE GRAY
FINISH: EGGSHELL
APPLICATION: EPT-1 TYP. FIELD PAINT
EPT-1 TYP. RESTROOM FIELD PAINT

P1.2/EP1.2
MANUFACTURER: SHERWIN WILLIAMS
COLOR: SW 6026 TROPIC BLACK
FINISH: EGGSHELL
APPLICATION: EPT-2 MELLOW METAL DOORS AND FRAMES

P1.3
MANUFACTURER: SHERWIN WILLIAMS
COLOR: SW9009 EXTRA WHITE
FINISH: FLAT
APPLICATION: GYPSUM CEILINGS

P1.4
MANUFACTURER: SHERWIN WILLIAMS
COLOR: SW 9142 MOSCOW MIDNIGHT
FINISH: EGGSHELL
APPLICATION: ACCENT PANELS OPEN OFFICES & HEARING ROOMS

EP1.4
MANUFACTURER: SHERWIN WILLIAMS
COLOR: EGGSHELL
APPLICATION: MATCH EXISTING BUILDING EXTERIOR EXTERIOR FACE OF DOOR PANEL AND FRAME

PLASTIC LAMINATE:

PLAM-1
MANUFACTURER: PANOLAM BY NEVAMAR
TYPE: CALM DISTINCTION V4001
COLOR: ARP (T)
FINISH: CASEWORK AT KITCHENETTE, DNR LAB & LOBBY COUNTERTOP

TILE:

FIELD TILE (T-1)
MANUFACTURER: ANATOLIA
TYPE: FORM
COLOR: ICE
SIZE: 12" X 12"
FINISH: MATTE/NATURAL

ACCENT TILE (T-2)
MANUFACTURER: ANATOLIA
TYPE: GRANITE
COLOR: ICE
SIZE: 12" X 12"
FINISH: MATTE/NATURAL

TOILET PARTITIONS:

T1.1
MANUFACTURER: PANOLAM BY NEVAMAR
PRODUCT: TRIOLAM HIGH PRESSURE LAMINATES
MOUNTING: FLOOR ANCHORED/ OVERHEAD BRACED - GAP FREE
THICKNESS: 1/4"
COLOR: CALM DISTINCTION V4001
FINISH: ARP (T)

WINDOW TREATMENT:

WLT-1
MANUFACTURER: LUTROW
STYLE: MANUAL ROLLER SHADES
SHADE CLOTH: AERNEY'S SCREEN
COLOR: WHITE/FEAR
OPENNESS FACTOR: 3%

WELL:

WEL-1
MANUFACTURER: VT INDUSTRIES
WOOD: HONDENAS MAHOGANY
COLOR: TRIMMER
FINISH: TO MATCH EXISTING
APPLICATION: WOOD DOORS

ROOM FINISH SCHEDULE									
ROOM NUMBER	ROOM NAME	FLOOR		WALL FINISH				CEILING FINISH	REMARKS
		FINISH	BASE	NORTH	EAST	SOUTH	WEST		
003a	ELECTRIC	EXIST.	EXIST./RB-1	PT-1	EXIST.	EXIST.	EXIST./PT-1	EXIST.	1
150	RECEPTION	OPT-1	RB-1	PT-1	PT-1	PT-1	PT-1	ACP-1	
152	LOBBY	SC-2	RB-1	PT-1	PT-1	PT-1	PT-1	ACP-1	
B102	CORRIDOR	EXIST./SC-2	EXIST./RB-1	EXIST./PT-1	PT-1	EXIST./PT-1	EXIST./PT-1	EXIST./ACP-1	1, 2
B103	CORRIDOR	SC-2	RB-1	PT-1	PT-1	PT-1	PT-1	EXIST./ACP-1/PT-3	
B104	CORRIDOR	EXIST.	EXIST./RB-1	EXIST./PT-1	EXIST.	EXIST.	EXIST.	EXIST./ACP-1	1, 2
B119	SPRINKLER RISER	EXIST.	EXIST./RB-1	EXIST.	EXIST.	EXIST./PT-1	EXIST.	EXIST.	
B121	DNR LAB	SC-1	RB-1	EPT-1	EPT-1	EPT-1	EPT-1	ACP-1	
B123	WOMENS	T-1	T-1	T-1/T-2/EPT-1	T-1/T-2/EPT-1	T-1/T-2/EPT-1	T-1/T-2/EPT-1	ACP-1	1
B124	MENS	T-1	T-1	T-1/T-2/EPT-1	T-1/T-2/EPT-1	T-1/T-2/EPT-1	T-1/T-2/EPT-1	ACP-1	1
B125	STORAGE	SC-1	RB-1	PT-1	PT-1	PT-1	PT-1	OTS	
B126	RECEIVING/STORAGE ROOM	EXIST.	EXIST./RB-1	PT-1	EXIST.	EXIST.	EXIST.	EXIST./ACP-1	
B140	HEARING ROOM	CPT-2	RB-1	PT-1	PT-1	PT-1	PT-1	ACP-1	
B142	HEARING ROOM	CPT-2	RB-1	PT-1	PT-1	PT-1	PT-1	ACP-1	
B144	STORAGE	SC-1	RB-1	PT-1	PT-1	PT-1	PT-1	ACP-1	
B146	OFFICE	OPT-2	RB-1	PT-1	PT-1	PT-1	PT-1	ACP-1	
B148	STORAGE	EXIST.	RB-1	PT-1	PT-1	PT-1	PT-1	ACP-1	
B150	ALL OFFICE	CPT-1	RB-1	PT-1	PT-1/PT-4	PT-4	PT-1	ACP-1	1
B152	OFFICE	CPT-2	RB-1	PT-1	PT-1	PT-1	PT-1	ACP-1	
B160	WRKRM. COMP. OFFICE	OPT-1	RB-1	PT-1/PT-4	PT-1	PT-1	PT-1/PT-4	EXIST./ACP-1	1
B162	STORAGE	EXIST.	RB-1	PT-1	PT-1	PT-1	PT-1	ACP-1	
B164	STORAGE	EXIST.	RB-1	PT-1	PT-1	PT-1	PT-1	ACP-1	


ROOM FINISH SCHEDULE REMARKS:

- MULTIPLE WALL FINISHES - REFER TO FLOOR PLAN AND ELEVATIONS FOR LOCATIONS.
- MULTIPLE WALL BASE FINISHES REFER TO ELEVATIONS FOR LOCATIONS.


NOTE:

- EXISTING CONCRETE. PROVIDE SEALED CONCRETE FINISH
- EXISTING CONCRETE. PROVIDE TRAFFIC COATING FINISH

FLOORING AS SPECIFIED

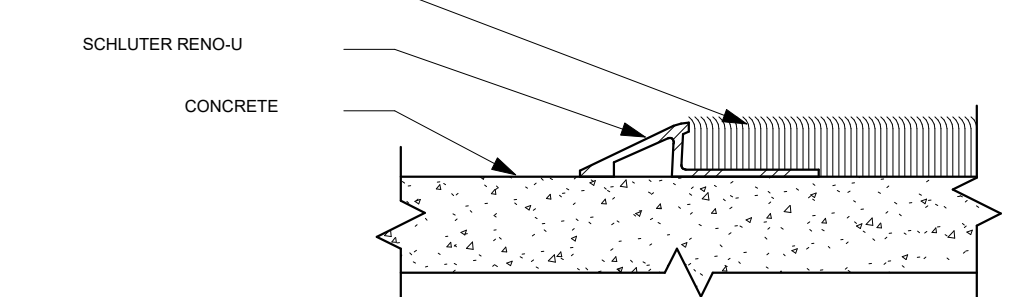

99 CARPET TO CONCRETE TRANSITION DETAIL
12" x 1'-0"

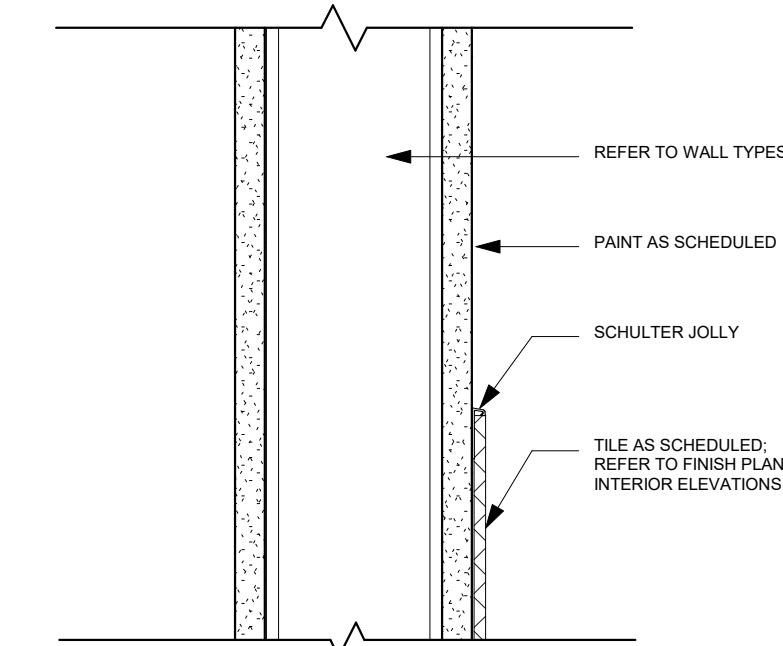

99 SCHLUTER TRIM
3" x 1'-0"


DOOR SCHEDULE

DOOR NUMBER	PANEL QUANTITY	PANEL TYPE	PANEL		PANEL MATERIAL	PANEL FINISH	FRAME		FIRE RATING	REMARKS	HARDWARE SET	NOTES
			WIDTH	HEIGHT			TYPE	MATERIAL				
B102-C	2	EXIST.	3'-0"	8'-0"	HM	EPT-2	EXIST.	HM	EPT-2	-	2	REMOTE RELEASE
B103	2	E NL	3'-0"	8'-0"	HM	EPT-2	1.0	HM	EPT-2	-	1,3	EX. DOOR 02
B103-C	1	NL	3'-0"	8'-0"	WD	WD-1	1.0	HM	EPT-2	-	1	
B103-D	1	NL	3'-0"	8'-0"	WD	WD-1	1.0	HM	EPT-2	-	1	
B104	2	E NL	3'-0"	8'-0"	HM	EPT-2	1.0	HM	EPT-2	-	1,3	EX. DOOR 04
B119	1	E F	3'-0"	7'-0"	HM	EPT-2	1.0	HM	EPT-2	-	3	EX. DOOR 08
B121	1	E NL	3'-0"	8'-0"	HM	EPT-2	1.0	HM	EPT-2	-	3	EX. DOOR 06
B123	1	E F	3'-0"	8'-0"	HM	EPT-2	1.0	HM	EPT-2	-	3	EX. DOOR 09
B124	1	E F	3'-0"	8'-0"	HM	EPT-2	1.0	HM	EPT-2	-	3	EX. DOOR 10
B125	2	E NL	3'-0"	8'-0"	HM	EPT-2	1.0	HM	EPT-2	-	3	EX. DOOR 12
B125-D	1	EXIST.	3'-0"	7'-0"	HM	EPT-6	1.0	HM	EPT-6	-	4	
B126-C	1	FG	3'-0"	7'-0"	ALUM	ANOD	1.0	ALUM	ANOD	-	1	
B130-A	2	EXIST.	3'-0"	8'-0"	HM	EPT-2	EXIST.	HM	EPT-2	-	1, 4, 5	EX. DOOR & HDW
B130-B	1	NL	3'-0"	8'-0"	WD	WD-1	1.0	HM	EPT-2	-	1	
B144	1	E NL	3'-0"	8'-0"	HM	EPT-2	1.0	HM	EPT-2	-	3	EX. DOOR 03
B146	1	F	3'-0"	7'-0"	WD	WD-1	2.0	HM	EPT-2	-		
B152	1	F	3'-0"	7'-0"	WD	WD-1	2.0	HM	EPT-2	-		
B160	1	NL	3'-0"	8'-0"	WD	WD-1	1.0	HM	EPT-2	-	1	
B160-A	1	NL	3'-0"	8'-0"	WD	WD-1	1.0	HM	EPT-2	-	1	
B160-B	2	EXIST.	3'-0"	8'-0"	HM	EPT-2	EXIST.	HM	EPT-2	-	4	EX. DOOR & HDW
B160-C	1	FL	3'-0"	8'-0"	WD	WD-1	1.0	HM	EPT-2	-		
B162	1	E NL	3'-0"	7'-0"	HM	EPT-2	1.0	HM	EPT-2	-	3	EX. DOOR 18
B164	1	E NL	3'-0"	7'-0"	HM	EPT-2	1.0	HM	EPT-2	-		


Grand total: 24

DOOR SCHEDULE REMARKS:

- CARD READER
- EXISTING DOOR TO RECEIVE NEW HARDWARE
- REINSTALL SALVAGED HW DOOR PANEL IN NEW FRAME AT NEW LOCATION
- EXISTING HARDWARE TO REMAIN
- REPROGRAM DOOR TO ACCEPT NEW CARD READER. COORDINATE W/ OWNER.

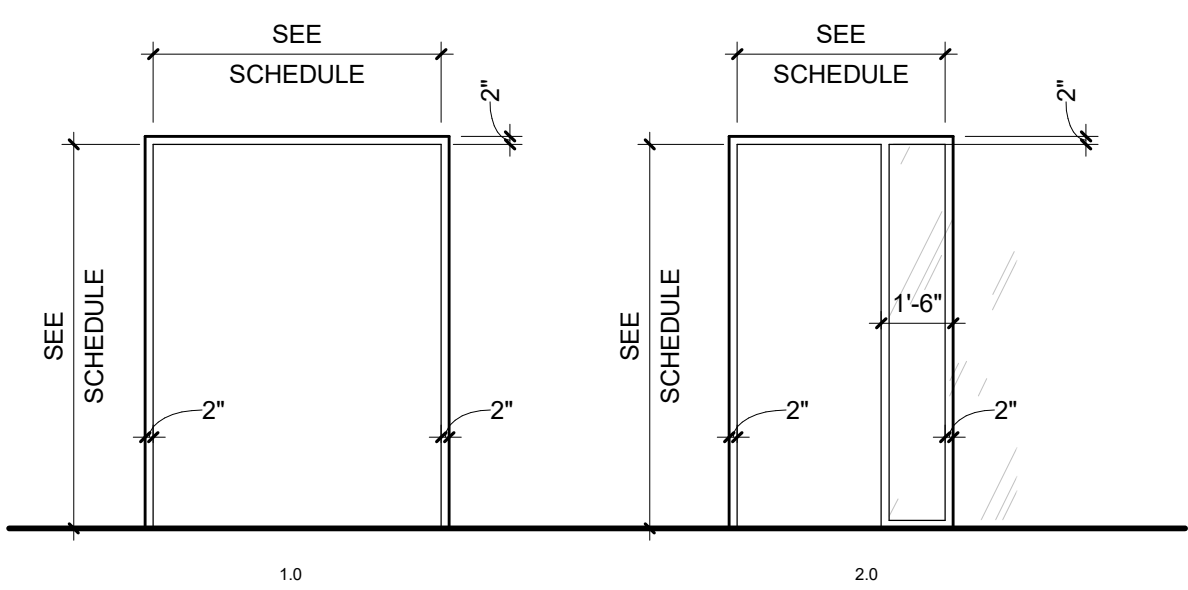

DOOR FRAME ELEVATIONS

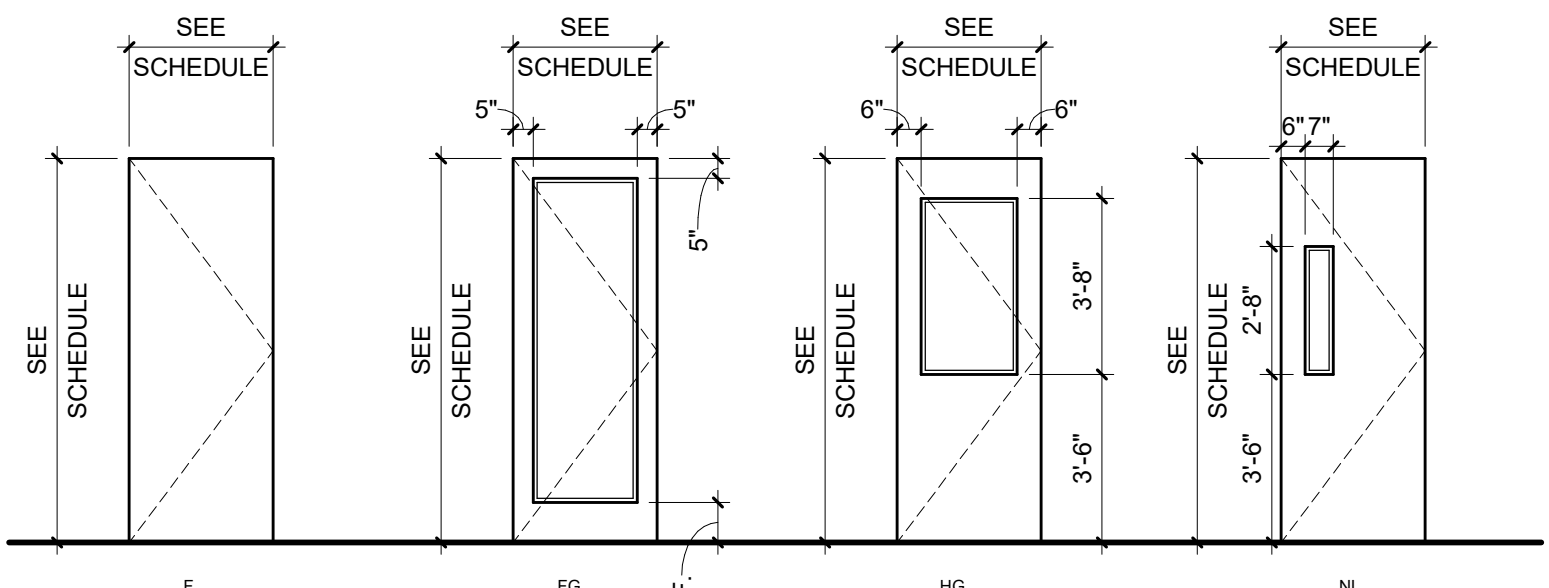

DOOR PANEL TYPES

DOOR & FRAME NOTES


- SALVAGE HW DOOR PANELS AT DOORS TO BE DEMOLISHED. TYP. NOTIFY ARCHITECT IF DOORS ARE NOT IN GOOD ENOUGH CONDITION FOR REUSE.
- REINSTALLATION: DELIVER SALVAGED DOOR PANELS TO OWNER.
- REINSTALLATION: DELIVER SALVAGED DOOR PANELS TO OWNER.
- REINSTALLATION: DELIVER SALVAGED DOOR PANELS TO OWNER.
- REINSTALLATION: DELIVER SALVAGED DOOR PANELS TO OWNER.

FINISH NOTES


- SCHLUTER EDGE TRIM TYP. AT ALL OUTSIDE CORNERS. JOINTS TO OCCUR AT UPPER MOST CONTIGUOUS GROUT LINE.
- SCHLUTER AT TOP OF TILE TO TRANSITION TO GYPSUM WALL BOARD.
- CENTER WALL TILE JOINT ON CENTER OF WALL.
- ALIGN ALL WALL TILE GROUT JOINTS WITH FLOOR TILE GROUT JOINTS.

STANDARD ABBREVIATIONS

- | | |
|------|------------------------|
| ACP | ACOUSTIC CEILING PANEL |
| CG | CORNER GUARD |
| CPT | CARPET |
| EPT | EPOXY PAINT |
| GT | GROUT |
| PNT | PAINT |
| PLAM | PLASTIC LAMINATE |
| RI | RESIDENT ROSE |
| SC | SEALED CONCRETE |
| SE | SEAL SURFACE |
| TERR | TERRAZZO |
| TIE | TIE |
| TP | TOILET PARTITION |
| VF | VINYL FLOORING |
| WD | WOOD |
| WT | WINDOW TREATMENT |

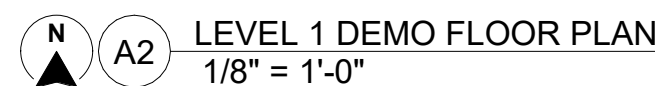

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 **A2** LEVEL 1 DEMO REFLECTED CEILING PLAN
1/8" = 1'-0"

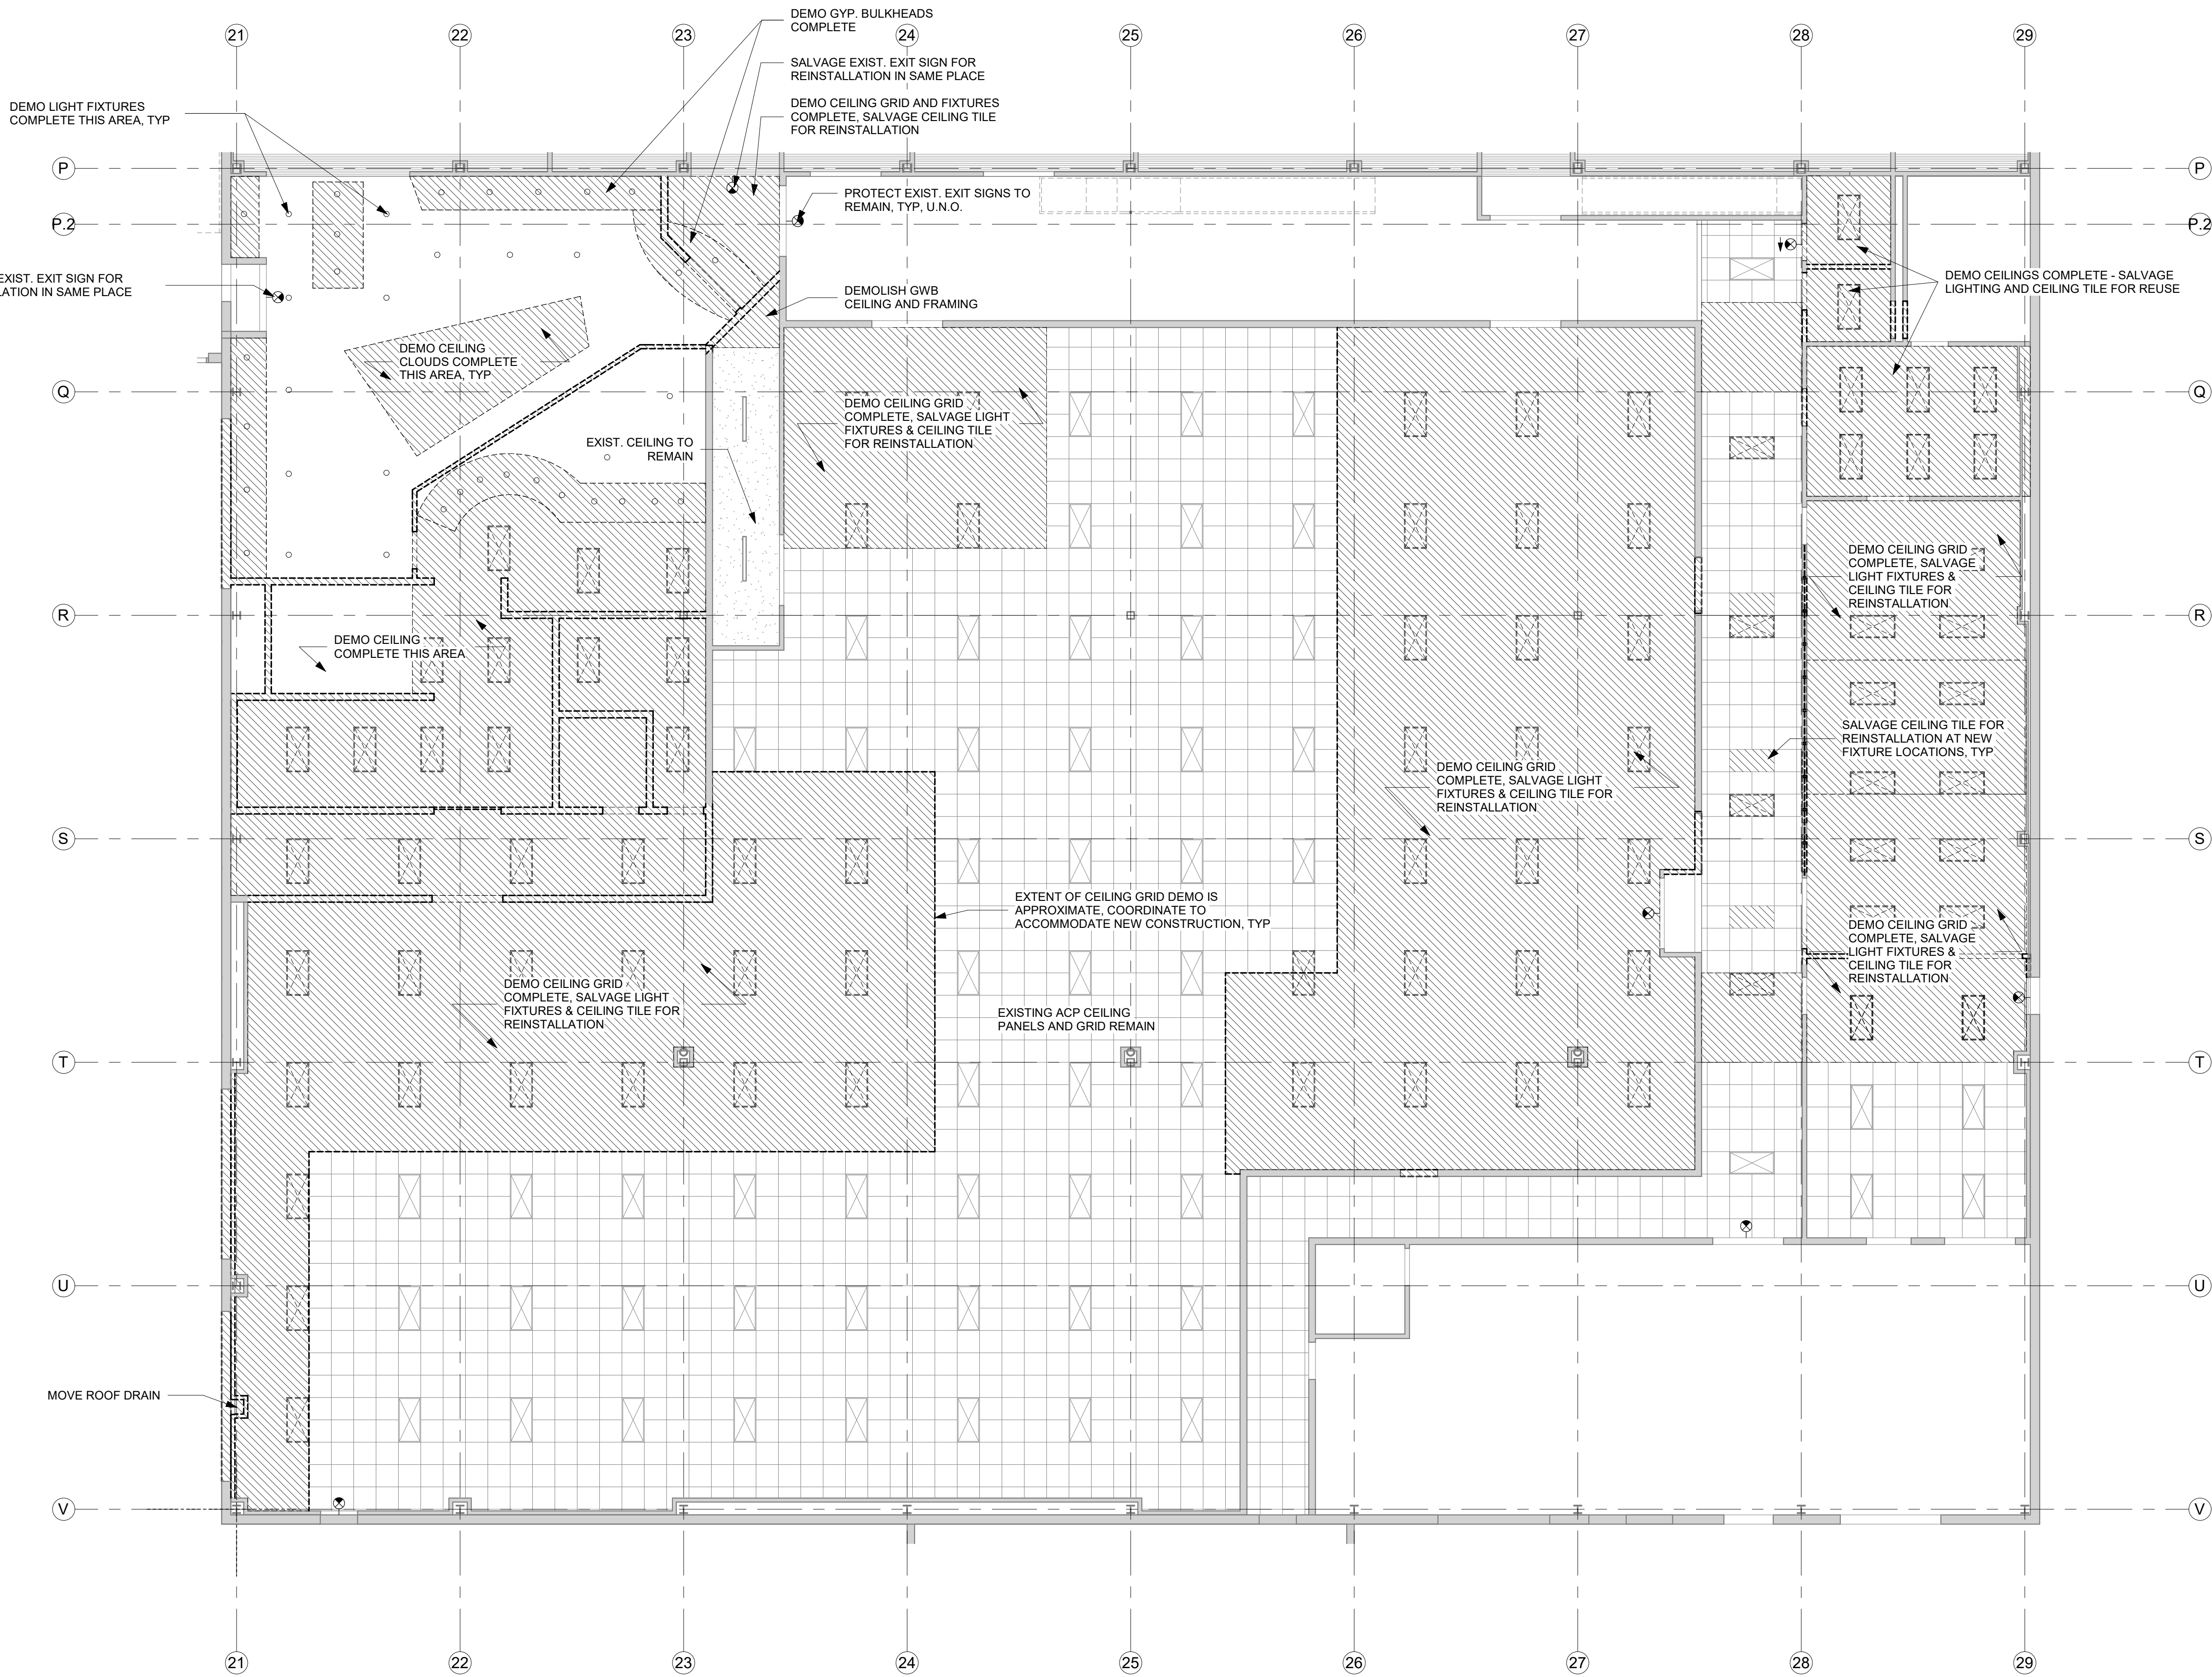GENERAL NOTES

1. REMOVE AND SALVAGE ALL CEILING TILE AND LIGHTING FIXTURES FOR REINSTALLATION UNLESS NOTED OTHERWISE
2. IDENTIFICATION AND/OR ABATEMENT OF HAZARDOUS MATERIALS IS NOT PART OF THIS SCOPE OF WORK. IF ASBESTOS OR OTHER HAZARDOUS MATERIALS ARE ENCOUNTERED, THE CONTRACTOR SHALL NOTIFY THE OWNER IMMEDIATELY.
3. REFER TO SPECIFICATION FOR RECYCLING, CONSTRUCTION WASTE MANAGEMENT AND DISPOSAL REQUIREMENTS.
4. REMOVE LOOSE PAINT AND MISCELLANEOUS HANGING OBJECTS FROM WALLS AND CEILINGS AT ALL AREAS TO RECEIVE NEW FINISHES.
5. OPENING IN THE EXISTING STRUCTURE SMALLER THAN 12" IN ANY DIRECTION ARE NOT IDENTIFIED ON THESE DRAWINGS. SUB-CONTRACTORS SHALL BE RESPONSIBLE FOR PROVIDING OPENINGS SMALLER THAN 12" AS REQUIRED FOR INSTALLATION OF THEIR WORK.
6. OPENINGS IN THE EXISTING STRUCTURE SHALL NOT BE MADE WITHOUT PRIOR APPROVAL OF THE STRUCTURAL ENGINEER.
7. PATCH ALL AREAS OF ELECTRICAL AND MECHANICAL DEMOLITION THAT WILL NOT BE REUSED.
8. CONTRACTOR TO FIELD VERIFY ALL EXISTING DIMENSIONS AND CONDITIONS. IN THE EVENT OF A DISCREPANCY BETWEEN THE DRAWINGS AND THE EXISTING CONDITIONS, NOTIFY THE ARCHITECT BEFORE PROCEEDING.
9. DO NOT REMOVE ANY ITEMS WHICH JEOPARDIZE THE STRUCTURAL INTEGRITY OF THE BUILDING. IF HIDDEN ELEMENTS OR DETERIORATED ELEMENTS ARE ENCOUNTERED, NOTIFY THE ARCHITECT IMMEDIATELY.
10. REFER TO CONSULTANT DRAWINGS FOR ADDITIONAL DEMOLITION OF OTHER DISCIPLINES.
11. PROTECT ALL ADJACENT AREAS AND ITEMS TO REMAIN DURING DEMOLITION/CONSTRUCTION. REPAIR/REPLACE ALL ITEMS DAMAGED DURING CONSTRUCTION.
12. EXISTING BUILDING CONDITIONS SHOWN ON THESE DRAWINGS ARE DERIVED FROM DRAWINGS OF THE ORIGINAL BUILDING AND FROM LIMITED FIELD OBSERVATION.
13. INDICATED EXISTING BUILDING CONDITIONS ARE ASSUMED TO BE REPRESENTATIVE OF THE ACTUAL CONSTRUCTION OF THE BUILDING. LOCAL CONDITIONS MAY VARY.



100 Court Ave., Suite 100
Des Moines, IA 50309
P: 515-309-0722
www.opnarchitects.com

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Key Plan

Revision	Description	Date
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OPN Project No.
24816000

Sheet Issue Date
100% CONSTRUCTION 08/16/2024
DRAWING SET

Sheet Name

DEMO REFLECTED CEILING PLANS

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R1 DEMO PHOTO 1

- EXIST. ACP CEILING PANELS AND GRID REMAIN - SEE RCP. SALVAGE ALL REMOVED TILES FOR REUSE AS NOTED. PROVIDE EXCESS TILES TO OWNER.
- EXIST. DOOR TO REMAIN
- REMOVE GWB AS NECESSARY FOR MODIFICATION OF EXTERIOR PRECAST WALL PANELS AND WINDOW INSTALLATION
- DEMO DRYWALL ENCLOSURE COMPLETE. RE-ROUTE EXISTING STORM DRAIN AS SHOWN ON DRAWINGS.
- DEMO EXIST. FLOOR FINISH COMPLETE & PREP CONCRETE FOR NEW FINISH



R10 DEMO PHOTO 6

- EXIST ACP TO REMAIN. SALVAGE LIGHT FIXTURES FOR REINSTALLATION - SEE RCP
- SALVAGE ACTUATOR AND REINSTALL AT SAME LOCATION AFTER NEW FINISHES IN HALLWAY.
- DEMO PLYWOOD WALL PANELS & CHECKER PLATE WALL PROTECTION COMPLETE. METAL FRAMING TO REMAIN - SEE DEMOLITION PLAN
- DEMO 2x WOOD WALL BASE
- EXIST. FLOOR TO REMAIN. PROTECT FROM DAMAGE



R18 DEMO PHOTO 11

- DEMO CEILING COMPLETE
- SALVAGE PAPER DISPENSER TO OWNER
- DEMO EXISTING DOOR AND FRAME COMPLETE - SALVAGE EXIST. DOOR FOR REUSE.
- DEMO CASEWORK COMPLETE
- DEMO EXIST. WALL COMPLETE
- KITCHEN EQUIPMENT REMOVED BY OWNER PRIOR TO CONSTRUCTION. ANY EXISTING UTILITIES TO BE CAPPED AND ABANDONED. TYP - SEE MEPT DRAWINGS



M1 DEMO PHOTO 2

- DEMO PORTION OF CEILING GRID COMPLETE. SALVAGE LIGHT FIXTURES & CEILING TILE FOR REINSTALLATION - SEE PLANS.
- EXIST. DOOR & ADA OPERATOR TO REMAIN
- SALVAGE AND REINSTALL ADA OPERATOR ON NEW WALL
- SALVAGE CHECKER PLATE WALL PROTECTION TO OWNER.
- SALVAGE FIRE EXTINGUISHER AND SIGNAGE FOR REINSTALLATION
- DEMO GWB THIS SIDE OF WALL FLOOR TO DECK AS INDICATED ON PLANS. METAL FRAMING TO REMAIN
- DEMO EXIST. FLOOR FINISH COMPLETE & PREP CONCRETE FOR NEW FINISH



M10 DEMO PHOTO 7

- SALVAGE RECESSED TRASH AND ELECTRIC HAND DRYER FOR REINSTALLATION IN NEW RESTROOMS - SEE PLANS.
- SALVAGE MIRROR TO OWNER
- REMOVE PLUMBING FIXTURES COMPLETE - SEE PLUMBING
- DEMO FRP WALL PROTECTION COMPLETE, TYP
- SALVAGE TOILET ROOM ACCESSORIES TO OWNER, TYP
- SALVAGE TOILET FIXTURE AND CARRIER COMPLETE FOR REINSTALLATION IN NEW RESTROOMS - SEE PLANS.
- FLOOR DRAIN - SEE PLUMBING



M18 DEMO PHOTO 12

- DEMO METAL WALL PROTECTION COMPLETE, TYP
- DEMO COOLER WALLS, DOOR, CEILING, DISPLAY AND ASSOCIATED ROOF CONDENSOR COMPLETE. PATCH ROOF AT REMOVED CONNECTION



H1 DEMO PHOTO 3

- DEMO CEILING GRID COMPLETE. LIGHTING TO REMAIN IN SIMILAR LOCATION. SALVAGE & PROTECT CEILING TILE FOR REINSTALLATION
- DEMO WINDOWS COMPLETE
- DEMO EXIST WALL BASE
- DEMO CPT COMPLETE, PREP FLOOR FOR NEW FINISH




H10 DEMO PHOTO 8

- DEMO EXIST. GWB CEILING COMPLETE.
- EXIST. WALL TO REMAIN
- DEMO EXIST. WALL COMPLETE - SEE DEMO PLANS.
- SALVAGE EXIST. DOOR
- DEMO CASEWORK COMPLETE



H18 DEMO PHOTO 13

- DEMO COOLER EQUIPMENT SEE MEPT DRAWINGS FOR UTILITY CONNECTIONS
- DEMO COOLER WALL PANELS / SYSTEM COMPLETE.
- DEMO RACKSYSTEM

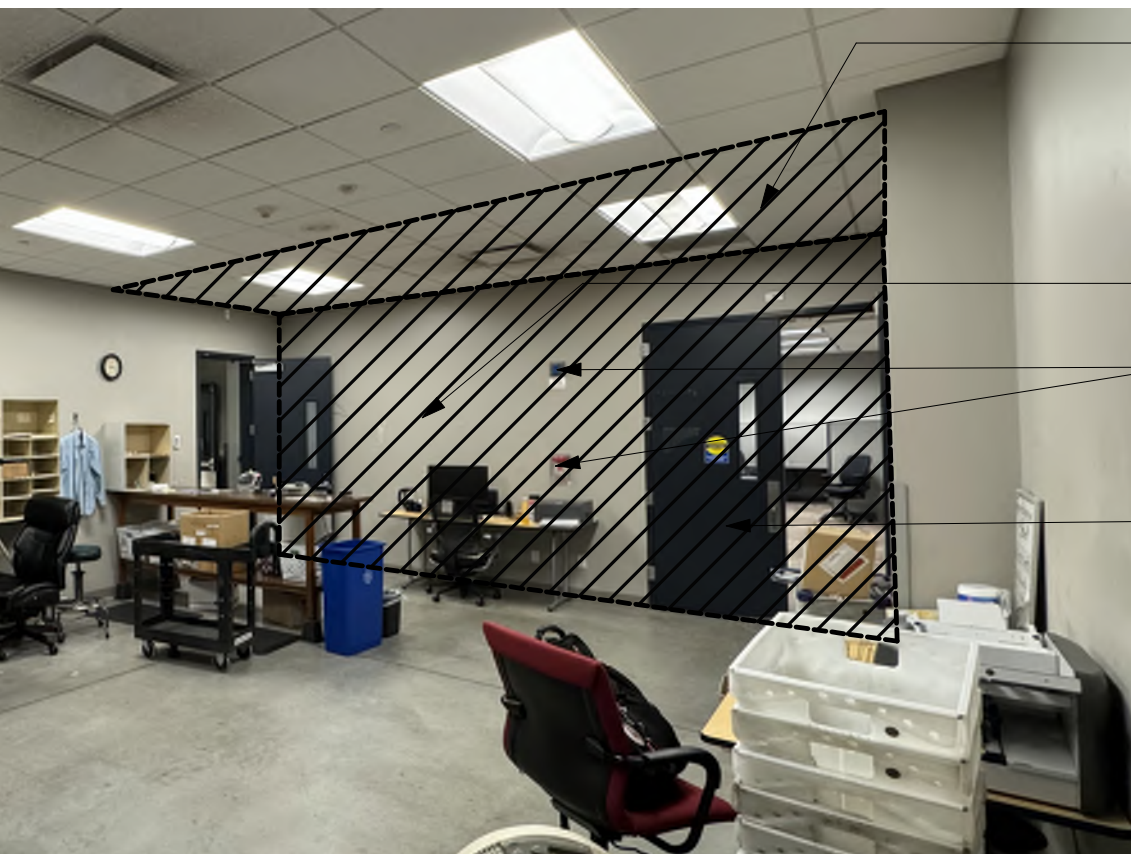

D1 DEMO PHOTO 4

- DEMO CEILING GRID COMPLETE. LIGHTING TO REMAIN IN SIMILAR LOCATION. SALVAGE & PROTECT CEILING TILE FOR REINSTALLATION
- DEMO EXIST. WALL
- DEMO MAIL ROOM ISOLATION SYSTEM COMPLETE. PROVIDE STAINLESS STEEL COVERS AT ALL ABANDONED BOXES.
- SALVAGE EXIST. DOOR, TYP



D10 DEMO PHOTO 9

- DEMO CEILING CLOUD & HARDWARE COMPLETE.
- EXIST. WALL & DOOR TO REMAIN
- SALVAGE PAPER DISPENSER TO OWNER
- DEMO COUNTERTOP AND METAL CASEWORK COMPLETE
- DEMO OVERHEAD COILING DOOR COMPLETE
- REMOVE STEEL FLOOR BOX COVERS AND PROVIDE FLUSH COVERS OR INFILL



D18 DEMO PHOTO 14

- DEMO FRP WALL PROTECTION COMPLETE, TYP
- SHELVING REMOVED BY OTHERS
- EYEWASH SYSTEM REMOVED BY OTHERS
- DEMO MOP SINK - SEE PLUMBING
- COUNTER AND SINK REMOVED BY OTHERS
- DEMO FLOOR SINK - SEE PLUMBING
- EXIST. FLOOR DRAIN - SEE PLUMBING



A1 DEMO PHOTO 5

- DEMO CEILINGS COMPLETE - SALVAGE LIGHTING AND CEILING TILE FOR REUSE
- SALVAGE PAPER & SOAP DISPENSER TO OWNER
- DEMO EXIST CASEWORK & PLUMBING COMPLETE
- SALVAGE EXIST. DOOR
- SALVAGE KEY CABINET TO OWNER
- DEMO CASEWORK COMPLETE



A10 DEMO PHOTO 10

- DEMO GWB CEILING
- DEMO WOOD CASEWORK COMPLETE
- DEMO FLOOR SINK AND INFILL FLOOR - SEE PLUMBING



A18 DEMO PHOTO 15

- SHELVING REMOVED BY OTHERS
- DEMO FRP WALL PROTECTION COMPLETE, TYP
- DEMO PLYWOOD SHEATHING
- COUNTER, SINK AND DISPOSAL REMOVED BY OTHERS
- DEMO FLOOR SINK - SEE PLUMBING

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P1 DEMO PHOTO 16
3" = 1'-0"



J1 DEMO PHOTO 17
3" = 1'-0"



E1 DEMO PHOTO 18
3" = 1'-0"



A1 DEMO PHOTO 19
3" = 1'-0"

DEMO OVERHEAD COILING DOOR, PREP
OPENING FOR NEW WALL INFILL

REPAIR WALL DAMAGE, PREP FOR NEW PAINT FINISH

DEMO OVERHEAD DOOR CONTROLS AND
JUNCTION BOX COMPLETE, PROVIDE NEW
COVERPLATE AT WALL

DEMO CONVEYING PLATFORM
COMPLETE, PATCH FLOORING AT
ANCHOR HOLES



P10 DEMO PHOTO 20
3" = 1'-0"



J10 DEMO PHOTO 21
3" = 1'-0"



E10 DEMO PHOTO 22
3" = 1'-0"



A10 DEMO PHOTO 23
3" = 1'-0"

DEMO MAIL ROOM ISOLATION SYSTEM
COMPLETE - SEE MECHANICAL

DEMO OVERHEAD COILING DOOR,
PREP OPENING FOR NEW WALL INFILL

DEMO DOOR BELL COMPLETE, PATCH
DRYWALL. CONTRACTOR TO ASSUME 15 TOTAL
LOCATIONS FOR SIMILAR PATCHING.

DEMOLISH SIGN AND INDICATOR COMPLETE,
PROVIDE COVER PLATE

PAINT WALL BELOW AND INCLUDING ACCENT STRIPE
(COLORS TO MATCH EXISTING) FOR THESE (3)
PRECAST PANELS.

DEMOLISH EXISTING DOOR AND FRAME, PREP
FOR NEW ALUMINUM ENTRANCE DOOR

DEMOLISH SIDEWALK COMPLETE, SEE
CIVIL DRAWINGS FOR SCOPE

DEMOLISH SIDE WALK COMPLETE, PREP FOR
NEW CONCRETE - SEE CIVIL DRAWINGS

EXISTING CONCRETE SIDEWALK TO REMAIN



R18 DEMO PHOTO 28
3" = 1'-0"



N18 DEMO PHOTO 27
3" = 1'-0"



J18 DEMO PHOTO 26
3" = 1'-0"



E18 DEMO PHOTO 25
3" = 1'-0"



A18 DEMO PHOTO 24
3" = 1'-0"

APPROXIMATE LOCATIONS OF NEW
ROOF MOUNTED RTU ON
PREMANUFACTURED CURBS.
COORDINATE LOCATIONS WITH
EXISTING STRUCTURAL - SEE
MECHANICAL.
COORDINATE ALL ROOF WORK FOR
CUTTING AND PATCHING WITH OWNERS
REPRESENTATIVE.
PROVIDE CRICKETING ON SIDES OF
UNITS AS REQUIRED TO MAINTAIN
WATER FLOW TO ROOF DRAINS
AROUND UNITS.

PAINT ENTIRE WALL THIS SIDE TO
CORNER AFTER NEW WINDOWS
INSTALLED. PAINT FROM BASE TO TOP
OF WINDOW / PRECAST JOINT.

SEE PLANS / ELEVATIONS FOR
REMOVED PORTION OF EXISTING
PRECAST PANELS FOR NEW WINDOW
OPENINGS. PROTECT ADJACENT
SERVICES FROM DAMAGE.

DEMO ROOF CONDENSOR
ASSOCIATED WITH WALK IN
COOLER COMPLETE. PATCH ALL
ROOF PENETRATIONS.

EXIST: SIGNAGE TO REMAIN

SALVAGE FIRE EXTINGUISHER
FOR REINSTALLATION

SALVAGE DRINKING FOUNTAIN
FOR REINSTALLATION

DEMO HM FRAME & GLAZING
COMPLETE

EXIST: BOLLARDS TO REMAIN

SALVAGE HM DOOR

DEMO PLYWOOD WALL
PROTECTION, METAL FRAMING
TO REMAIN

DEMO 2X12 WOOD WALL BASE
COMPLETE

PAINT WALL BELOW ACCENT STRIPE THIS
SIDE FROM CORNER TO JOINT NEAREST
FENCED ENCLOSURE.


PAINT ENTIRE WALL THIS SIDE TO CORNER
AFTER NEW WINDOWS INSTALLED. PAINT FROM
BASE TO TOP OF WINDOWS / PRECAST JOINT.

SEE PLANS / ELEVATIONS FOR REMOVED
PORTION OF EXISTING PRECAST PANELS FOR
NEW WINDOW OPENINGS. PROTECT ADJACENT
SERVICES FROM DAMAGE.

1. DIMENSIONS ARE MEASURED FACE-OF-FINISH TO FACE-OF-FINISH OR ROUGH MASONRY OPENING UNLESS NOTED OTHERWISE - TYPICAL FOR ALL DRAWINGS.
2. FIELD VERIFY ALL DIMENSIONS AND EXISTING CONDITIONS - TYPICAL FOR ALL DRAWINGS.
3. IN THE EVENT OF A DISCREPANCY BETWEEN ARCHITECTURAL AND CONSULTANT DRAWINGS, NOTIFY ARCHITECT IMMEDIATELY PRIOR TO COMMENCING WORK - TYPICAL FOR ALL DRAWINGS.
4. ALL PENETRATIONS IN FIRE RATED FLOORS AND WALLS MUST BE SEALED WITH APPROPRIATE FIRESTOPPING SYSTEM.
5. PATCH AND REPAIR EXISTING FLOOR SLABS AND WALL SURFACES.
6. ALL WORK FROM DEMOLITION OF ALL WALLS TO BE At 1 c UNLESS NOTED OTHERWISE.


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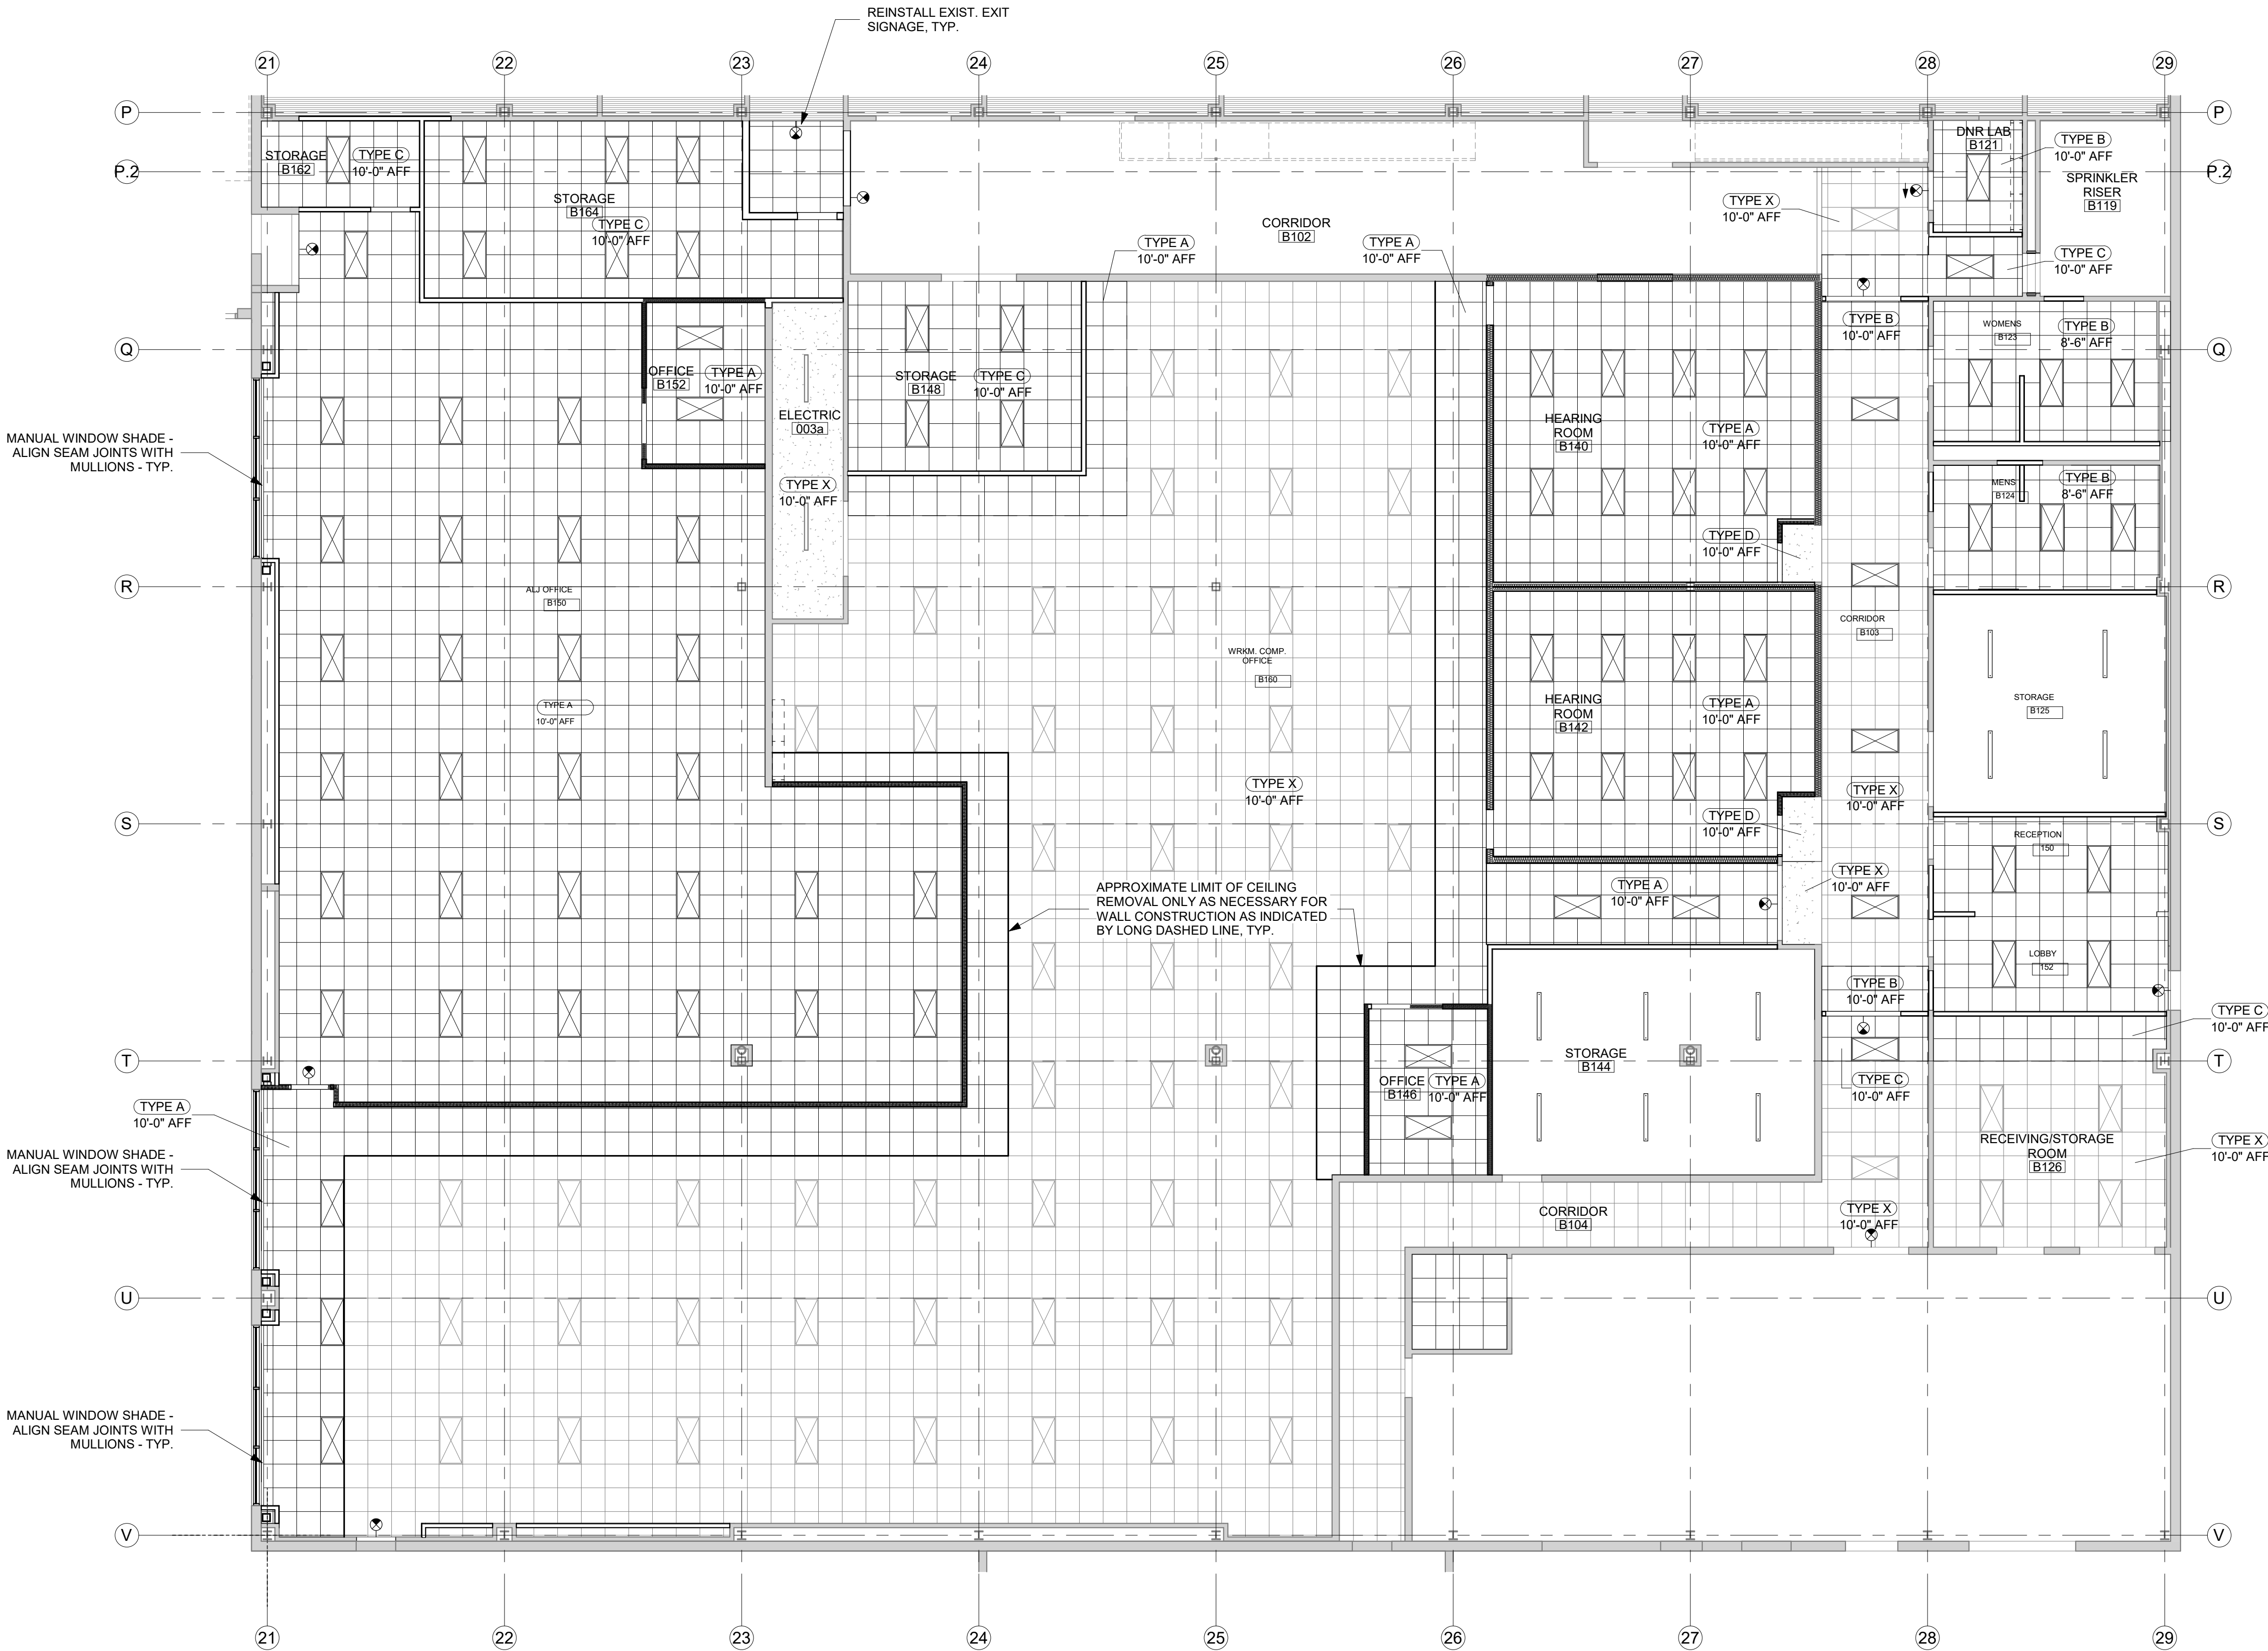
1. OFFICE AND MEETING ROOM WALLS TO BE SOUND RATED, TYP.
2. SEE SHEET A001 FOR ROOM FINISHED, TYP.
3. SALVAGED DOORS TO BE REINSTALLED AS APPLICABLE. EXISTING DOOR CONDITIONS AND SALVAGABILITY TO BE EVALUATED BY DESIGN TEAM.
4. ALL NEW WALLS AND FRAMING TO EXTEND TO 12" ABOVE CEILING, U.N.O.

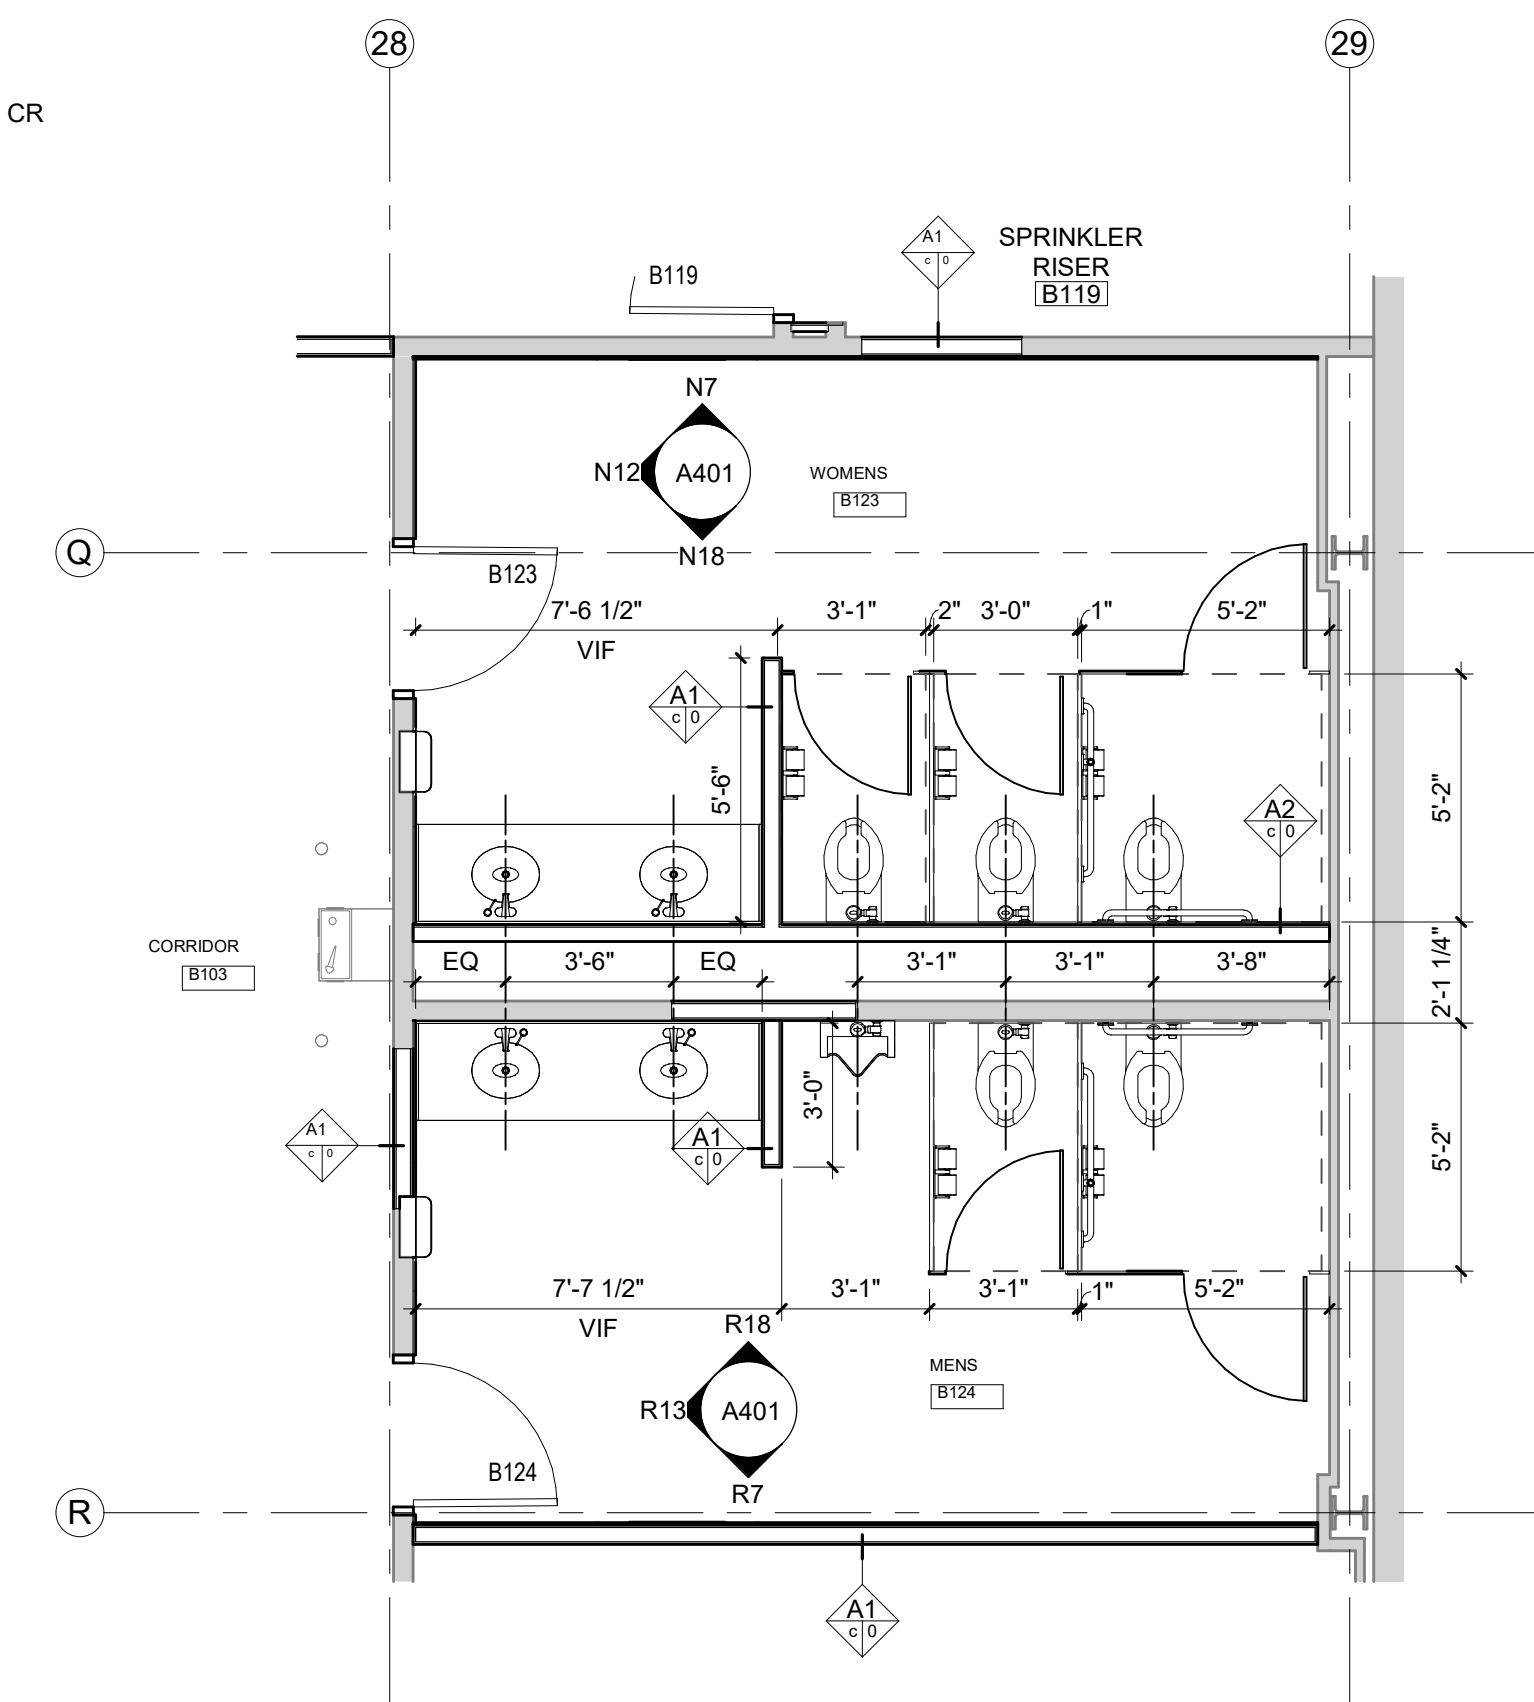

A19 ENLARGED RESTROOM PLAN
1/4" = 1'-0"

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 **LEVEL 1 REFLECTED CEILING PLAN**
1/8" = 1'-0"



- GENERAL NOTES**
1. CEILINGS ARE TYPE A AND INSTALLED TO MATCH EXISTING ELEVATION (10'-0") UNLESS NOTED OTHERWISE.
 2. CEILING-MOUNTED FIXTURES, SPRINKLERS AND EQUIPMENT SHALL BE CENTERED IN CEILING PANELS OR GYPSUM BOARD SOFFITS AND EQUALLY SPACED UNLESS NOTED OTHERWISE.
 3. CENTER CEILING GRID IN ROOMS AS SHOWN UNLESS NOTED OTHERWISE.
 4. CONCEALED SPRINKLER HEAD COVERS SHALL BE PAINTED BY MANUFACTURER TO MATCH ADJACENT SOFFIT/ACP UNLESS NOTED OTHERWISE.
 5. COORDINATE LOCATIONS OF EXIT LIGHTS AND EMERGENCY LIGHTS SHOWN ON ARCHITECTURAL DRAWINGS. IN THE EVENT OF A DISCREPANCY, VERIFY WITH ARCHITECT PRIOR TO INSTALLATION.
 6. CEILING FUTURE DIMENSIONS ARE TAKEN FROM CENTERLINE OF FIXTURE UNLESS NOTED OTHERWISE.
 7. REFER TO ARCHITECTURAL DRAWINGS (ELEVATIONS & REFLECTED CEILING PLANS) FOR ALL MECHANICAL AND ELECTRICAL DEVICE AND FIXTURE LOCATIONS & MOUNTING HEIGHTS. IF NOT CLEARLY SPECIFIED, CONTACT ARCHITECT FOR FURTHER CLARIFICATION. MECHANICAL & ELECTRICAL DRAWINGS ARE FOR FIXTURE TYPE REFERENCE ONLY.
 8. PAINT ALL EXPOSED STRUCTURE, DECK, DUCTWORK, CONDUIT, ETC. IN AREAS NOTED TO BE OPEN TO STRUCTURE UNLESS NOTED OTHERWISE. PAINTING OF EXPOSED STRUCTURE TO BE DONE AFTER ALL UTILITIES ARE INSTALLED.

- CEILING LEGEND**
- BATT LINE DENOTES LOCATIONS OF ACOUSTIC PARTITIONS TO RECEIVE ACOUSTICAL BATT INSULATION AND SOUND SEALANT AT PERIMETER AND PENETRATIONS. REFER TO FLOOR PLANS FOR WALL TYPES.
 - ACCESS PANEL
 - RECTANGULAR FIXTURE
 - LINEAR FIXTURE
 - DOWN LIGHTS
 - LINEAR PENDANT
 - DOWN LIGHT PENDANTS
 - UTILITY LIGHTS
 - CEILING & WALL MOUNT EXIT SIGNS
 - HVAC SUPPLY DIFFUSER
 - HVAC RETURN DIFFUSER
 - HVAC EXHAUST DIFFUSER
 - HVAC SLOT DIFFUSER
 - HVAC ROUND DIFFUSER
 - PROJECTOR
 - PROJECTOR SCREEN
 - OCCUPANCY SENSOR
 - SPEAKER
 - MICROPHONE
 - WIRELESS ACCESS POINT
 - CEILING & WALL MOUNT CLOCK
 - SMOKE DETECTOR
 - CEILING & WALL MOUNT CAMERA
 - DATA & POWER
 - SPRINKLER

- CEILING TYPES**
- A. ACP-1 SEE INTERIOR FINISH SPECIFICATION ON SHEET A001
 - B. ACP-1.1 NEW TILE OR EXISTING TILE FROM OWNER ATTIC STOCK (AVAILABLE ATTIC STOCK = APPROX. 240 TILES)
 - C. ACP-1.2 SALVAGED CEILING TILE
 - D. GYPSUM BOARD CEILING ON METAL STUD FRAMING
 - X. EXISTING CEILING TO REMAIN. VERIFY HEIGHT IN FIELD.

OPNARCHITECTS

100 Court Ave., Suite 100
Des Moines, IA 50309
P: 515-309-0722
www.opnarchitects.com

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Owner

STATE OF IOWA - DEPARTMENT OF ADMINISTRATIVE SERVICES
1305 E WALNUT ST
DES MOINES, IA 50319

Project

9411.00 - DAS 6200 PARK ALI - WORKMAN'S COMP RENOVATION
6200 PARK AVE
DES MOINES, IA 50321

Construction Manager

DCI GROUP
220 SE 6TH ST - SUITE 200
DES MOINES, IA 50309
P. 515-244-5043

Civil Engineer

CIVIL ENGINEERING CONSULTANTS
2400 86TH ST - UNIT 12
DES MOINES, IA 50322
P. 515-276-7084

Structural Engineer

RAKER RHODES ENGINEERING
4717 GRAND AVE
DES MOINES, IA 50312
P. 515-277-0275

Mechanical Engineer

KOL ENGINEERING
300 4TH ST
WEST DES MOINES, IA 50265
P. 515-724-7938

Electrical Engineer

KOL ENGINEERING
300 4TH ST
WEST DES MOINES, IA 50265
P. 515-724-7938

Key Plan

Revision

Description

Date

OPN Project No.

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Sheet Issue Date

100% CONSTRUCTION

08/16/2024


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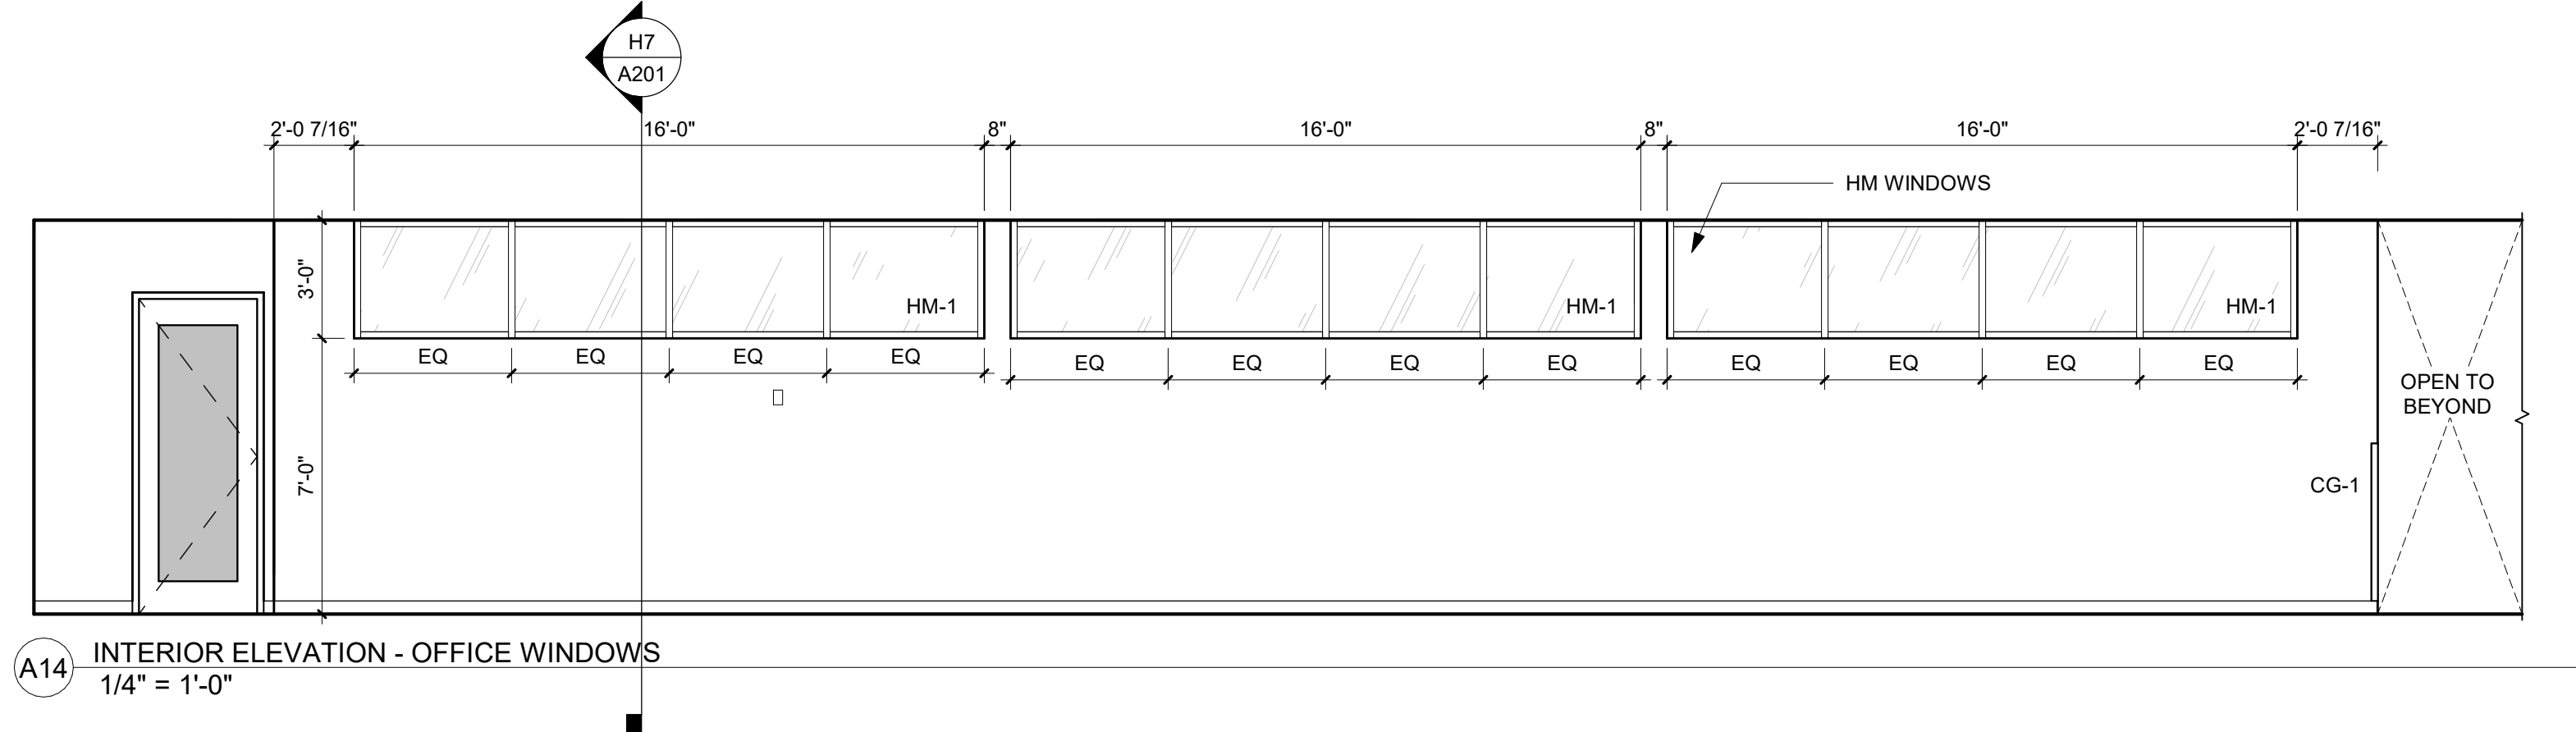
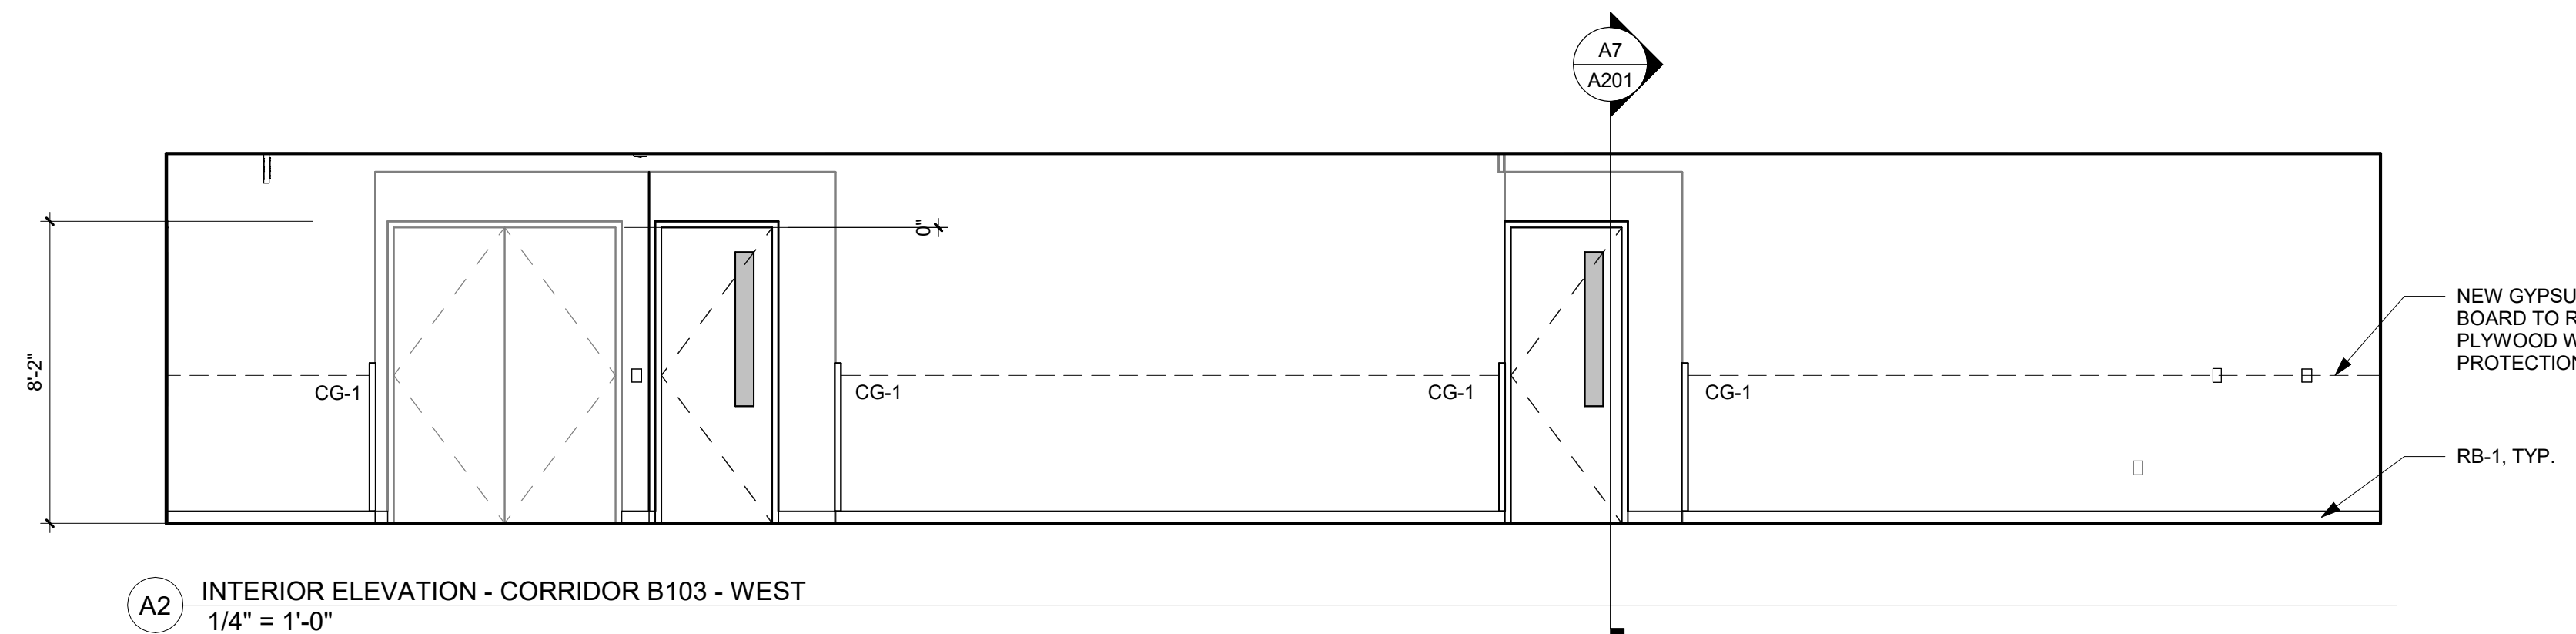
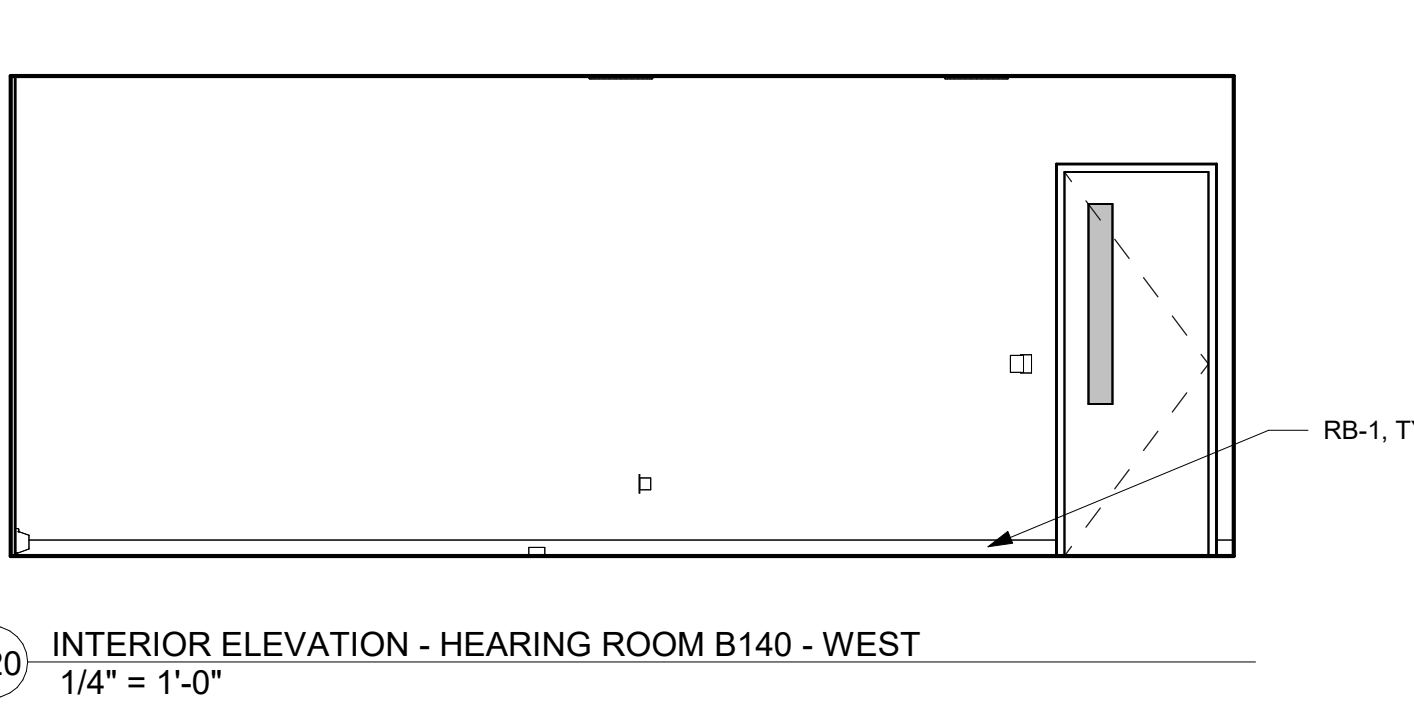
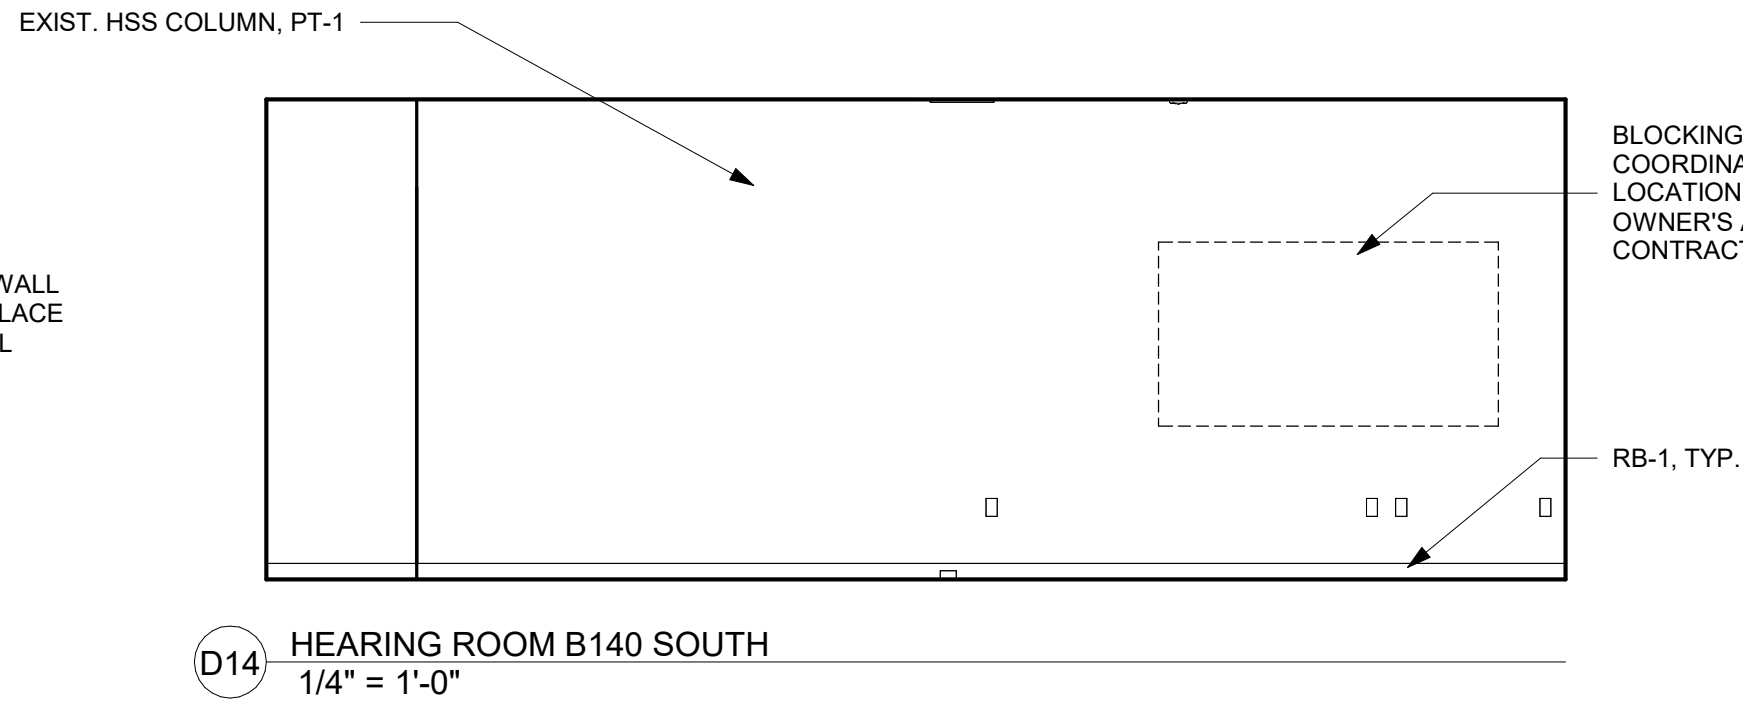
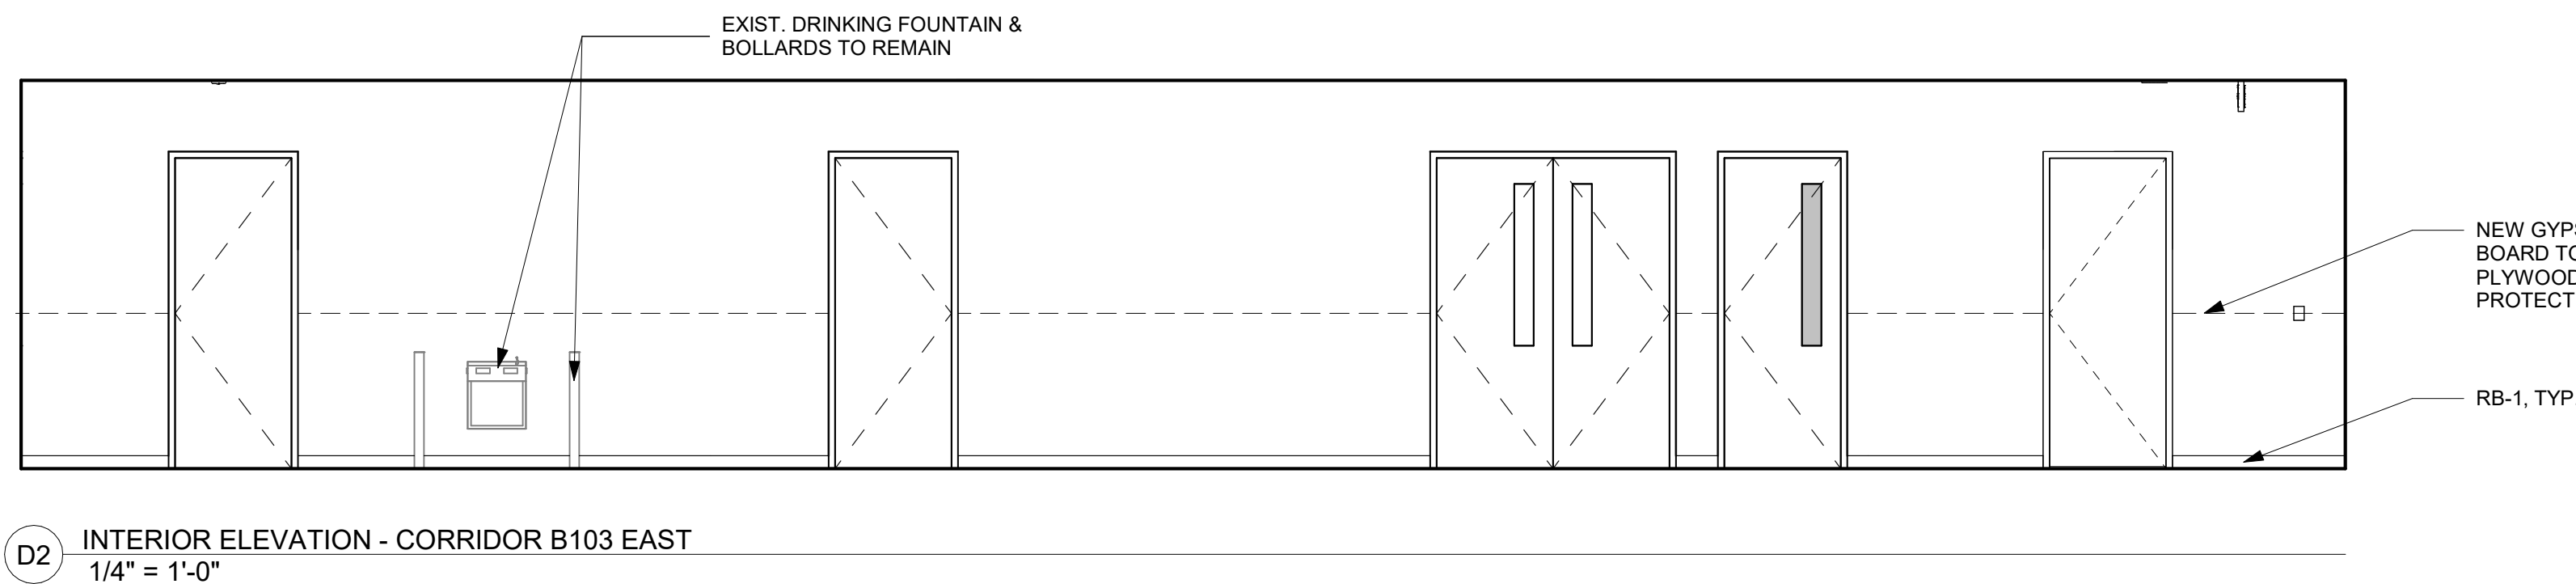
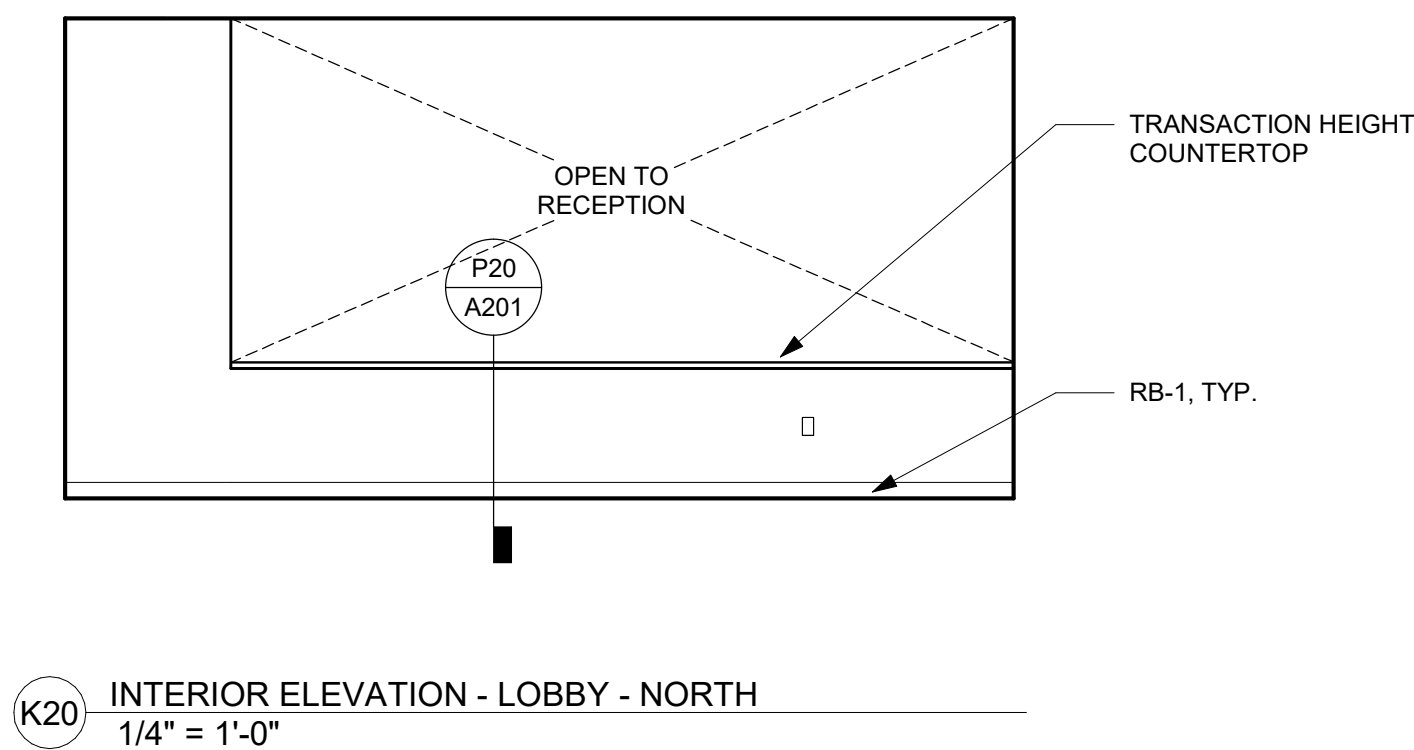
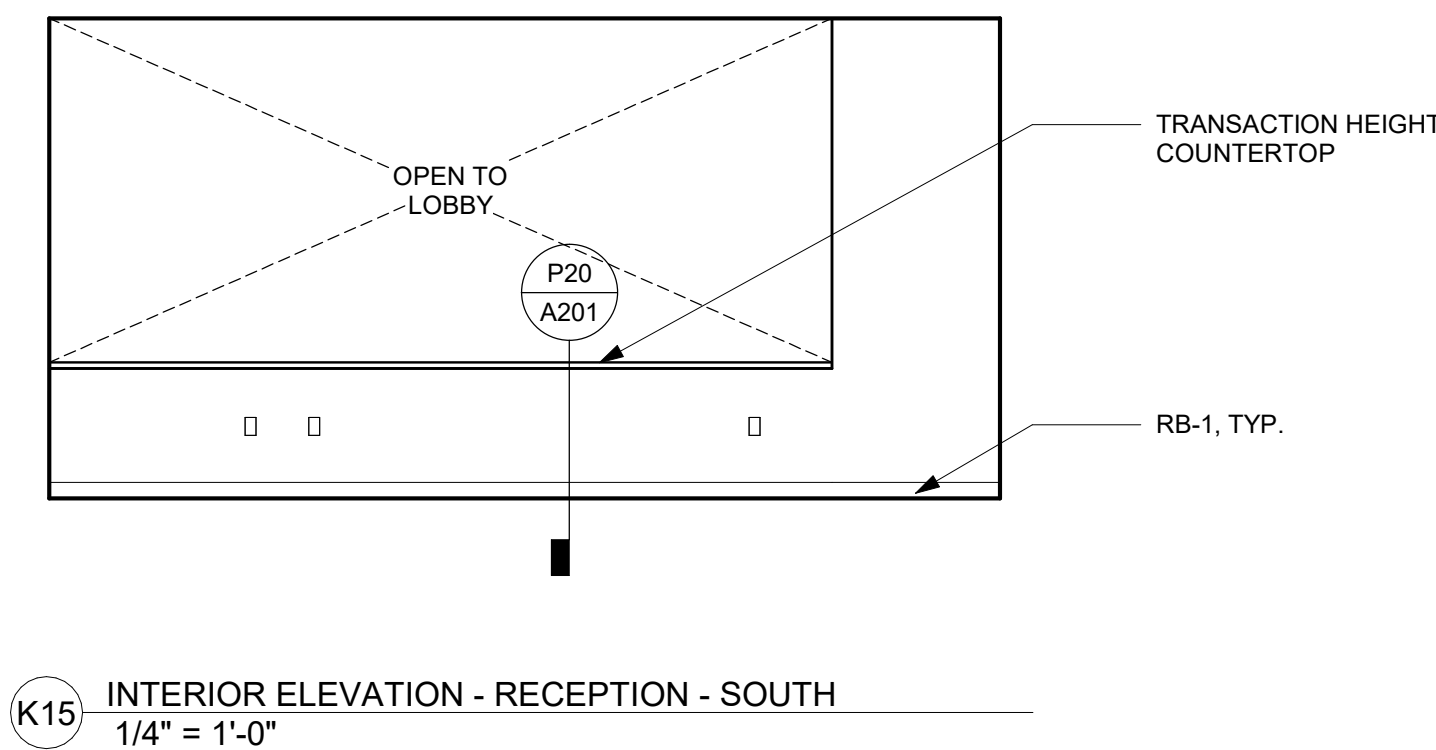
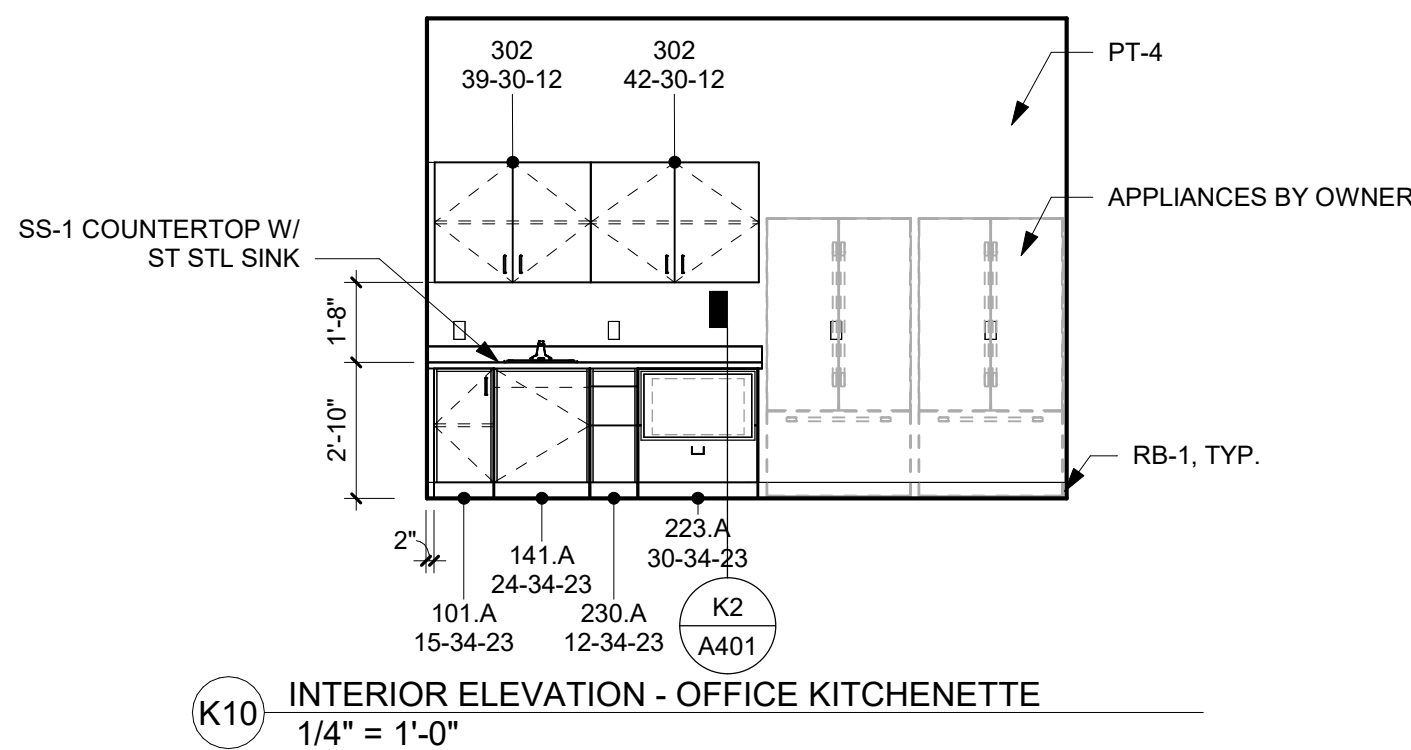
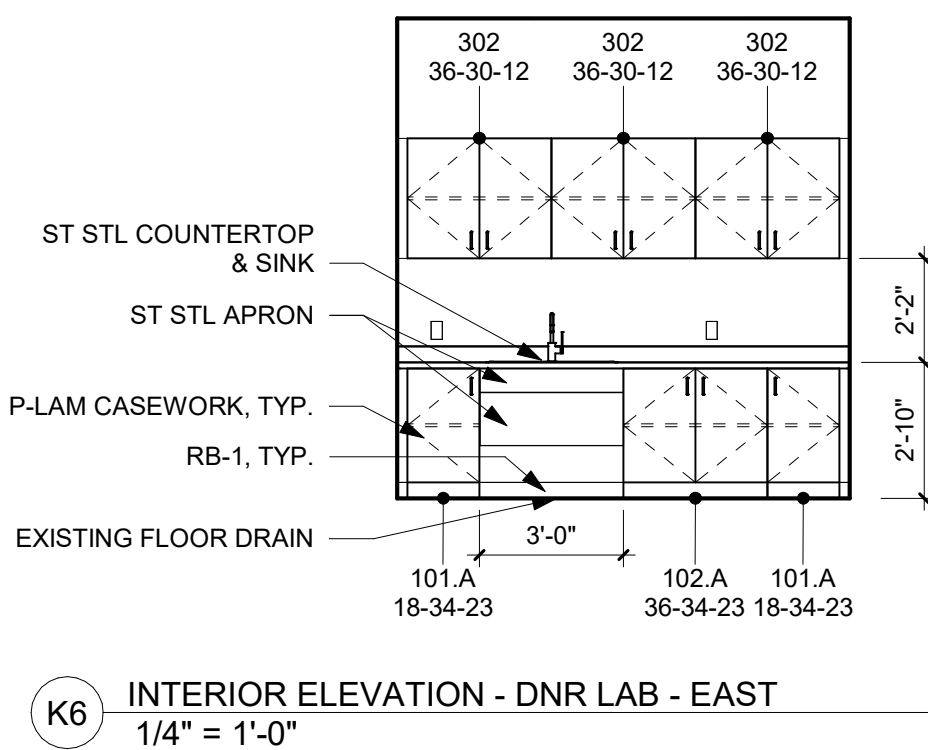
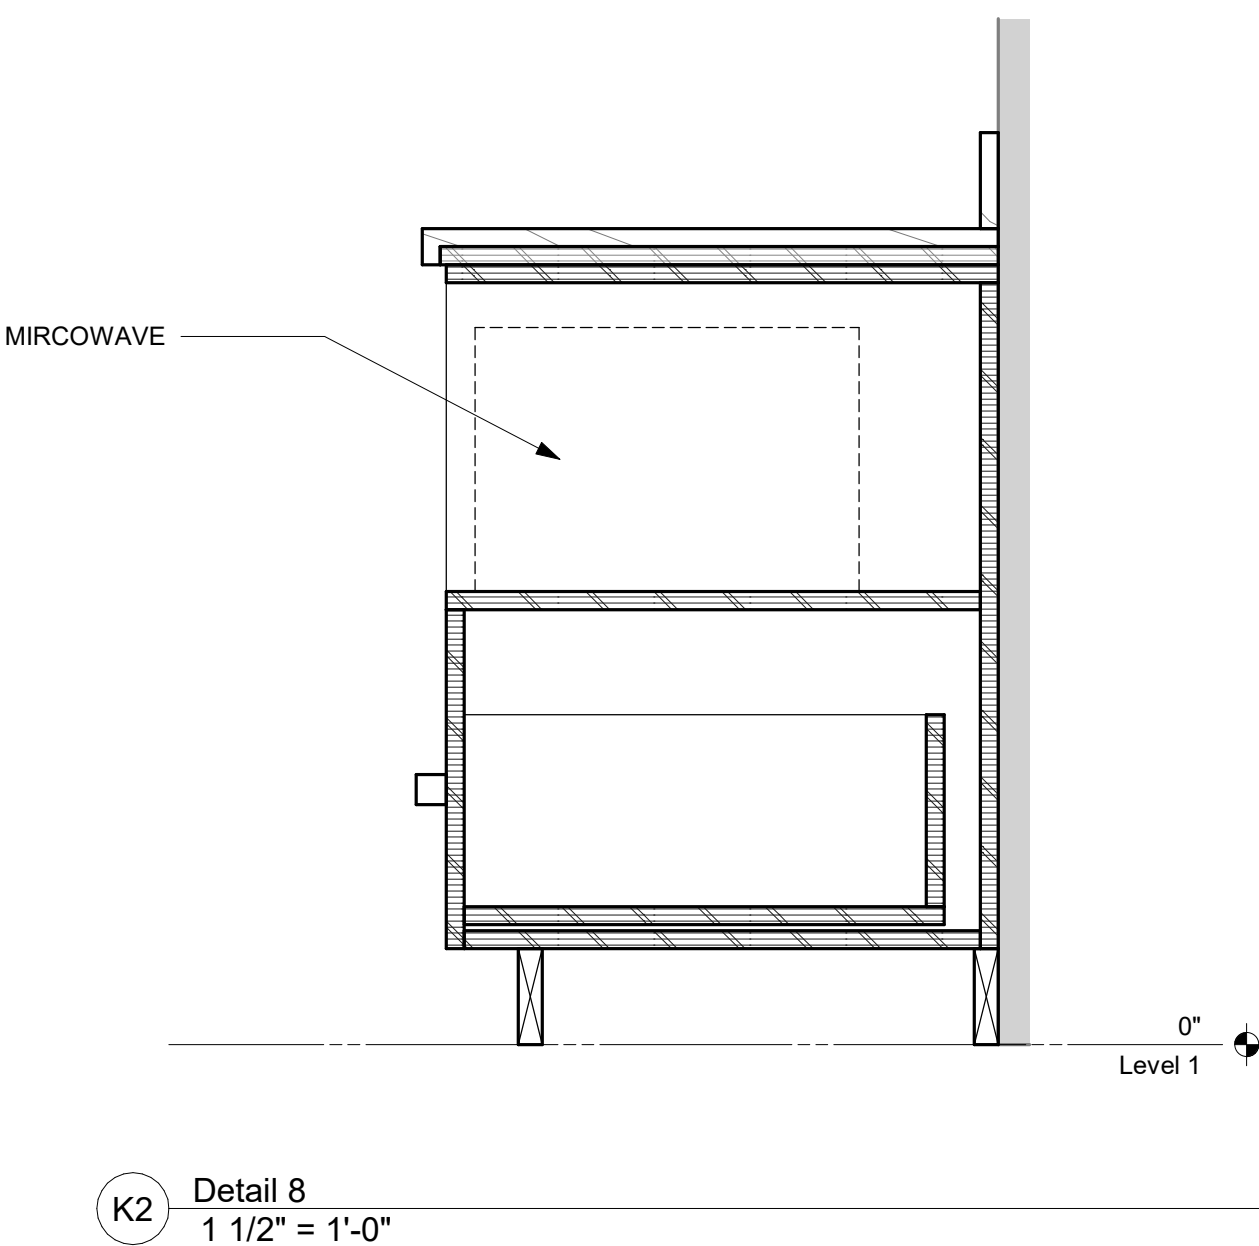
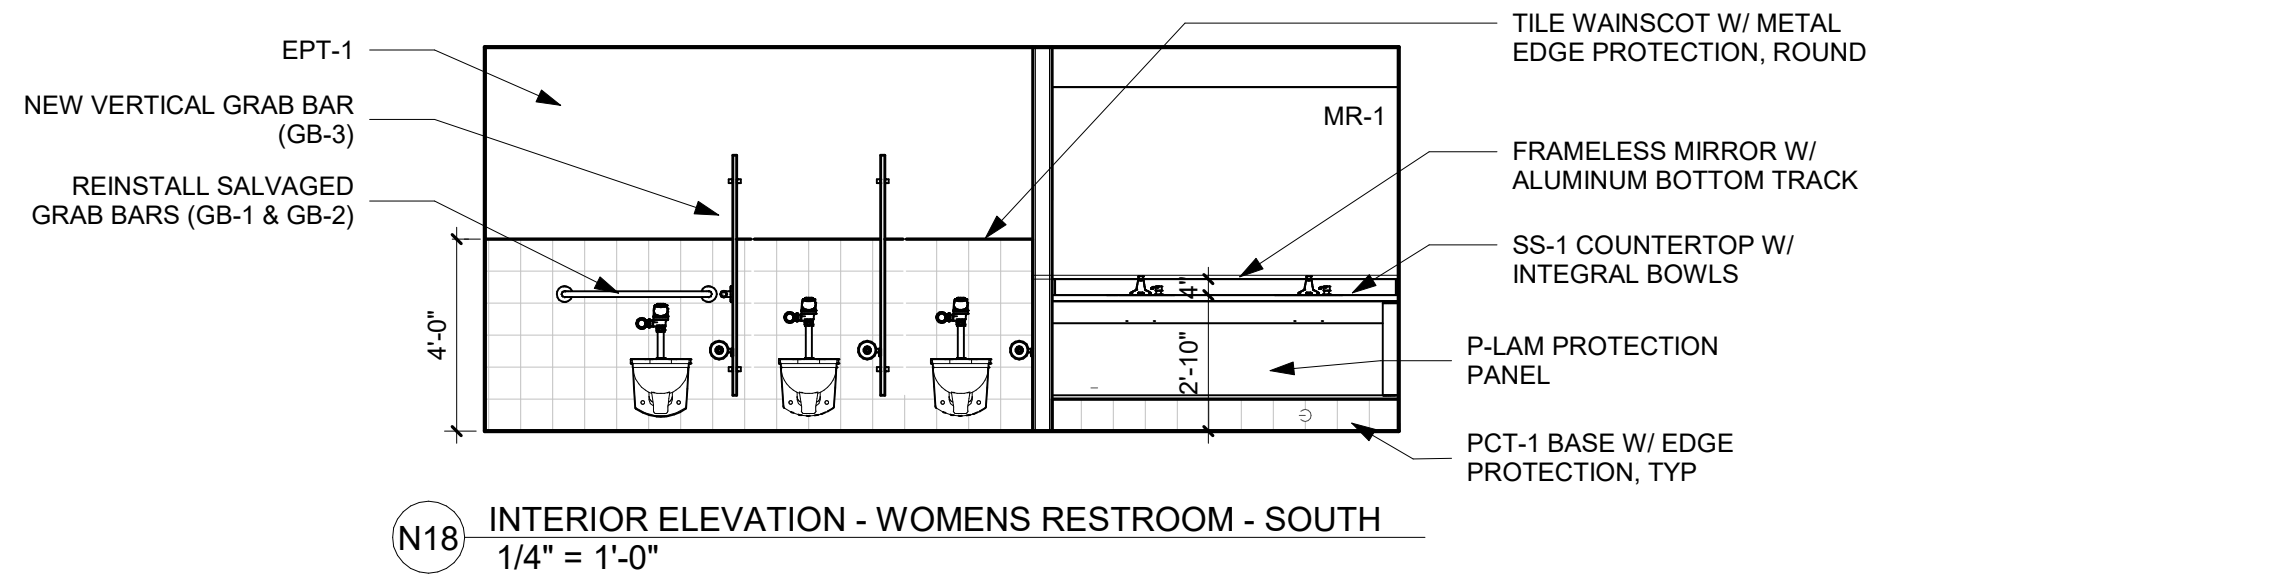
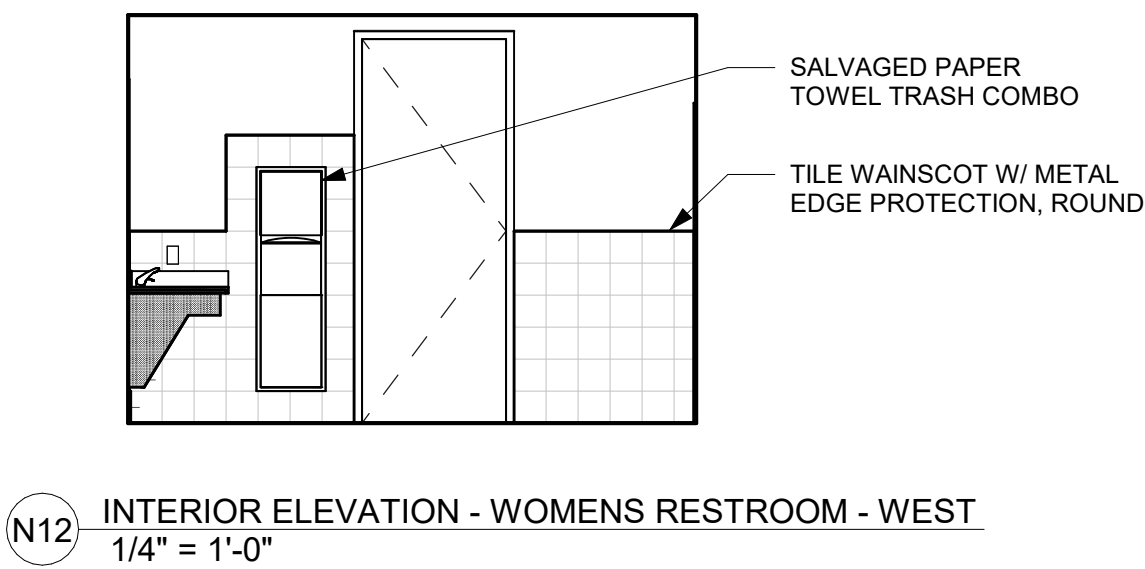
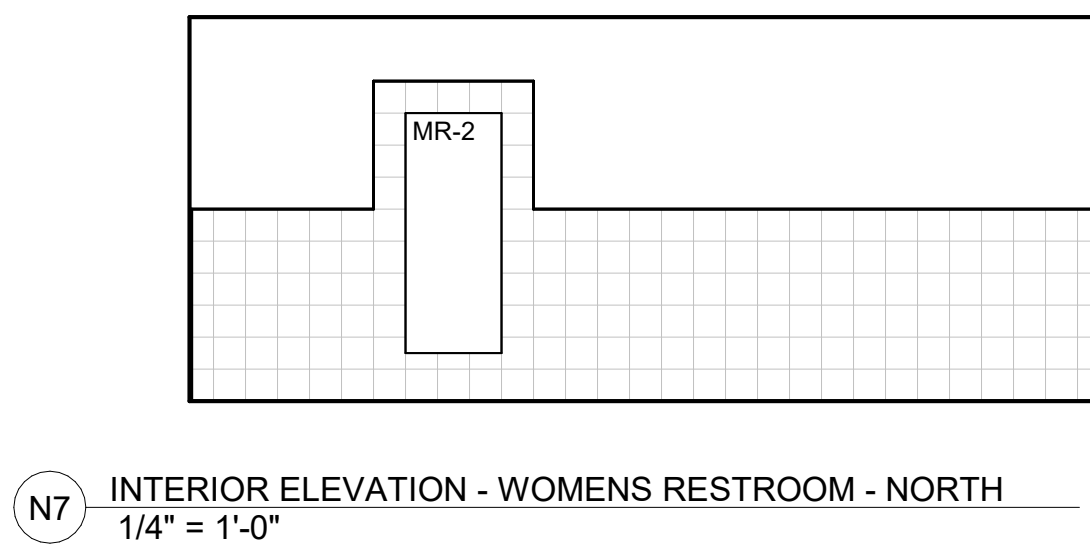
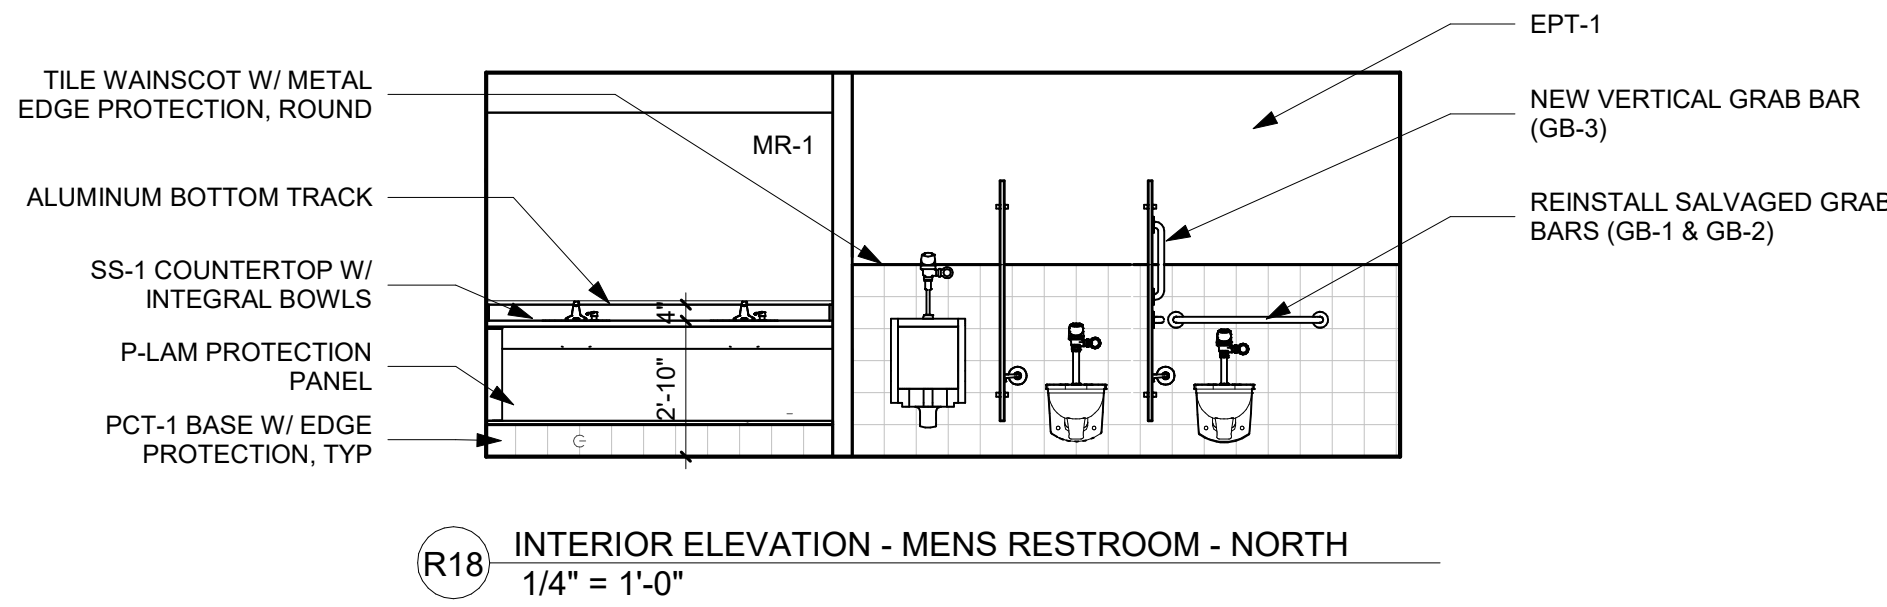
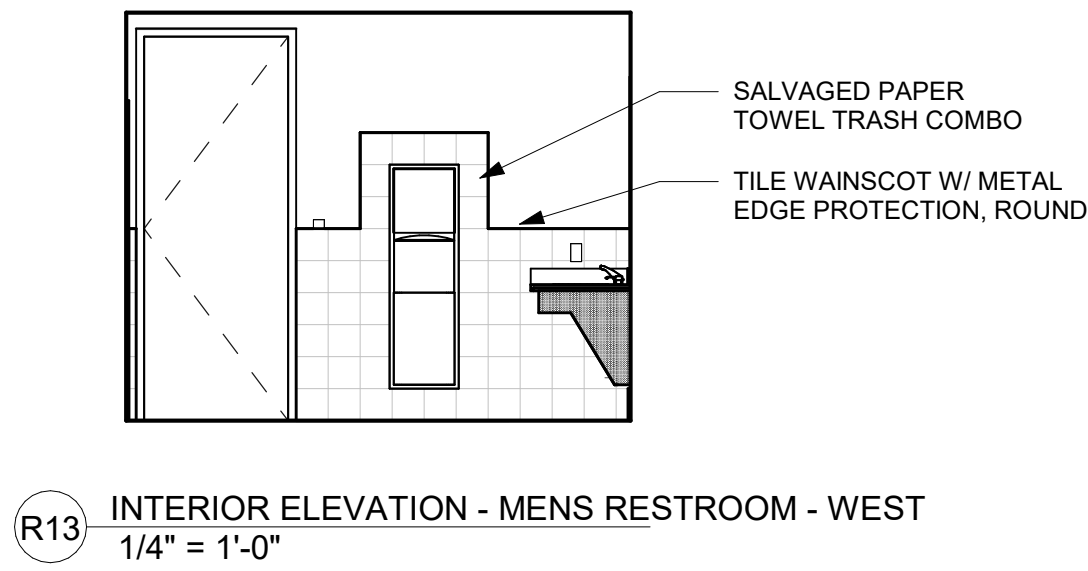
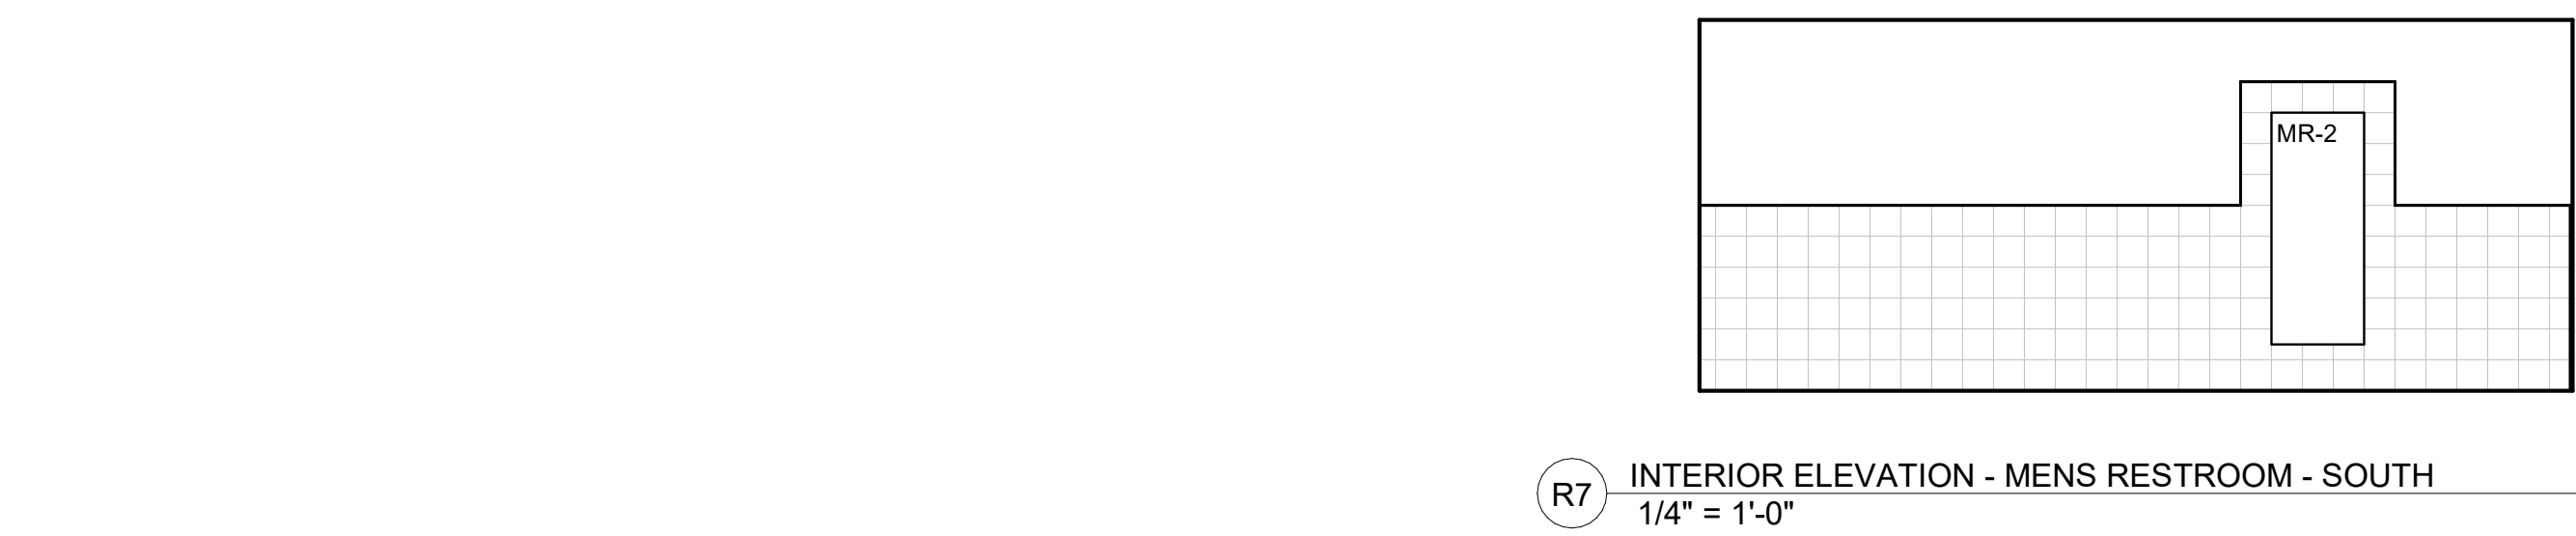
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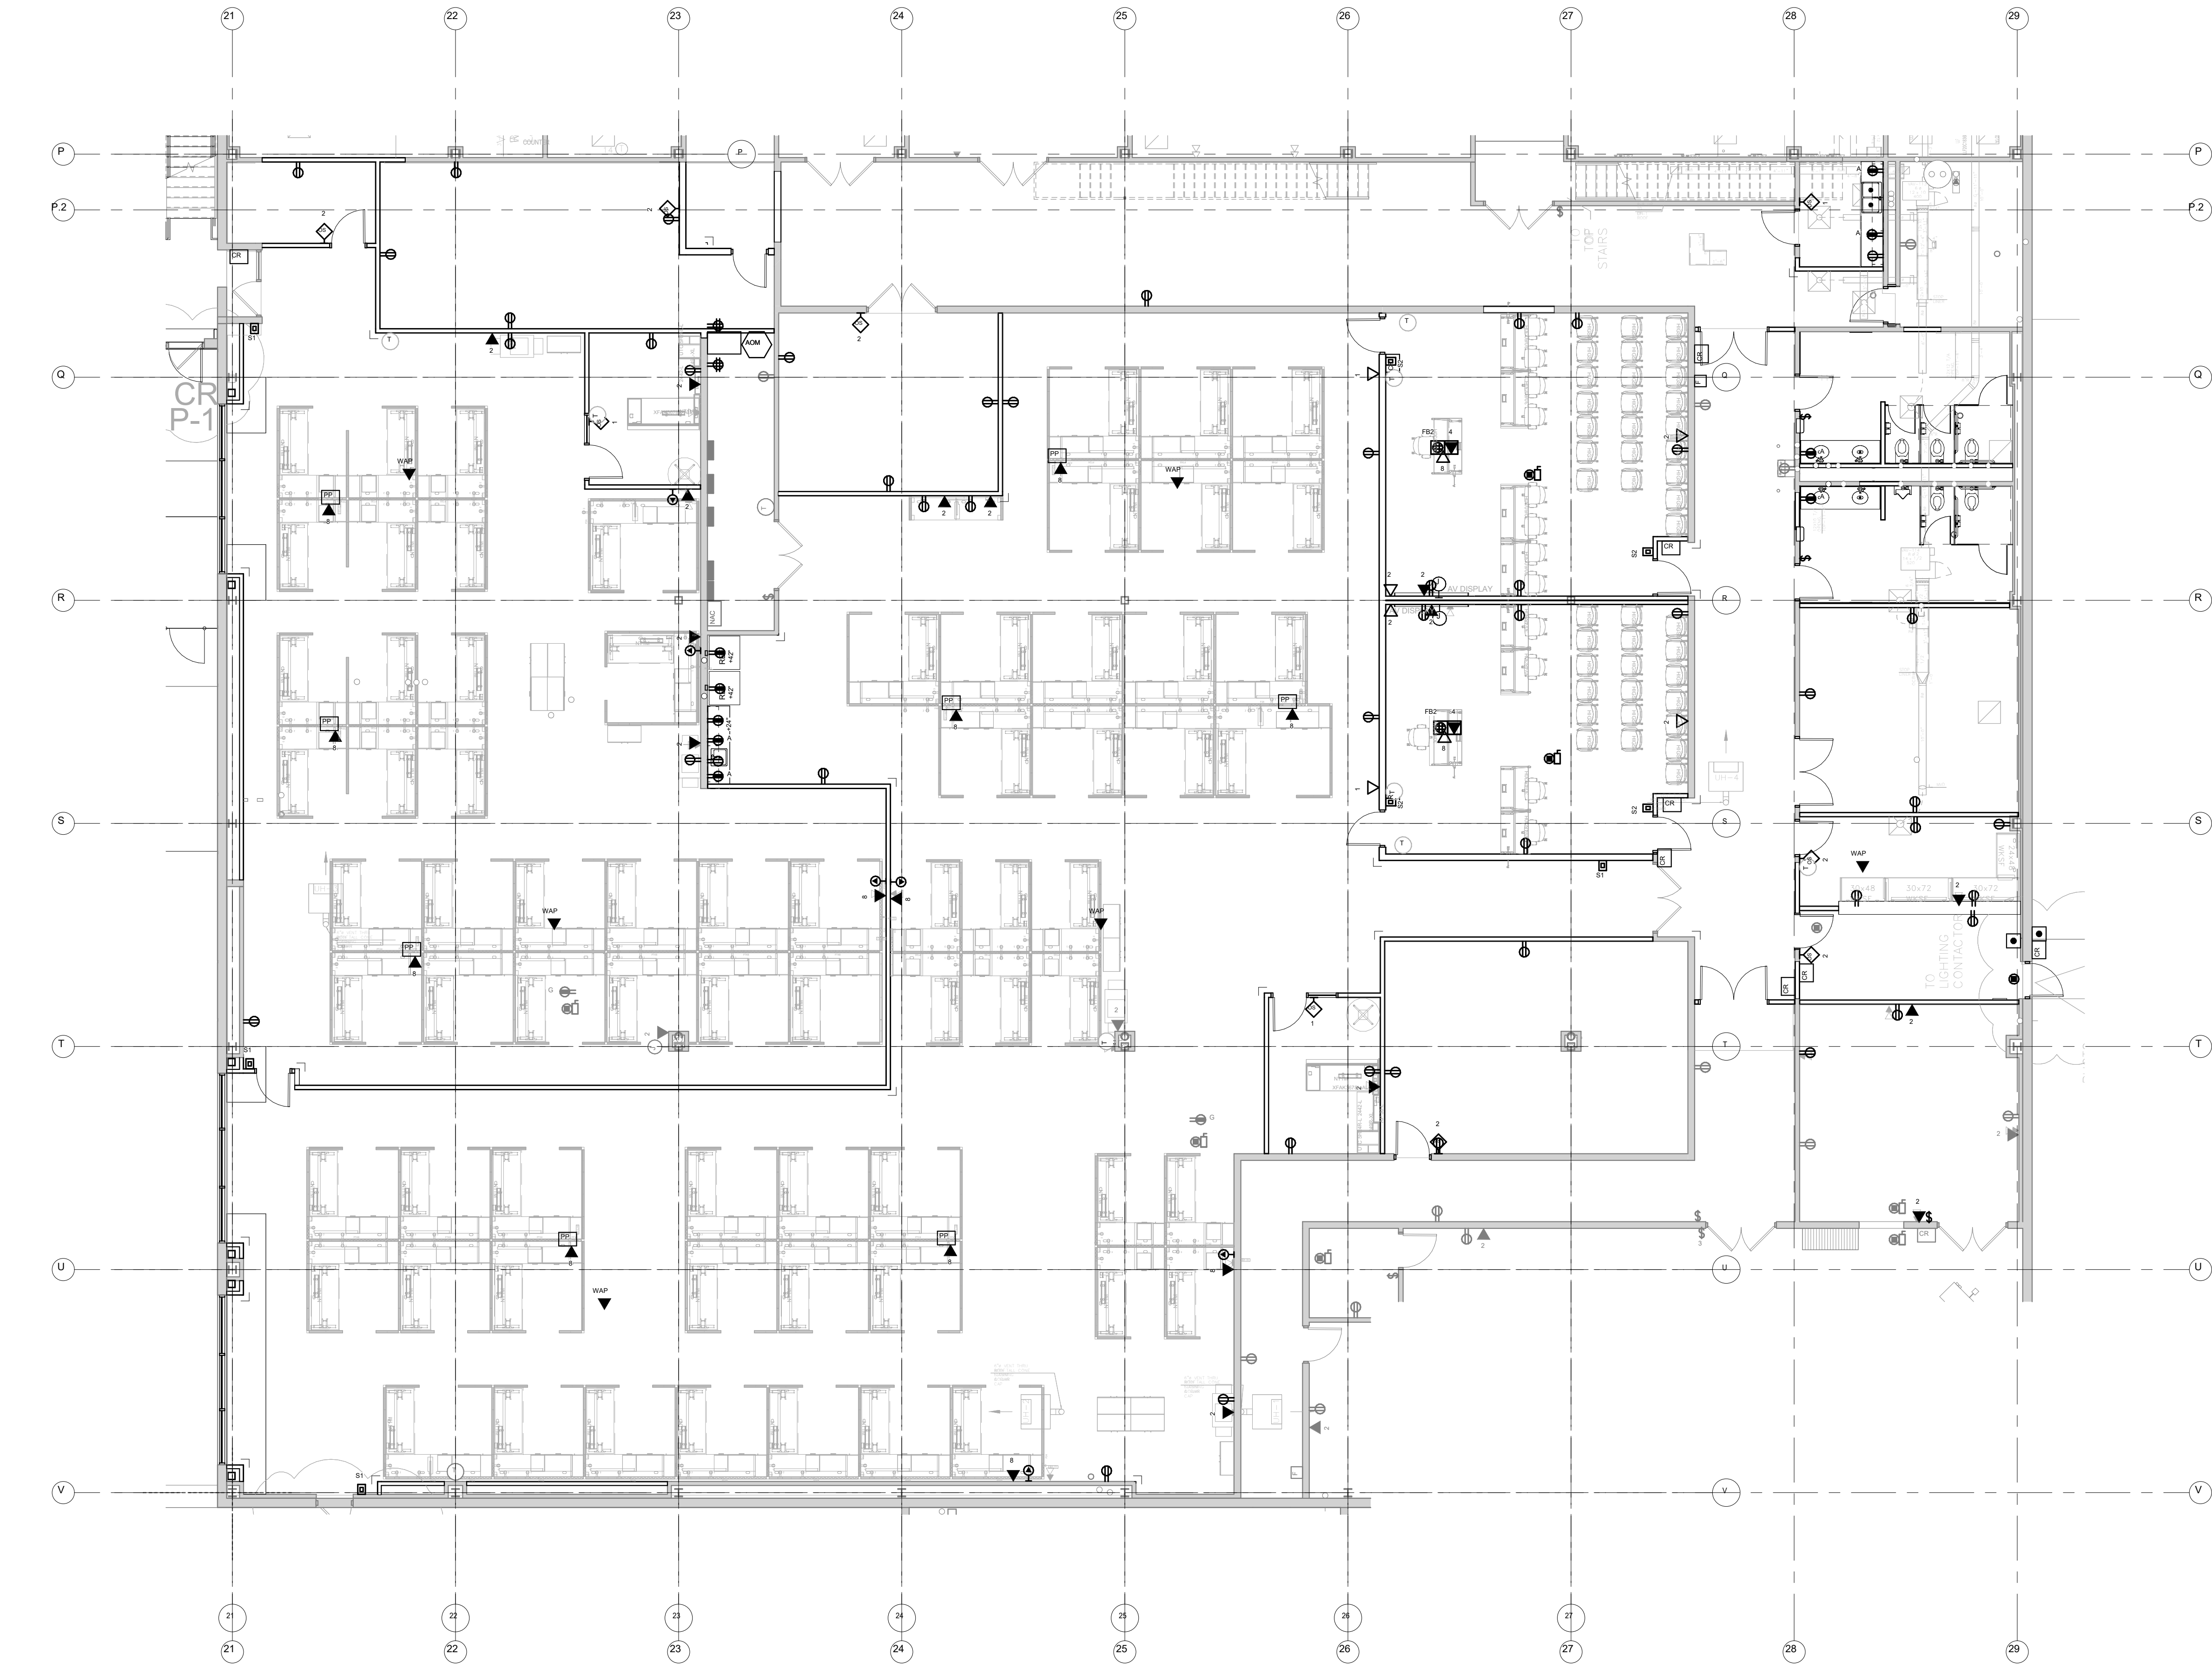
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A2 LEVEL 1 FURNITURE FLOOR PLAN (FOR REFERENCE ONLY)
1/8" = 1'-0"

Owner
STATE OF IOWA - DEPARTMENT OF ADMINISTRATIVE SERVICES
1305 E WALNUT ST
DES MOINES, IA 50319

Project
SHELL DR. DAS 1000 PARK ALL -
WORKMAN'S COMP RENOVATION

6200 PARK AVE
DES MOINES, IA 50321

Construction Manager
DCI GROUP
220 SE 6TH ST - SUITE 200
DES MOINES, IA 50309
P. 515-244-5043

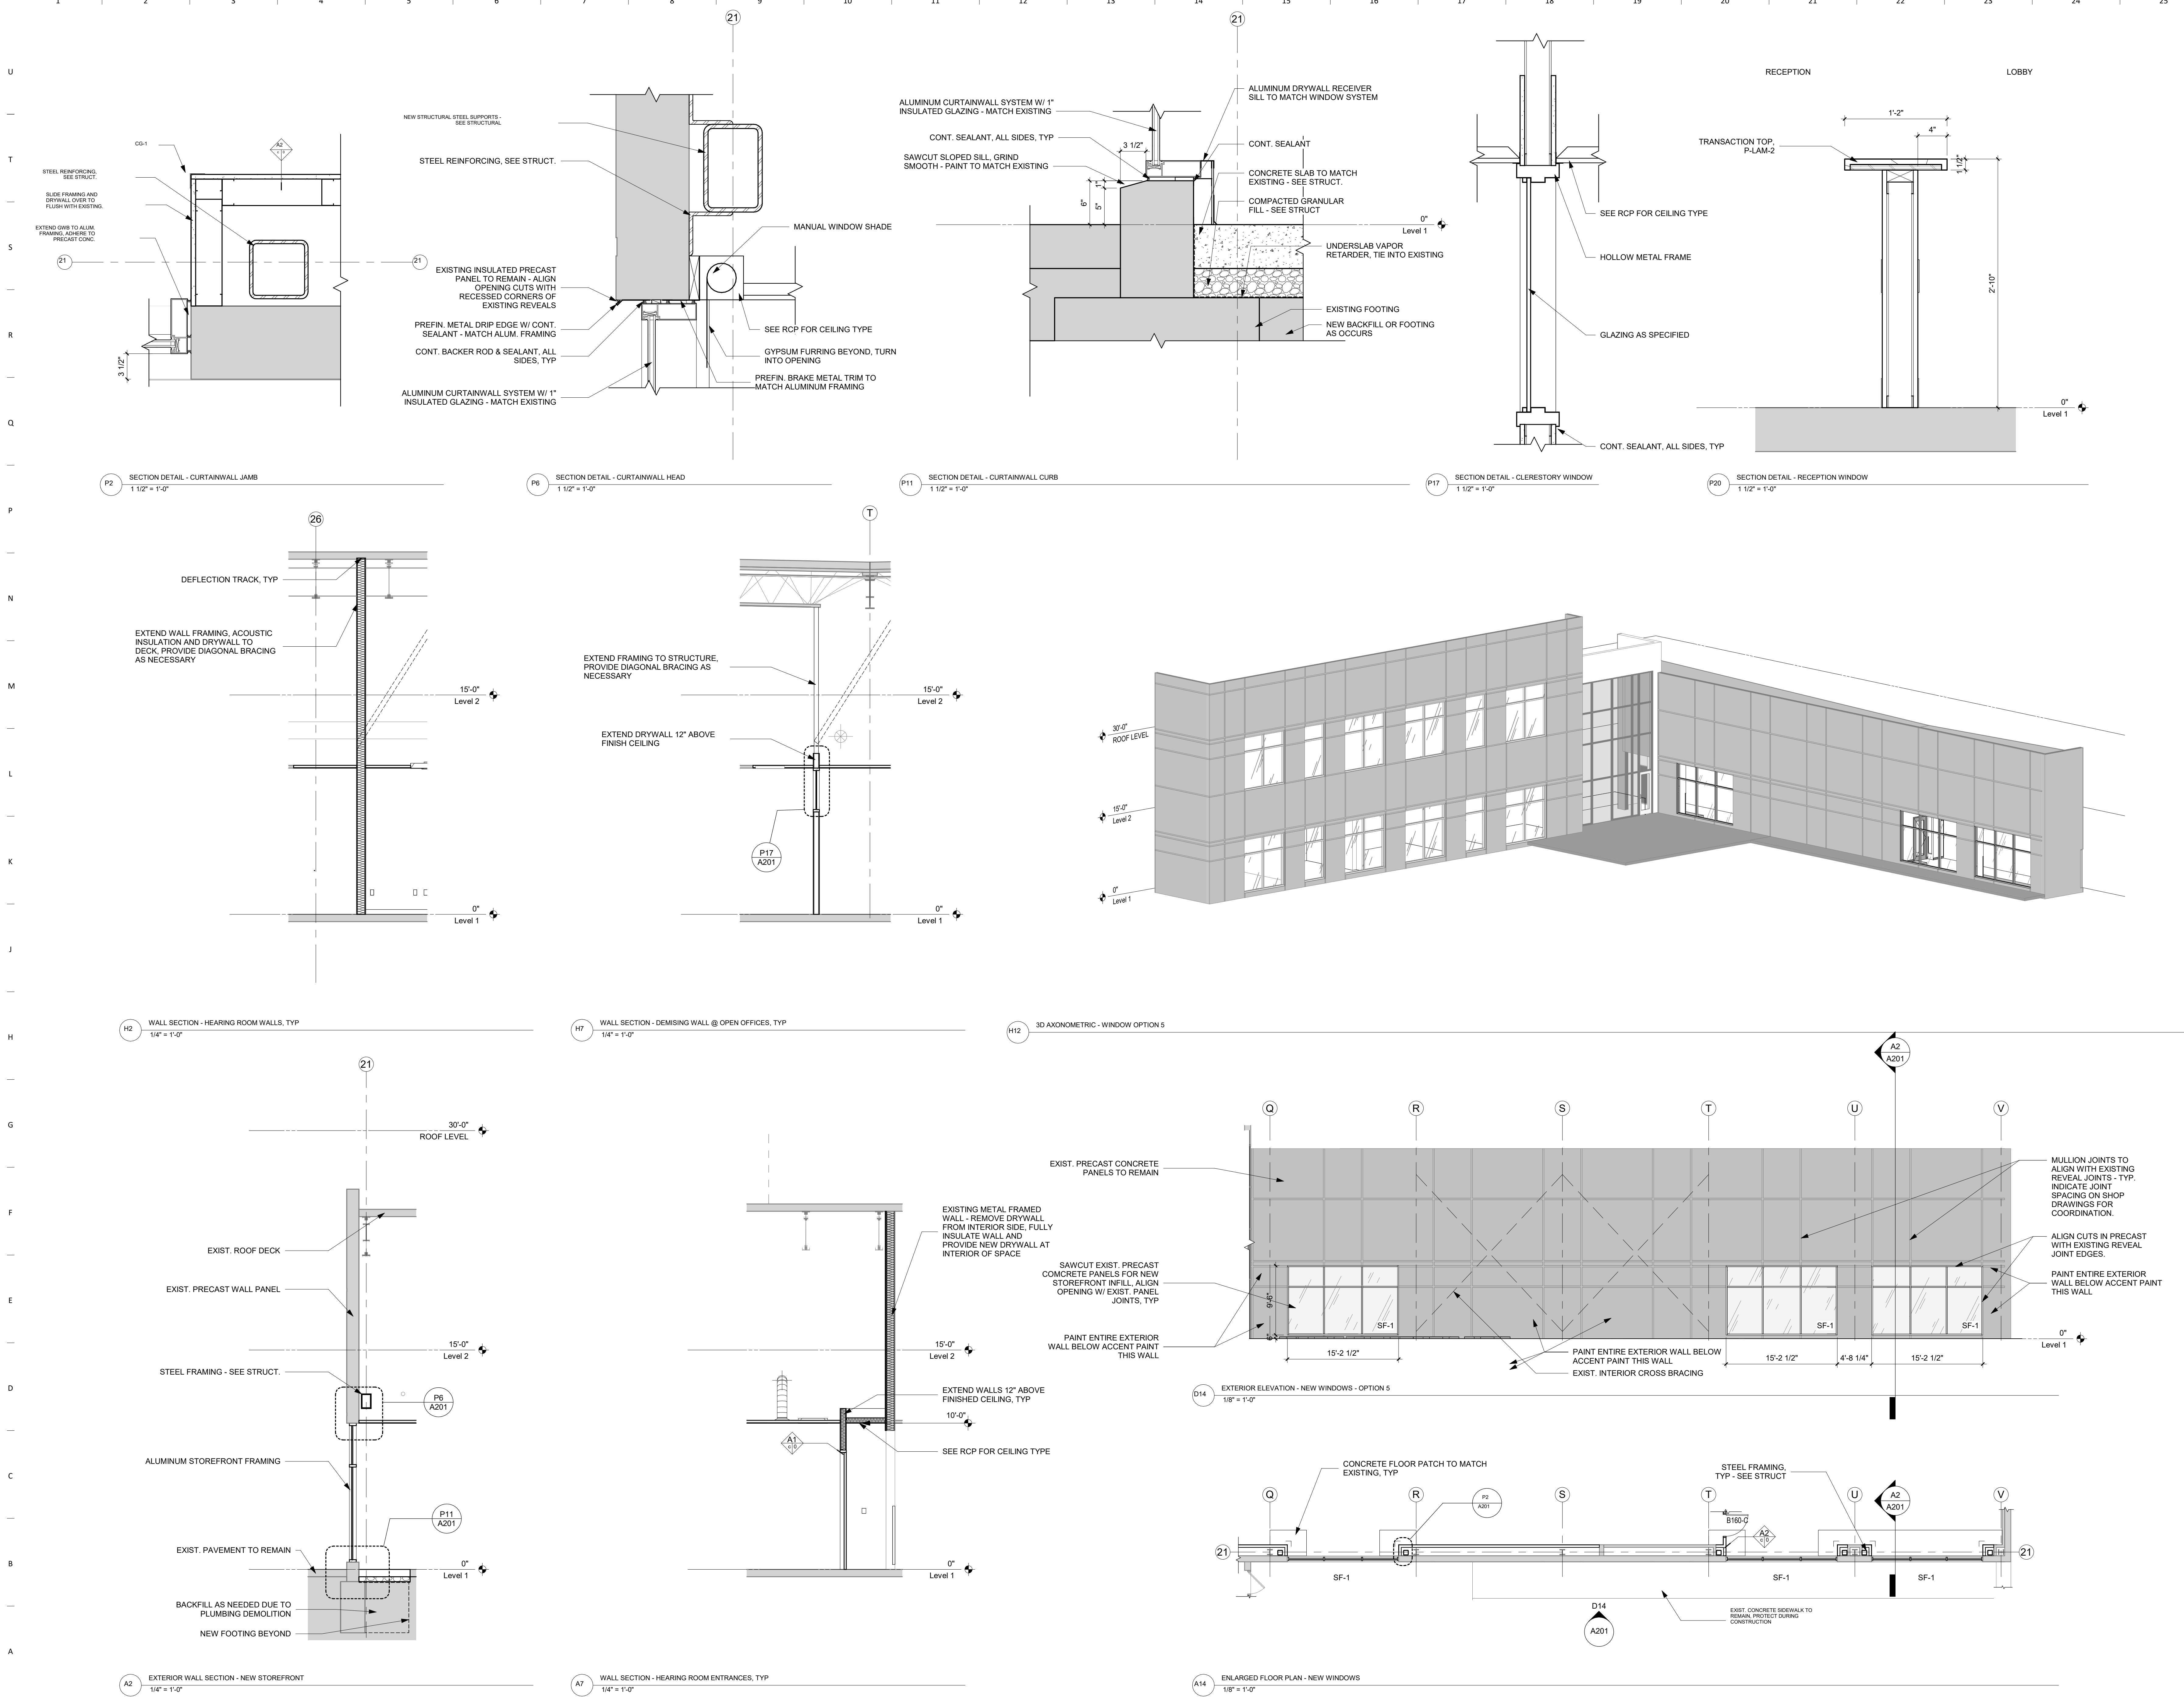Civil Engineer
CIVIL ENGINEERING CONSULTANTS
2400 86TH ST - UNIT 12
DES MOINES, IA 50322
P. 515-276-7084

Structural Engineer
RAKER RHODES ENGINEERING
4717 GRAND AVE
DES MOINES, IA 50312
P. 515-277-0275

Mechanical Engineer
KCI ENGINEERING
300 4TH ST
WEST DES MOINES, IA 50265
P. 515-724-7938

Electrical Engineer
KCI ENGINEERING
300 4TH ST
WEST DES MOINES, IA 50265
P. 515-724-7938

Key Plan:

Revision	Description	Date
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Sheet Name
**FURNITURE PLAN
(REFERENCE ONLY)**

Sheet Number

PLUMBING - NOTES

- COORDINATE WORK WITH ALL OTHER TRADES AS DESCRIBED IN MECHANICAL GENERAL NOTE #1.
- PROVIDE A COMPLETE PLUMBING SYSTEM INCLUDING PIPE, INSULATION, HANGERS, SUPPORTS, EQUIPMENT, WATER HEATERS, FIXTURES, MIXING VALVES, VALVES, ACCESSORIES AND SPECIALTIES. INSTALL ALL EQUIPMENT PER MANUFACTURER'S RECOMMENDATIONS. SIZE AND INSTALL PLUMBING SYSTEM PER PLUMBING CODE. COMPLY WITH ALL LOCAL AND STATE CODES AND OWNER'S REQUIREMENTS.
- DRAWING PLANS, SCHEMATICS, AND DIAGRAMS INDICATE GENERAL LOCATION AND ARRANGEMENT OF PLUMBING SYSTEM.
- EXISTING PLUMBING DISTRIBUTION AND EQUIPMENT SHOWN ARE BASED ON NON-DESTRUCTIVE SITE OBSERVATION AND AS-BUILT DOCUMENTS PROVIDED BY THE OWNER. FIELD VERIFY ALL EXISTING CONDITIONS INCLUDING LOCATING UNDER FLOOR PIPING AND PIPING CONCEALED IN BUILDING ASSEMBLIES WHERE WORK IS REQUIRED.
- SEAL ALL WALL PIPE PENETRATIONS. PROVIDE THROUGH-PENETRATION FIRESTOPPING WHERE REQUIRED. REFER TO ARCHITECTURAL DRAWINGS FOR WALL, FLOOR, AND CEILING ASSEMBLY RATINGS.
- CONTINUE PIPE INSULATION THROUGH WALL, FLOOR, AND CEILING PENETRATIONS UNBROKEN. SEAL AROUND PIPE INSULATION AT PENETRATIONS.
- VERIFY WITH ENGINEER FOR ANY FIXTURES NOT TAGGED OR PIPED PRIOR TO ANY WORK. CONTRACTOR IS RESPONSIBLE FOR ALL PLUMBING FIXTURES SHOWN ON ARCHITECTURAL DRAWINGS, TAGGED OR NOT TAGGED ON PLUMBING / MECHANICAL DRAWINGS UNLESS SPECIFICALLY NOTED AS EXCLUDED FROM SCOPE.

FIRE PROTECTION - NOTES

- COORDINATE WORK WITH ALL OTHER TRADES AS DESCRIBED IN MECHANICAL GENERAL NOTE #1.
- LOCATE SPRINKLER HEADS TO PROVIDE SUFFICIENT COVERAGE IN INDIVIDUAL SPACES WITHOUT CONFLICT WITH LIGHTS, DIFFUSERS, AIR TERMINALS, AND OTHER CEILING ELEMENTS.
- PROVIDE MANUAL DRAIN VALVES AT ALL LOW POINTS IN THE SYSTEM WHERE OFFSETS ARE REQUIRED TO AVOID COORDINATION CONFLICTS.
- CENTER SPRINKLER HEADS WITHIN CEILING TILES OR AS INDICATED ON THE ARCHITECTURAL REFLECTED CEILING PLAN (RCP) UNLESS INDICATED OTHERWISE.
- DO NOT INSTALL SPRINKLER MAINS SHALL THROUGH COMMUNICATION OR ELECTRICAL ROOMS. INSTALL SIDEWALL SPRINKLER HEADS IN COMMUNICATION AND ELECTRICAL ROOMS WITH NO PIPING INSIDE THE ROOM WHENEVER POSSIBLE.
- DO NOT INSTALL SPRINKLER PIPING OR SPRINKLERS THAT ENCR OACH ON THE REQUIRED CLEARANCE OF ANY OTHER EQUIPMENT. RELOCATE PIPING AND HEADS WHERE CLEARANCES ARE OBSTRUCTED.
- INCLUDE COST TO REMOVE AND REPLACE ALL EXISTING PIPING IN OUTLINED SCOPE OF WORK AREA, AS THE EXISTING PIPING MAY CONFLICT WITH NEW DUCTWORK. NEW DUCTWORK HAS PRIORITY OVER NEW AND EXISTING SPRINKLER PIPING.

MECHANICAL – DEMOLITION NOTES

- MECHANICAL DEMOLITION DRAWINGS SHOWING EXISTING CONDITIONS HAVE BEEN PREPARED BASED ON NON-DESTRUCTIVE FIELD OBSERVATION AND AS-BUILT DRAWINGS PROVIDED BY THE OWNER. FIELD VERIFY EXISTING SYSTEMS BEFORE BEGINNING WORK. NOTIFY ARCHITECT/ENGINEER IF EXISTING CONDITIONS ARE MATERIALLY DIFFERENT THAN THOSE SHOWN ON THE PLANS.
- BE FAMILIAR WITH EXISTING MECHANICAL SYSTEMS THAT WILL BE AFFECTED BY THE DEMOLITION WORK. OBTAIN PERMISSION FROM THE OWNERS REPRESENTATIVE TO SHUT OFF SERVICES OR SYSTEMS THAT AFFECT AREAS BEYOND THE LIMITS OF THE IMMEDIATE DEMOLITION AREA. INFORM THE OWNER'S REPRESENTATIVE OF THE REASON FOR AND DURATION OF THE SHUTDOWN, MINIMIZE IMPACT TO OTHER AREAS. PROCEED WITH THE SHUT-DOWN AFTER PERMISSION FROM THE OWNER IS GRANTED.
- REMOVE PIPING, HANGERS, DUCTWORK, GRILLES, REGISTERS, DIFFUSERS, ETC. THAT ARE INDICATED TO BE REMOVED IN A TIMELY MANNER IN ACCORDANCE WITH THE GENERAL DEMOLITION SPECIFICATIONS. COORDINATE WITH THE OWNER AND OTHER CONTRACTORS.
- UNLESS EQUIPMENT TO BE REMOVED IS NOTED AS OWNER'S SALVAGE, DISPOSE OF EQUIPMENT AND/OR MATERIALS INDICATED TO BE REMOVED PROMPTLY.
- REMOVE ALL ABANDONED PIPING AND DUCTWORK THAT IS EXPOSED OR ACCESSIBLE WITHOUT WALL OR CEILING DEMOLITION. REFER TO ARCH PLANS FOR CEILINGS TO BE REMOVED.
- REPAIR OR REPLACE TELECOMMUNICATIONS FACILITIES OR EQUIPMENT FOUND TO BE DAMAGED OR NON-FUNCTIONAL AFTER SUBSTANTIAL COMPLETION.

HVAC - NOTES

- COORDINATE WORK WITH ALL OTHER TRADES AS DESCRIBED IN MECHANICAL GENERAL NOTE #1.
- PROVIDE A COMPLETE HVAC SYSTEM, INCLUDING SUPPLY, RETURN, EXHAUST, AND VENTILATION DUCTWORK; MECHANICAL EQUIPMENT, SUPPORTS, HANGERS, DIFFUSERS, GRILLES, REGISTERS, AND ALL APPURTENANCES. INSTALL ALL EQUIPMENT PER MANUFACTURER'S RECOMMENDATIONS. INSTALL SYSTEM TO MEET ALL CITY AND STATE CODES AND REQUIREMENTS.
- DRAWING PLANS, SCHEMATICS, AND DIAGRAMS INDICATE GENERAL LOCATION AND ARRANGEMENT OF DUCT SYSTEM. INDICATED DUCT LOCATIONS, CONFIGURATIONS, AND ARRANGEMENTS WERE USED TO SIZE DUCTS AND CALCULATE FRICTION LOSS FOR AIR-HANDLING EQUIPMENT SIZING AND FOR OTHER DESIGN CONSIDERATIONS. INSTALL DUCT SYSTEMS AS INDICATED UNLESS DEVIATIONS TO LAYOUT ARE APPROVED BY ARCHITECT/ENGINEER.
- ALL DUCT DIMENSIONS INDICATED ARE INTERIOR FREE AREA DUCT DIMENSIONS AND DO NOT INCLUDE INSULATION REQUIREMENTS.
- SEAL ALL WALL AND FLOOR DUCT PENETRATIONS. PROVIDE FIRE CAULKING ASSEMBLIES FOR PENETRATIONS OF RATED ASSEMBLIES. REFER TO ARCHITECTURAL DRAWINGS FOR ASSEMBLY RATINGS.
- CONTINUE DUCT AND PIPE INSULATION THROUGH WALLS, FLOORS, AND CEILING PENETRATIONS UNBROKEN, EXCEPT WHERE FIRE OR FIRE/SMOKE DAMPERS ARE INSTALLED IN DUCTWORK. SEAL AROUND DUCT INSULATION AT WALL PENETRATIONS.

MECHANICAL ABBREVIATIONS

ABSOR	ABSORPTION	FT	FINTUBE
ACU	AIR CONDITIONING UNIT	FTG	FOOTING
AD	ACCESS DOOR OR AREA DRAIN	GA	GAGE
AFB	ABOVE FINISHED FLOOR	GAL	GALLON
AFG	ABOVE FINISHED GRADE	GALV	GALVANIZED
AHU	AIR HANDLING UNIT	GC	GENERAL CONTRACTOR
AV	AIR VENT	GI	GREASE INTERCEPTOR
BOT	BOTTOM	GW	GREASE WASTE
BTU	BRITISH THERMAL UNIT	GPH	GALLONS PER HOUR
BTUH	BTU PER HOUR	GPM	GALLONS PER MINUTE
BV	BALL VALVE	HR	HOUR
CA	COMPRESSED AIR	HTG	HEATING
CB	CATCH BASIN	HB	HOSE BIBB
CENT	CENTRIFUGAL	ISP	INTERNAL STATIC PRESSURE
CFM	CUBIC FEET PER MINUTE	JAN	JANITOR RECEPTOR
CI	CAST IRON	LAV	LAVATORY
CL	CENTER LINE	LDBT	LEAVING DRY BULB
COND	CONDENSATE	LWT	TEMPERATURE
CO	CLEAN OUT	MC	MECHANICAL CONTRACTOR
CONC	CONCRETE	MB	MOP BASIN
CONTR	CONTRACTOR	MBH	1000 BTUH
CONDTR	CONDENSATE PUMP/CIRC. PUMP	MC	MECHANICAL CONTRACTOR
CU	COPPER	MECH	MECHANICAL
CUH	CABINET UNIT HEATER	MH	MANHOLE
CWP	CIRCULATING WATER PUMP	NTS	NOT TO SCALE
DDC	DIRECT DIGITAL CONTROLS	OA	OUTSIDE AIR
DN	DOWN	OD	OVERFLOW ROOF DRAIN
DR	DRAIN	PC	PLUMBING CONTRACTOR
DS	DOWNSPOUT	PSI	POUNDS PER SQUARE INCH
EA	EXHAUST AIR	PRV	POWER ROOF VENTILATOR
EAT	EXHAUST AIR TEMPERATURE	PRV	PRESSURE REDUCING VALVE
EC	ELECTRICAL CONTRACTOR	PV	PRESSURE VENT
EDBT	ENTERING DRY BULB	PVC	POLYVINYL CHLORIDE
EEW	EMERGENCY EYE WASH	RA	RETURN AIR
EF	EXHAUST FAN	RD	ROOF DRAIN
EJ	EXPANSION JOINT	RH	RELATIVE HUMIDITY
EQUIP	EQUIPMENT	RTU	ROOF TOP UNIT
ESE	EMERGENCY SHOWER/EYEWASH	RV	RELIEF VALVE
EST	EXTERNAL STATIC PRESSURE	RV	ROOF VENT TERMINATION
EWBT	ENTERING WET BULB	SA	SUPPLY AIR
EWC	ELECTRIC WATER COOLER	SK	SINK
EWT	ENTERING WATER	SV	SHOWER
EX	EXISTING	SH	STORM OVERFLOW
EXH	EXHAUST	SSE	SPLIT SYSTEM EVAPORATOR
EXP	EXPANSION	SSC	SPLIT SYSTEM CONDENSER
FAI	FRESH AIR INTAKE	ST	STORM
FCU	FAN COIL UNIT	TCC	TEMPERATURE CONTROL
FD	FLOOR DRAIN	CONTR	CONTRACTOR
FDC	FIRE DEPARTMENT CONNECTION	TYP	TYPICAL
FLEX	FLEXIBLE	UH	UNIT HEATER
FLR	FLOOR	UR	URINAL
FS	FEET PER MINUTE	UV	UNIT VENTILATOR
FPM	FEET PER MINUTE	VA	VENTILATION AIR
FPS	FEET PER SECOND	VB	VENT THROUGH ROOF
FS	FLOOR SINK	WB	WALL BOX - CONDENSATE
FSEC	FOOD SERVICE EQUIPMENT CONSULTANT	WC	WATER CLOSET
		WHA	WATER HAMMER ARRESTOR
		WH	WATER HEATER

MECHANICAL - GENERAL NOTES

- COORDINATE MECHANICAL AND ELECTRICAL WORK WITH ALL OTHER TRADES. BEGIN INSTALLATION AND ROUGH-IN AFTER COORDINATION WITH ALL TRADES ASSOCIATED WITH THE INSTALLATION IS COMPLETE. COORDINATE BUILDING STRUCTURE, ARCHITECTURAL ASSEMBLIES, SHEET METAL, ALL PIPING SYSTEMS, LIGHT FIXTURES, CONDUITS, CABLE TRAYS, ETC. REFER TO ALL GENERAL, MECHANICAL AND ELECTRICAL DRAWINGS AND SPECIFICATIONS FOR THIS PROJECT. CONTRACTOR IS RESPONSIBLE FOR REWORK ASSOCIATED WITH FAILURE TO COORDINATE.
- INCORPORATE MECHANICAL SPECIFICATIONS, DRAWINGS, STATE AND LOCAL CODES, AND OWNER STANDARDS INTO WORK.
- WARNING - CALL 48 HOURS BEFORE YOU DIG: LAW REQUIRES ANYONE DOING ANY EXCAVATION, FENCING, PLANTING OR DRILLING TO CALL 48 HOURS IN ADVANCE. HAND DIG WITHIN 18 INCHES OF ANY LOCATE MARK OR FLAG. ONE CALL 811.
- REFER TO ARCHITECTURAL SPECIFICATIONS FOR THROUGH-PENETRATION FIRESTOPPING AND TO ARCHITECTURAL CODE PLAN FOR FIRE RATED WALLS, FLOORS, AND CEILINGS. EACH TRADE IS RESPONSIBLE TO FIRESTOP PENETRATIONS THROUGH RATED ASSEMBLIES.
- EACH TRADE IS RESPONSIBLE FOR MAKING PENETRATIONS WHERE REQUIRED IN EXISTING WALLS, FLOORS, CEILINGS, AND ROOFS. MAKE PENETRATIONS NEAT, PATCH, CONCEAL, OR CAULK OVERCUT.
- COVER EXPOSED WALL PENETRATIONS WITH ESCUTCHEONS OR SHEET METAL AS APPROPRIATE.
- CAULK ALL CONCEALED AND EXPOSED PIPING AND DUCT WALL PENETRATIONS TO PREVENT NOISE TRANSFER BETWEEN SPACES.
- CREATE OPENINGS IN THE BUILDING THAT ARE REQUIRED TO REMOVE EXISTING ITEMS AND TO BRING IN NEW EQUIPMENT. PATCH ALL OPENINGS CREATED AND FINISHED WITH MATERIALS TO MATCH EXISTING CONDITIONS. INCLUDE THIS WORK IN BID.



GENERAL NOTE:

UNDERGROUND FACILITIES, STRUCTURES, AND UTILITIES HAVE BEEN SHOWN BASED UPON INFORMATION OBTAINED FROM FIELD LOCATIONS BY UTILITY COMPANIES, AVAILABLE SURVEYS AND RECORDS. THEIR LOCATIONS MUST BE CONSIDERED APPROXIMATE ONLY. IT IS ALSO POSSIBLE THAT THERE MAY BE OTHER UNDERGROUND FACILITIES, STRUCTURES, AND UTILITIES IN EXISTENCE THAT ARE NOT SHOWN. IT IS THE RESPONSIBILITY OF EACH INDIVIDUAL PARTY REFERENCING THIS PLAN TO DETERMINE THE EXACT LOCATION AND TYPE OF UNDERGROUND FACILITIES ON THE SITE. HAND EXCAVATE AT CRITICAL POINTS AS NECESSARY TO VERIFY LOCATIONS, SIZES, ELEVATIONS, FLOW LINES, ETC. IF A PROBLEM OR INTERFERENCE EXISTS, NOTIFY ARCHITECT/ENGINEER BEFORE PROCEEDING.

PIPING LEGEND - PLUMBING

CW	---	DOMESTIC COLD WATER
HW	---	DOMESTIC HOT WATER
DSW	---	DOMESTIC SOFT WATER
GW	---	GREASE WASTE
G	---	NATURAL GAS
GV	---	NATURAL GAS VENT
RHW	---	RECIRCULATING HOT WATER
SAN	---	SANITARY
ST	---	STORM
SO	---	STORM OVERFLOW
P	---	TRAP PRIMER
V	---	VENT

PIPE FITTINGS

SINGLE LINE	DOUBLE LINE
ELBOW	ELBOW
ELBOW - DOUBLE BRANCH	ELBOW - DOUBLE BRANCH
ELBOW - OUTLET DOWN	ELBOW - OUTLET DOWN
ELBOW - OUTLET UP	ELBOW - OUTLET UP
ELBOW - LONG RADIUS	ELBOW - LONG RADIUS
ELBOW - SHORT RADIUS	ELBOW - SHORT RADIUS
45° ELBOW	45° ELBOW
TEE - VENT	TEE - VENT
TEE - SANITARY	TEE - SANITARY
TEE - OUTLET DOWN	TEE - OUTLET DOWN
TEE - OUTLET UP	TEE - OUTLET UP
TEE - SIDE OUTLET DOWN	TEE - SIDE OUTLET DOWN
TEE - SIDE OUTLET UP	TEE - SIDE OUTLET UP
CROSS - VENT	CROSS - VENT
CROSS - SANITARY	CROSS - SANITARY
LATERAL	LATERAL
TEE - SINGLE SWEEP "COMBO WYE"	TEE - SINGLE SWEEP "COMBO WYE"
REDUCER - CONCENTRIC	REDUCER - CONCENTRIC
REDUCER - ECCENTRIC	REDUCER - ECCENTRIC
CAPPED CONNECTION	CAPPED CONNECTION
FLANGED CONNECTION	FLANGED CONNECTION

PLUMBING ACCESSORY LEGEND

HB	HOSE BIBB
RH	ROOF HYDRANT
CO	CLEAN OUT
FCO	FLOOR CLEAN OUT
FD	FLOOR DRAIN
# VTR	VENT THRU ROOF (# DENOTES PIPE DIAMETER)
RD / ORD	ROOF DRAIN / OVERFLOW ROOF DRAIN
RD	COMBO ROOF/OVERFLOW DRAIN
LT	LAMB TONGUE
BACKFLOW PREVENTER	BACKFLOW PREVENTER
VALVE - BALL / SHUT-OFF	VALVE - BALL / SHUT-OFF
CHECK VALVE	CHECK VALVE

NOTE: ALL SYMBOLS MAY NOT APPLY TO THIS PROJECT

GENERAL SYMBOLS

	EXISTING = HALFTONE LINEWORK
	NEW = DARK LINEWORK
	DEMO = DASHED DARK LINEWORK
	BELOW GRADE = LONG DASHED DARK LINEWORK
	NEW CONNECTION POINT
	POINT OF DISCONNECT
	KEYNOTE
	EQUIPMENT IDENTIFICATION TAG
	DETAIL DRAWING REFERENCE TAG, SIM-SIMILAR, TYP-TYPICAL, OPP-OPPOSITE SHEET REFERENCE
	SECTION CUT REFERENCE TAG, SIM-SIMILAR, TYP-TYPICAL, OPP-OPPOSITE SHEET REFERENCE
	INTERIOR ELEVATION DRAWING REFERENCE TAG

H.V.A.C. / DUCTWORK SYMBOLS

RECT.	RND.	OVAL	
			SUPPLY (SA), OUTSIDE (OA), VENTILATION (VA) AIR DUCT (UP / DOWN / SECTION)
			RETURN (RA) AIR DUCT (UP / DOWN / SECTION)
			EXHAUST (EA) AIR DUCT (UP / DOWN / SECTION)
			RECTANGULAR DUCT (WIDTH / HEIGHT / SYSTEM)
			ROUND DUCT (DIAMETER / SYSTEM)
			FLAT OVAL DUCT (WIDTH / HEIGHT / SYSTEM)
			SUPPLY DIFFUSER
			SUPPLY REGISTER OR GRILLE
			LINEAR SLOT DIFFUSER
			RETURN REGISTER OR GRILLE
			EXHAUST REGISTER OR GRILLE
			DUCT ACCESS DOOR
			DUCT END CAP
			TURNING VANES
			VAV TERMINAL UNIT
			FLEXIBLE DUCTWORK
			ELEVATION CHANGE (RISE OR DROP)
			HIGH EFF. TAKE OFF FITTING w/ VOLUME DAMPER
			BACKDRAFT DAMPER
			OPPOSED BLADE DAMPER
			PARALLEL BLADE DAMPER
			VOLUME DAMPER
			FIRE DAMPER
			SMOKE DAMPER
			FIRE/SMOKE DAMPER
			MOTORIZED ACTUATOR
			THERMOSTAT
			EXISTING HVAC EMERGENCY SHUTDOWN SWITCH/LIGHT
			SIDE WALL DIFFUSER
			ROUND DIFFUSER
			EXTERIOR LOUVER
			FIXTURE IDENTIFICATION TAG NECK SIZE / CFM



100 Court Ave., Suite 100
Des Moines, IA 50309
P: 515-309-0722
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Owner:

STATE OF IOWA - DEPARTMENT OF ADMINISTRATIVE SERVICES

1305 E WALNUT ST
DES MOINES, IA 50319

Project:

9411.00 - 6200 PARK ALI
WORKMAN'S CAMP RENOVATION
6200 PARK AVE
DES MOINES, IA 50321

Construction Manager:

220 SE 6TH ST - SUITE 200
DES MOINES, IA 50309
P. 515-244-5043

Civil Engineer:

CIVIL ENGINEERING
CONSULTANT UNIT 12
DES MOINES, IA 50322
P. 515-276-7084

Structural Engineer:

RAKER RHODES ENGINEERING
4717 GRAND AVE
DES MOINES, IA 50312
P. 515-277-0275

Mechanical Engineer:

KCL ENGINEERING
300 4TH ST
WEST DES MOINES, IA 50265
P. 515-724-7938

Electrical Engineer:

KCL ENGINEERING
300 4TH ST
WEST DES MOINES, IA 50265
P. 515-724-7938

Key Plan:

Revision	Description	Date
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24816000


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Sheet Name:

MECHANICAL GENERAL
NOTES & SYMBOLS

Sheet Number:

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MECHANICAL DEMOLITION PLAN
1/8" = 1'-0"

- GENERAL NOTES:**
- REFER TO M000 FOR GENERAL NOTES & SYMBOLS.
 - PATCH WALLS, ROOFS, AND/OR FLOOR WHERE DUCTS, GRILLES, PIPES, OR EQUIPMENT ARE REMOVED. PAINT OR FINISH TO MATCH ORIGINAL CONSTRUCTION.
 - WHERE DUCTWORK IS REMOVED, REMOVE ALL ASSOCIATED SUPPORTS.
 - WHERE EQUIPMENT IS REMOVED, REMOVE ALL ASSOCIATED SUPPORTS, DUCTWORK, PIPING, AND CONTROLS.
 - WHERE CONTROLS ARE REMOVED, REMOVE ALL ASSOCIATED WIRING AND/OR PNEUMATIC TUBING. PATCH WALL OPENINGS AND PAINT OR FINISH TO MATCH ORIGINAL CONSTRUCTION. IN WALLS THAT CANNOT BE PATCHED, INSTALL STAINLESS STEEL COVER PLATE. ABANDON PNEUMATIC TUBING IN WALLS.

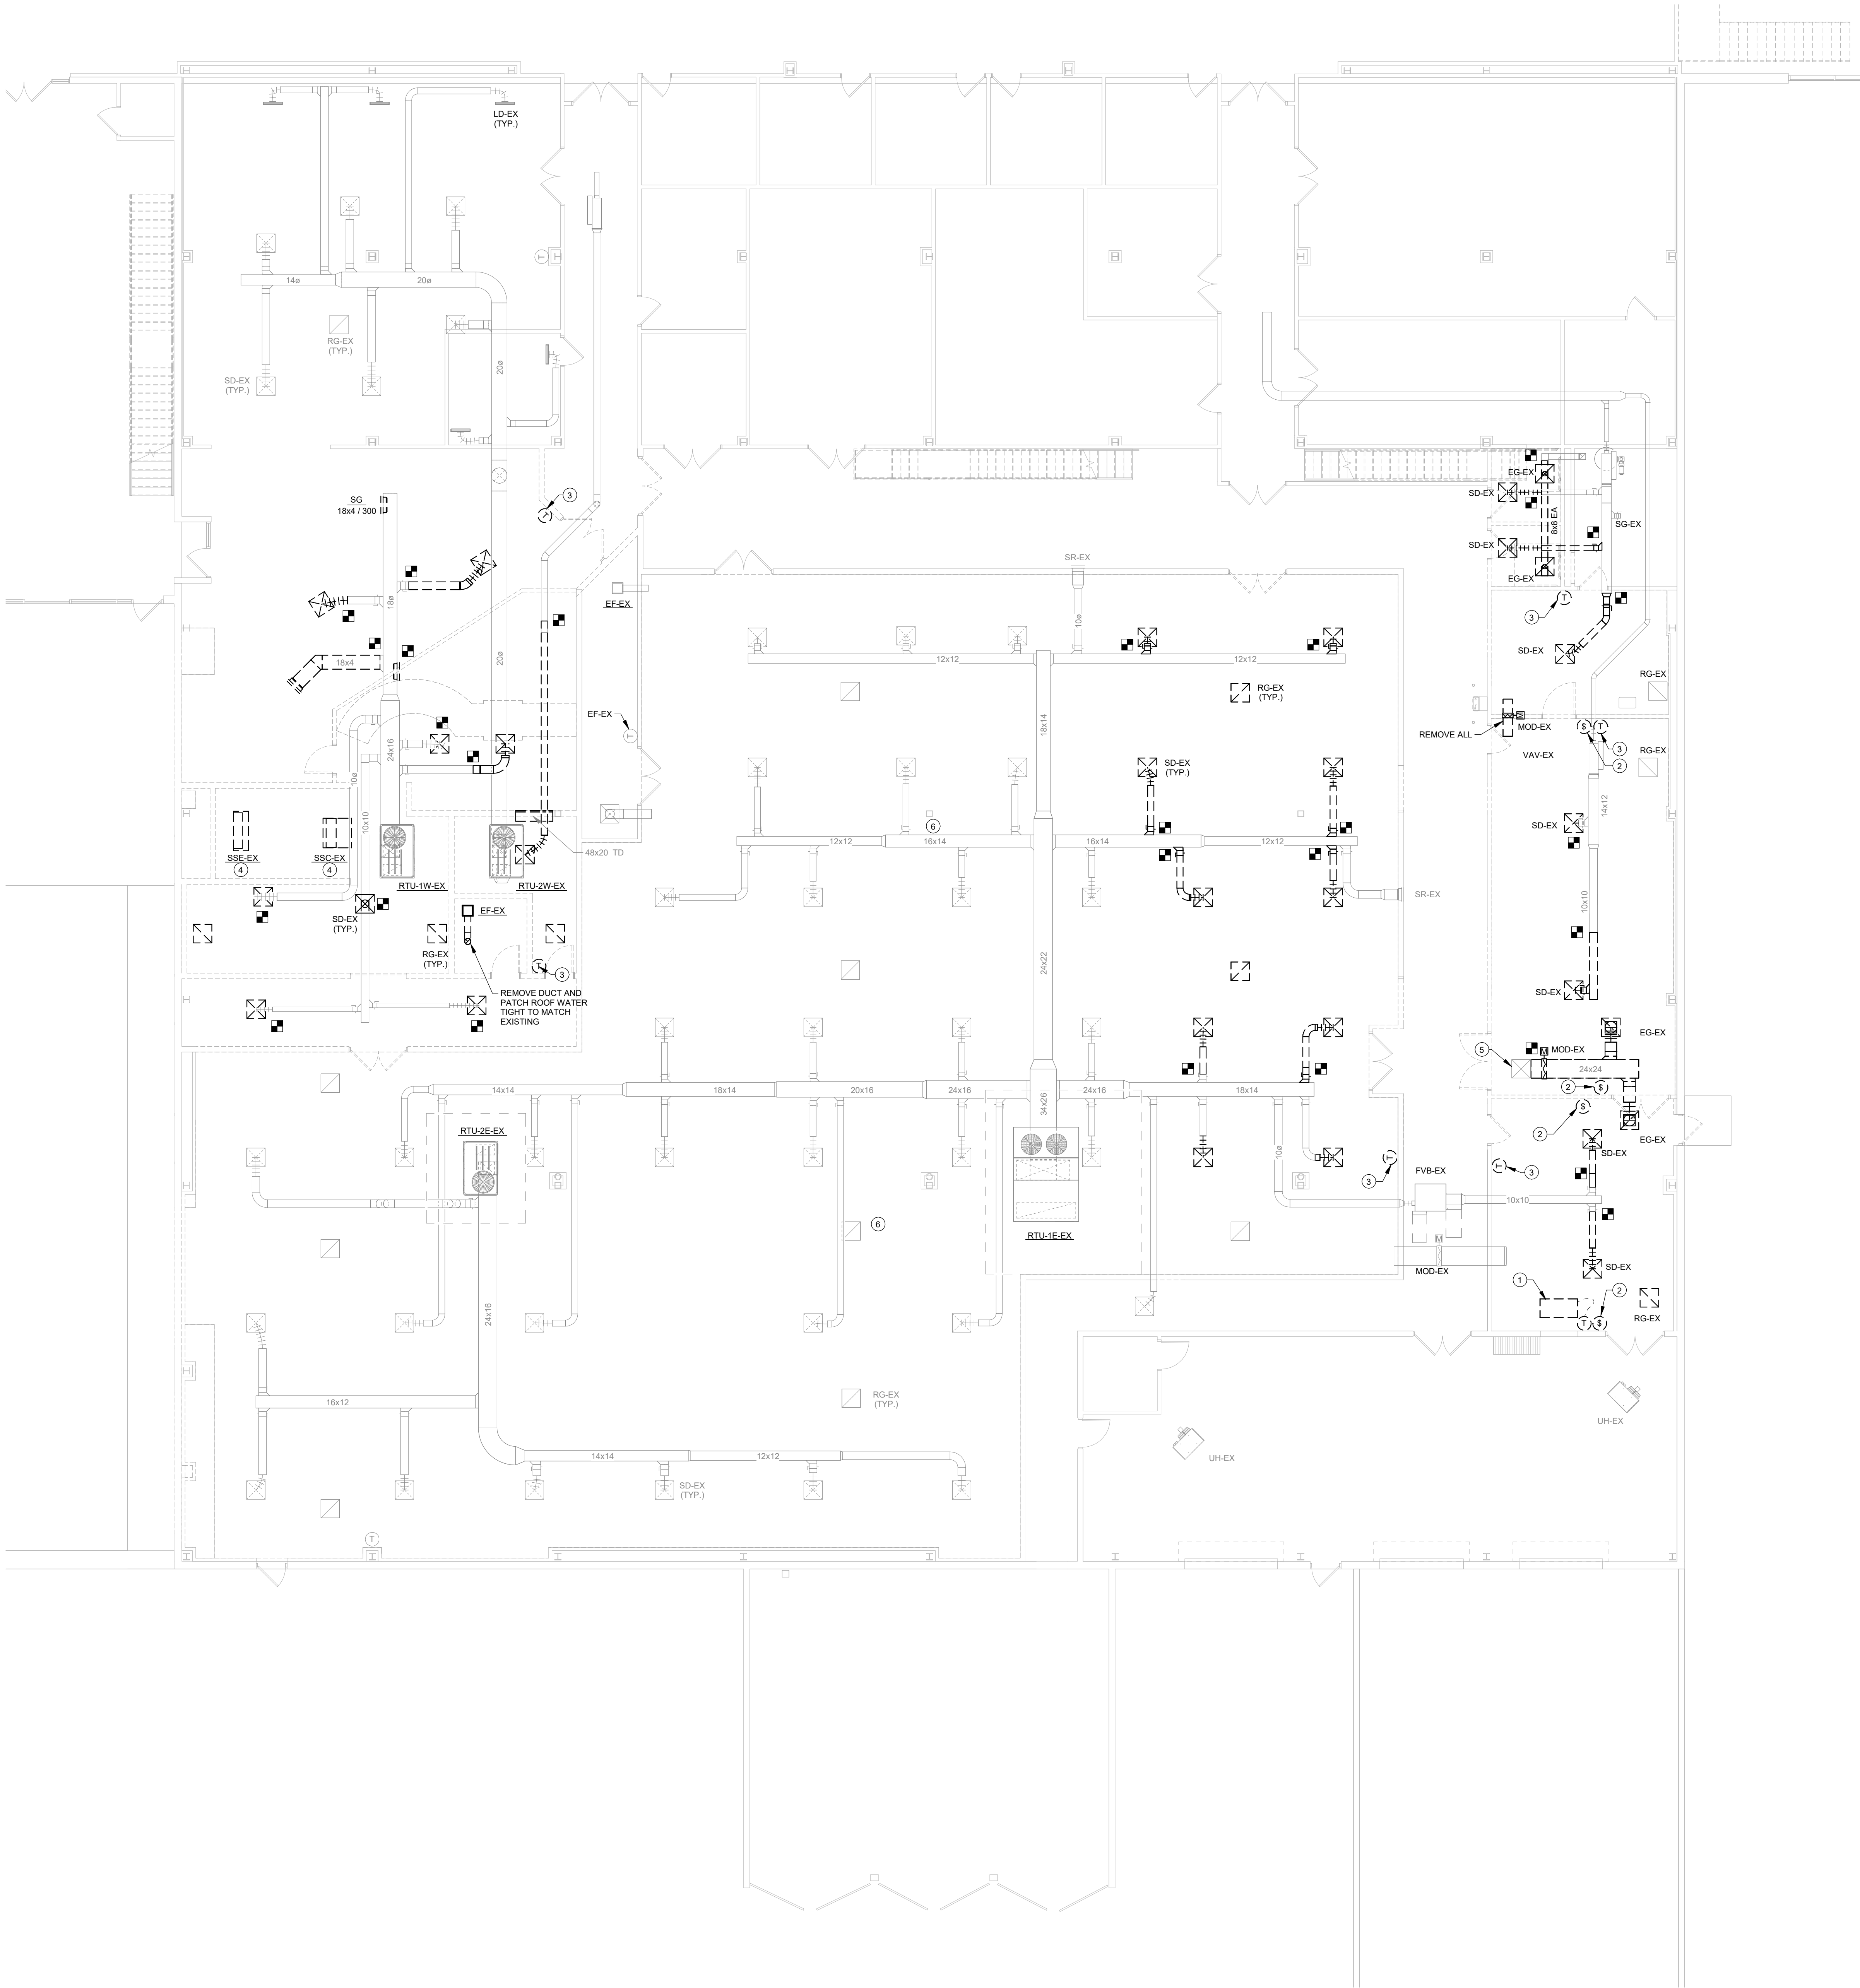- KEYNOTES**
- REMOVE EXISTING AIR CURTAIN ALONG WITH ASSOCIATED APPURTENANCES. SALVAGE AIR CURTAIN, THERMOSTAT AND ELECTRICAL DISCONNECT FOR OWNER.
 - REMOVE EXISTING EMERGENCY HVAC SYSTEM SHUTDOWN BUTTON AND ASSOCIATED STROBE LIGHT ALONG WITH ASSOCIATED APPURTENANCES.
 - REMOVE AND RELOCATE TEMPERATURE CONTROLS THERMOSTAT ASSOCIATED WITH THIS SPACE. PROVIDE NEW WIRING FOR NEW LOCATION. REFER TO M101 FOR NEW LOCATION.
 - REMOVE EXISTING WALK-IN COOLER REFRIGERATION SYSTEM ALONG WITH ASSOCIATED APPURTENANCES. PATCH ROOF PENETRATIONS WATER TIGHT AND MATCH EXISTING ROOF.
 - REMOVE EXISTING EXHAUST FAN ON ROOF ALONG WITH ASSOCIATED POWER AND CONTROLS. CAP REMAINING ROOF CURB PER DETAIL 5M301.
 -

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100 Court Ave., Suite 100
Des Moines, IA 50309
P: 515-309-0722
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1305 E WALNUT ST
DES MOINES, IA 50319

Project:
9411.00 - 6200 PARK ALI WORKMAN'S CAMP RENOVATION
6200 PARK AVE
DES MOINES, IA 50321

Construction Manager:
DCI GROUP
220 SE 6TH ST - SUITE 200
DES MOINES, IA 50309
P: 515-244-5043

Civil Engineer:
CIVIL ENGINEERING CONSULTANTS
2000 E 10TH ST UNIT 12
DES MOINES, IA 50322
P: 515-276-7084

Structural Engineer:
RAKER RHODES ENGINEERING
4717 GRAND AVE
DES MOINES, IA 50312
P: 515-027-0275


Mechanical Engineer:
KCL ENGINEERING
300 4TH ST
WEST DES MOINES, IA 50265
P: 515-724-7938

Electrical Engineer:
KCL ENGINEERING
300 4TH ST
WEST DES MOINES, IA 50265
P: 515-724-7938

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- GENERAL NOTES:**
- A. REFER TO M000 FOR GENERAL NOTES & SYMBOLS.
 - B. REFER TO M301 FOR MECHANICAL DETAILS.
 - C. REFER TO M501 FOR MECHANICAL SCHEDULES.
 - D. BRANCH DUCT SIZES TO AIR TERMINALS SHALL MATCH NECK SIZE OF GRILLE, REGISTER, OR DIFFUSER UNLESS NOTED OTHERWISE.
 - E. MAXIMUM FLEXIBLE DUCT LENGTH TO DIFFUSERS SHALL BE 60", WITH MAXIMUM OF ONE 90 DEGREE ELBOW.
- KEYNOTES**
- SERVICE AND INSPECT THIS RTU ACCORDINGLY TO ENSURE IT IS IN GOOD RUNNING CONDITION. ADJUST SETPOINTS AND SETBACKS ACCORDINGLY. TAB NEW DIFFUSER AIRFLOW AS SHOWN ON PLAN.
 - THIS RTU SHALL REMAIN AS IS AND OPERATIONAL. SERVICE AND INSPECT ACCORDINGLY TO ENSURE IT IS IN GOOD RUNNING CONDITION.

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P: 515-309-0722
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1305 E WALNUT ST
DES MOINES, IA 50319

Project:
9411.00 - 6200 PARK ALI WORKMAN'S CAMP RENOVATION
6200 PARK AVE
DES MOINES, IA 50321

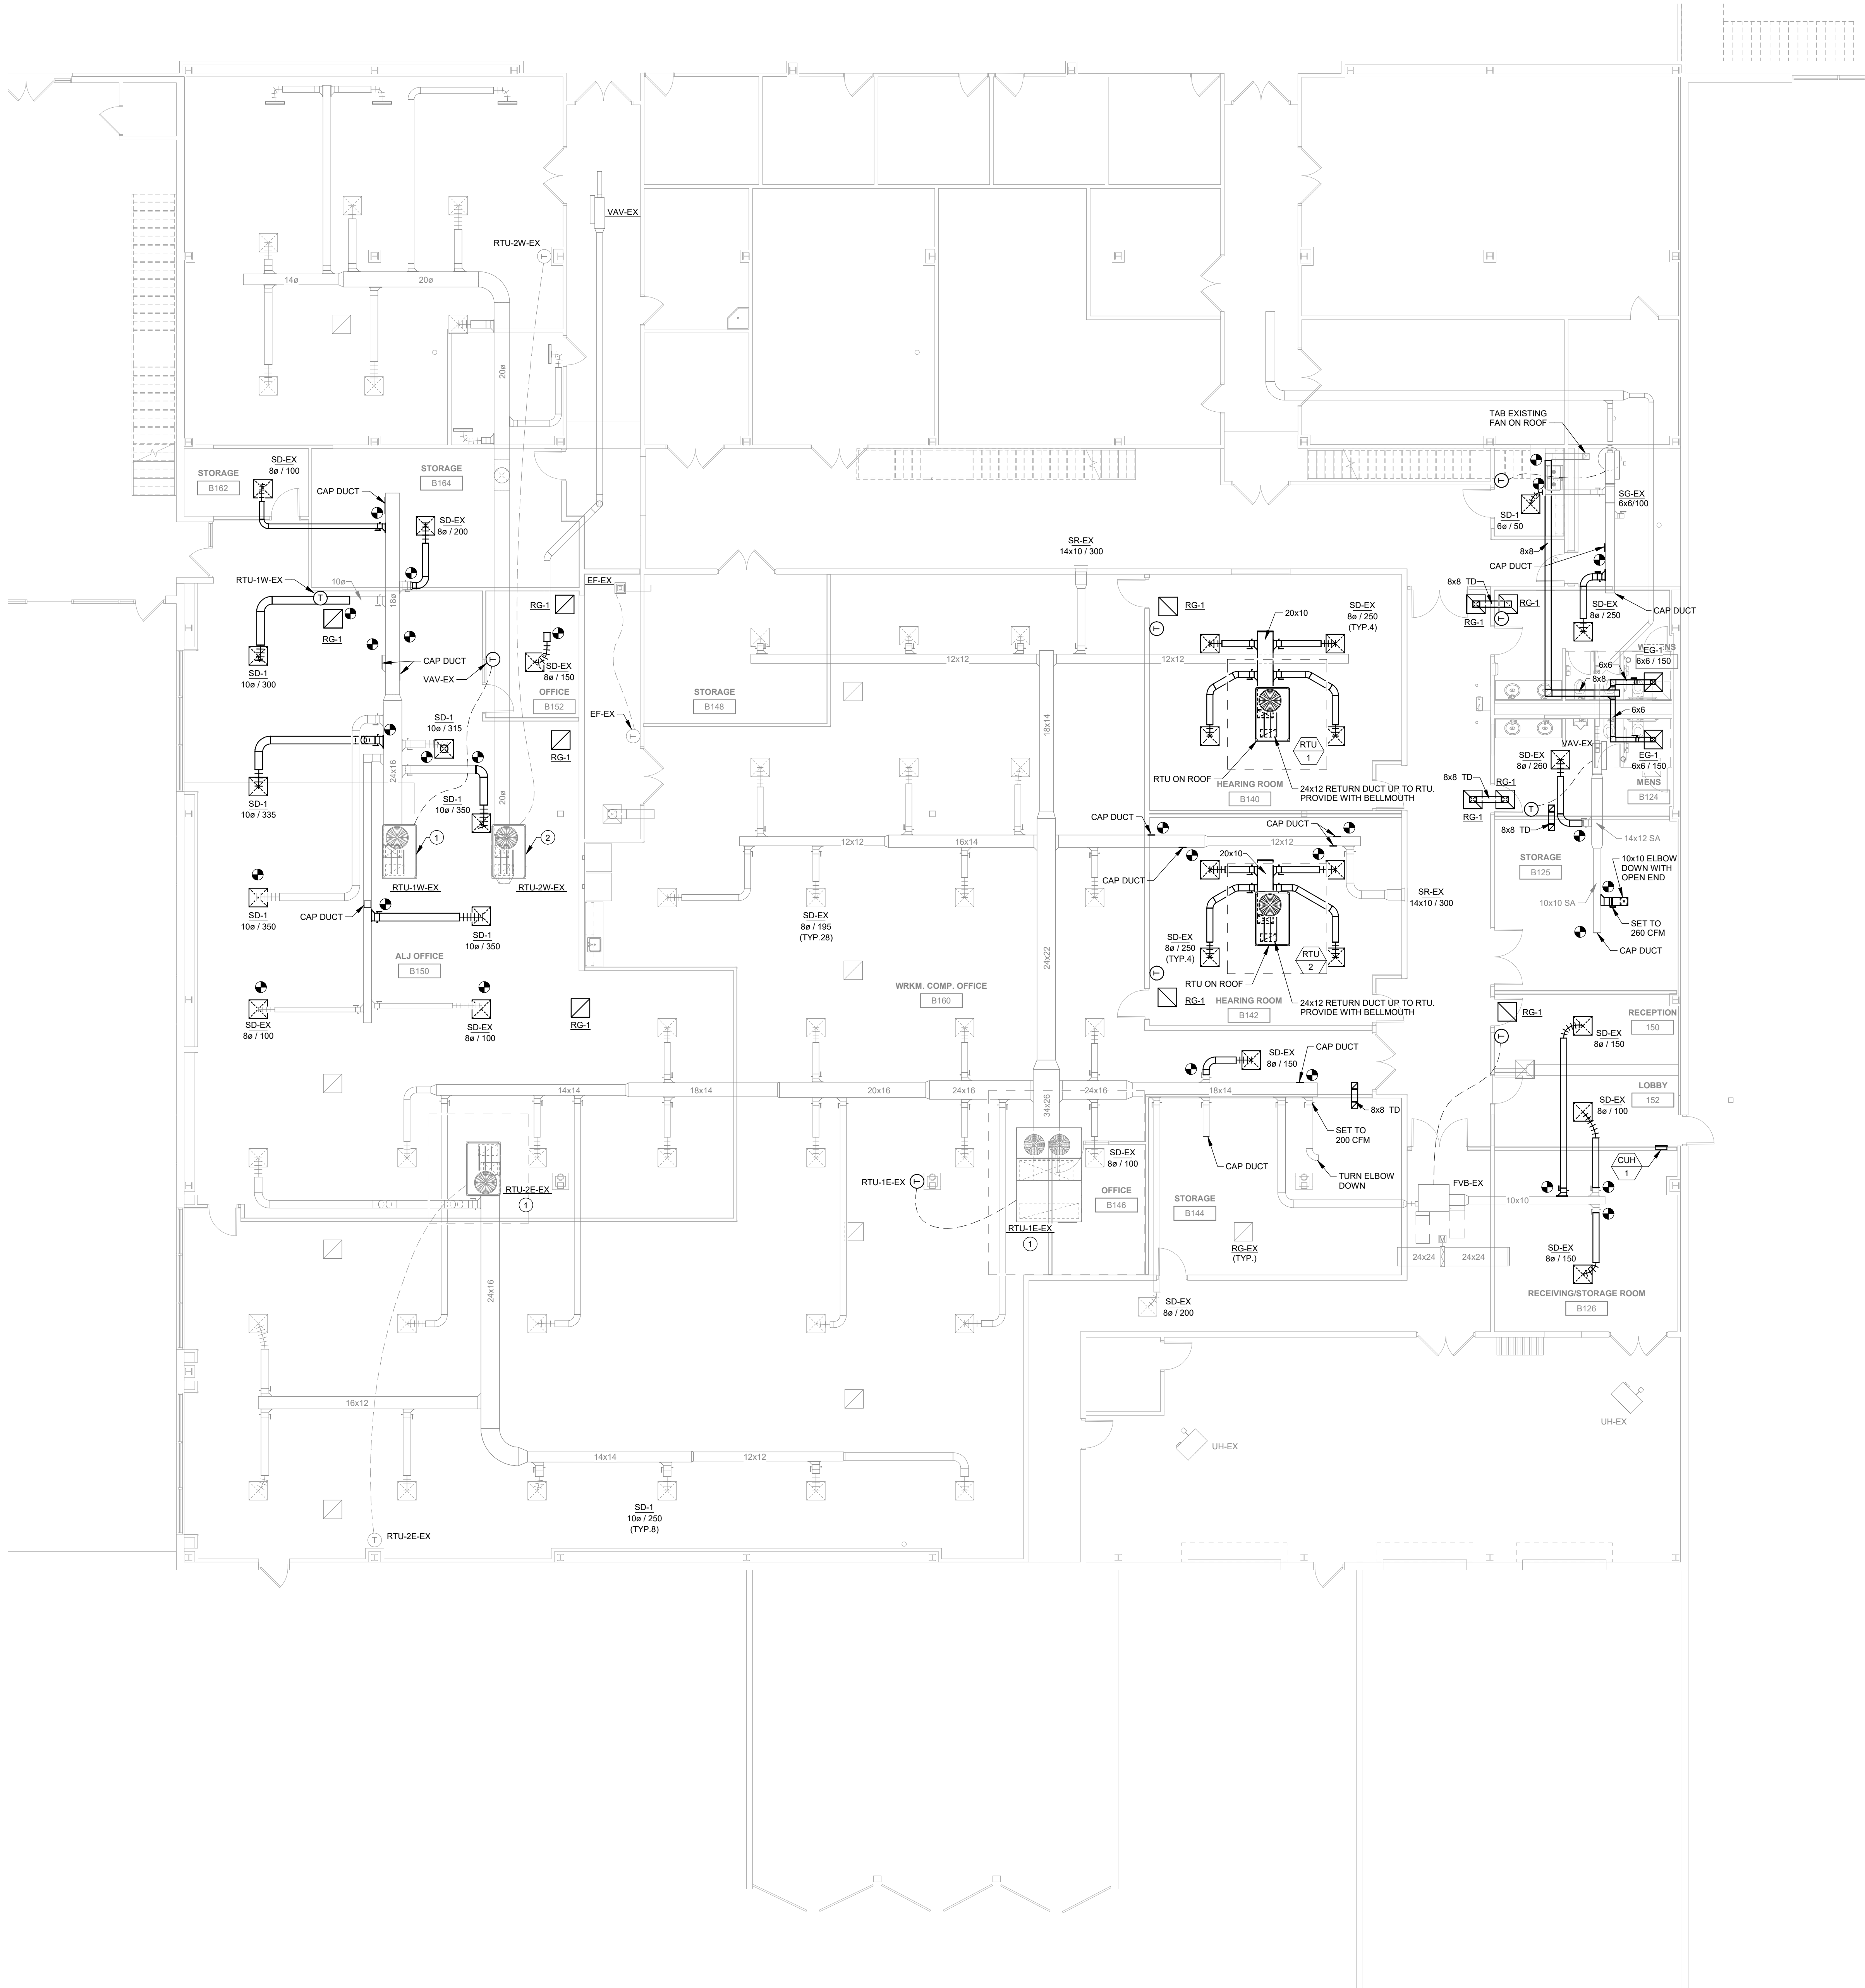Construction Manager:
DCI GROUP
220 SE 6TH ST - SUITE 200
DES MOINES, IA 50309
P: 515-244-5043

Civil Engineer:
CIVIL ENGINEERING CONSULTANTS
CONSULTANT UNIT 12
DES MOINES, IA 50322
P: 515-276-7084

Structural Engineer:
RAKER RHODES ENGINEERING
4717 GRAND AVE
DES MOINES, IA 50312
P: 515-277-0275

Mechanical Engineer:
KCL ENGINEERING
300 4TH ST
WEST DES MOINES, IA 50265
P: 515-724-7938

Electrical Engineer:
KCL ENGINEERING
300 4TH ST
WEST DES MOINES, IA 50265
P: 515-724-7938

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Revision	Description	Date
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OPN Project No.
24816000

Sheet Issue Date:
100% CONSTRUCTION
DRAWING SET
MECHANICAL HVAC PLAN

Sheet Name:
MECHANICAL HVAC PLAN

Sheet Number:
M101

8/16/24




D. WHERE PIPING, EQUIPMENT, AND PLUMBING FIXTURES ARE REMOVED, REMOVE ALL VALVES, SUPPORTS, INSULATION, AND APPURTENANCES. REMOVE PIPING BACK TO MAINS AND CAP. DO NOT LEAVE DEAD LEGS LONGER THAN 12".

300 4TH ST
WEST DES MOINES, IA 50265
P. 515-724-7938

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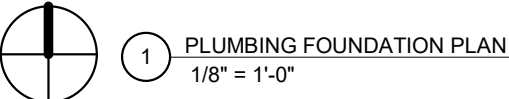
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1 PLUMBING DEMOLITION PLAN
1/8" = 1'-0"

- GENERAL NOTES:**
- A. REFER TO M000 FOR GENERAL NOTES & SYMBOLS.
 - B. PATCH WALLS, ROOFS, AND/OR FLOOR WHERE PIPES OR EQUIPMENT ARE REMOVED. PAINT OR FINISH TO MATCH ORIGINAL CONSTRUCTION.
 - C. NOTIFY DES MOINES WASTEWATER RECLAMATION AUTHORITY (WRA) OF DECOMMISSIONING OF THE EXISTING GREASE INTERCEPTOR PRIOR TO STARTING ANY WORK.
 - D. WHERE PIPING, EQUIPMENT, AND PLUMBING FIXTURES ARE REMOVED, REMOVE ALL VALVES, SUPPORTS, INSULATION, AND APPURTENANCES. REMOVE PIPING BACK TO MAINS AND CAP. DO NOT LEAVE DEAD LEGS LONGER THAN 12".

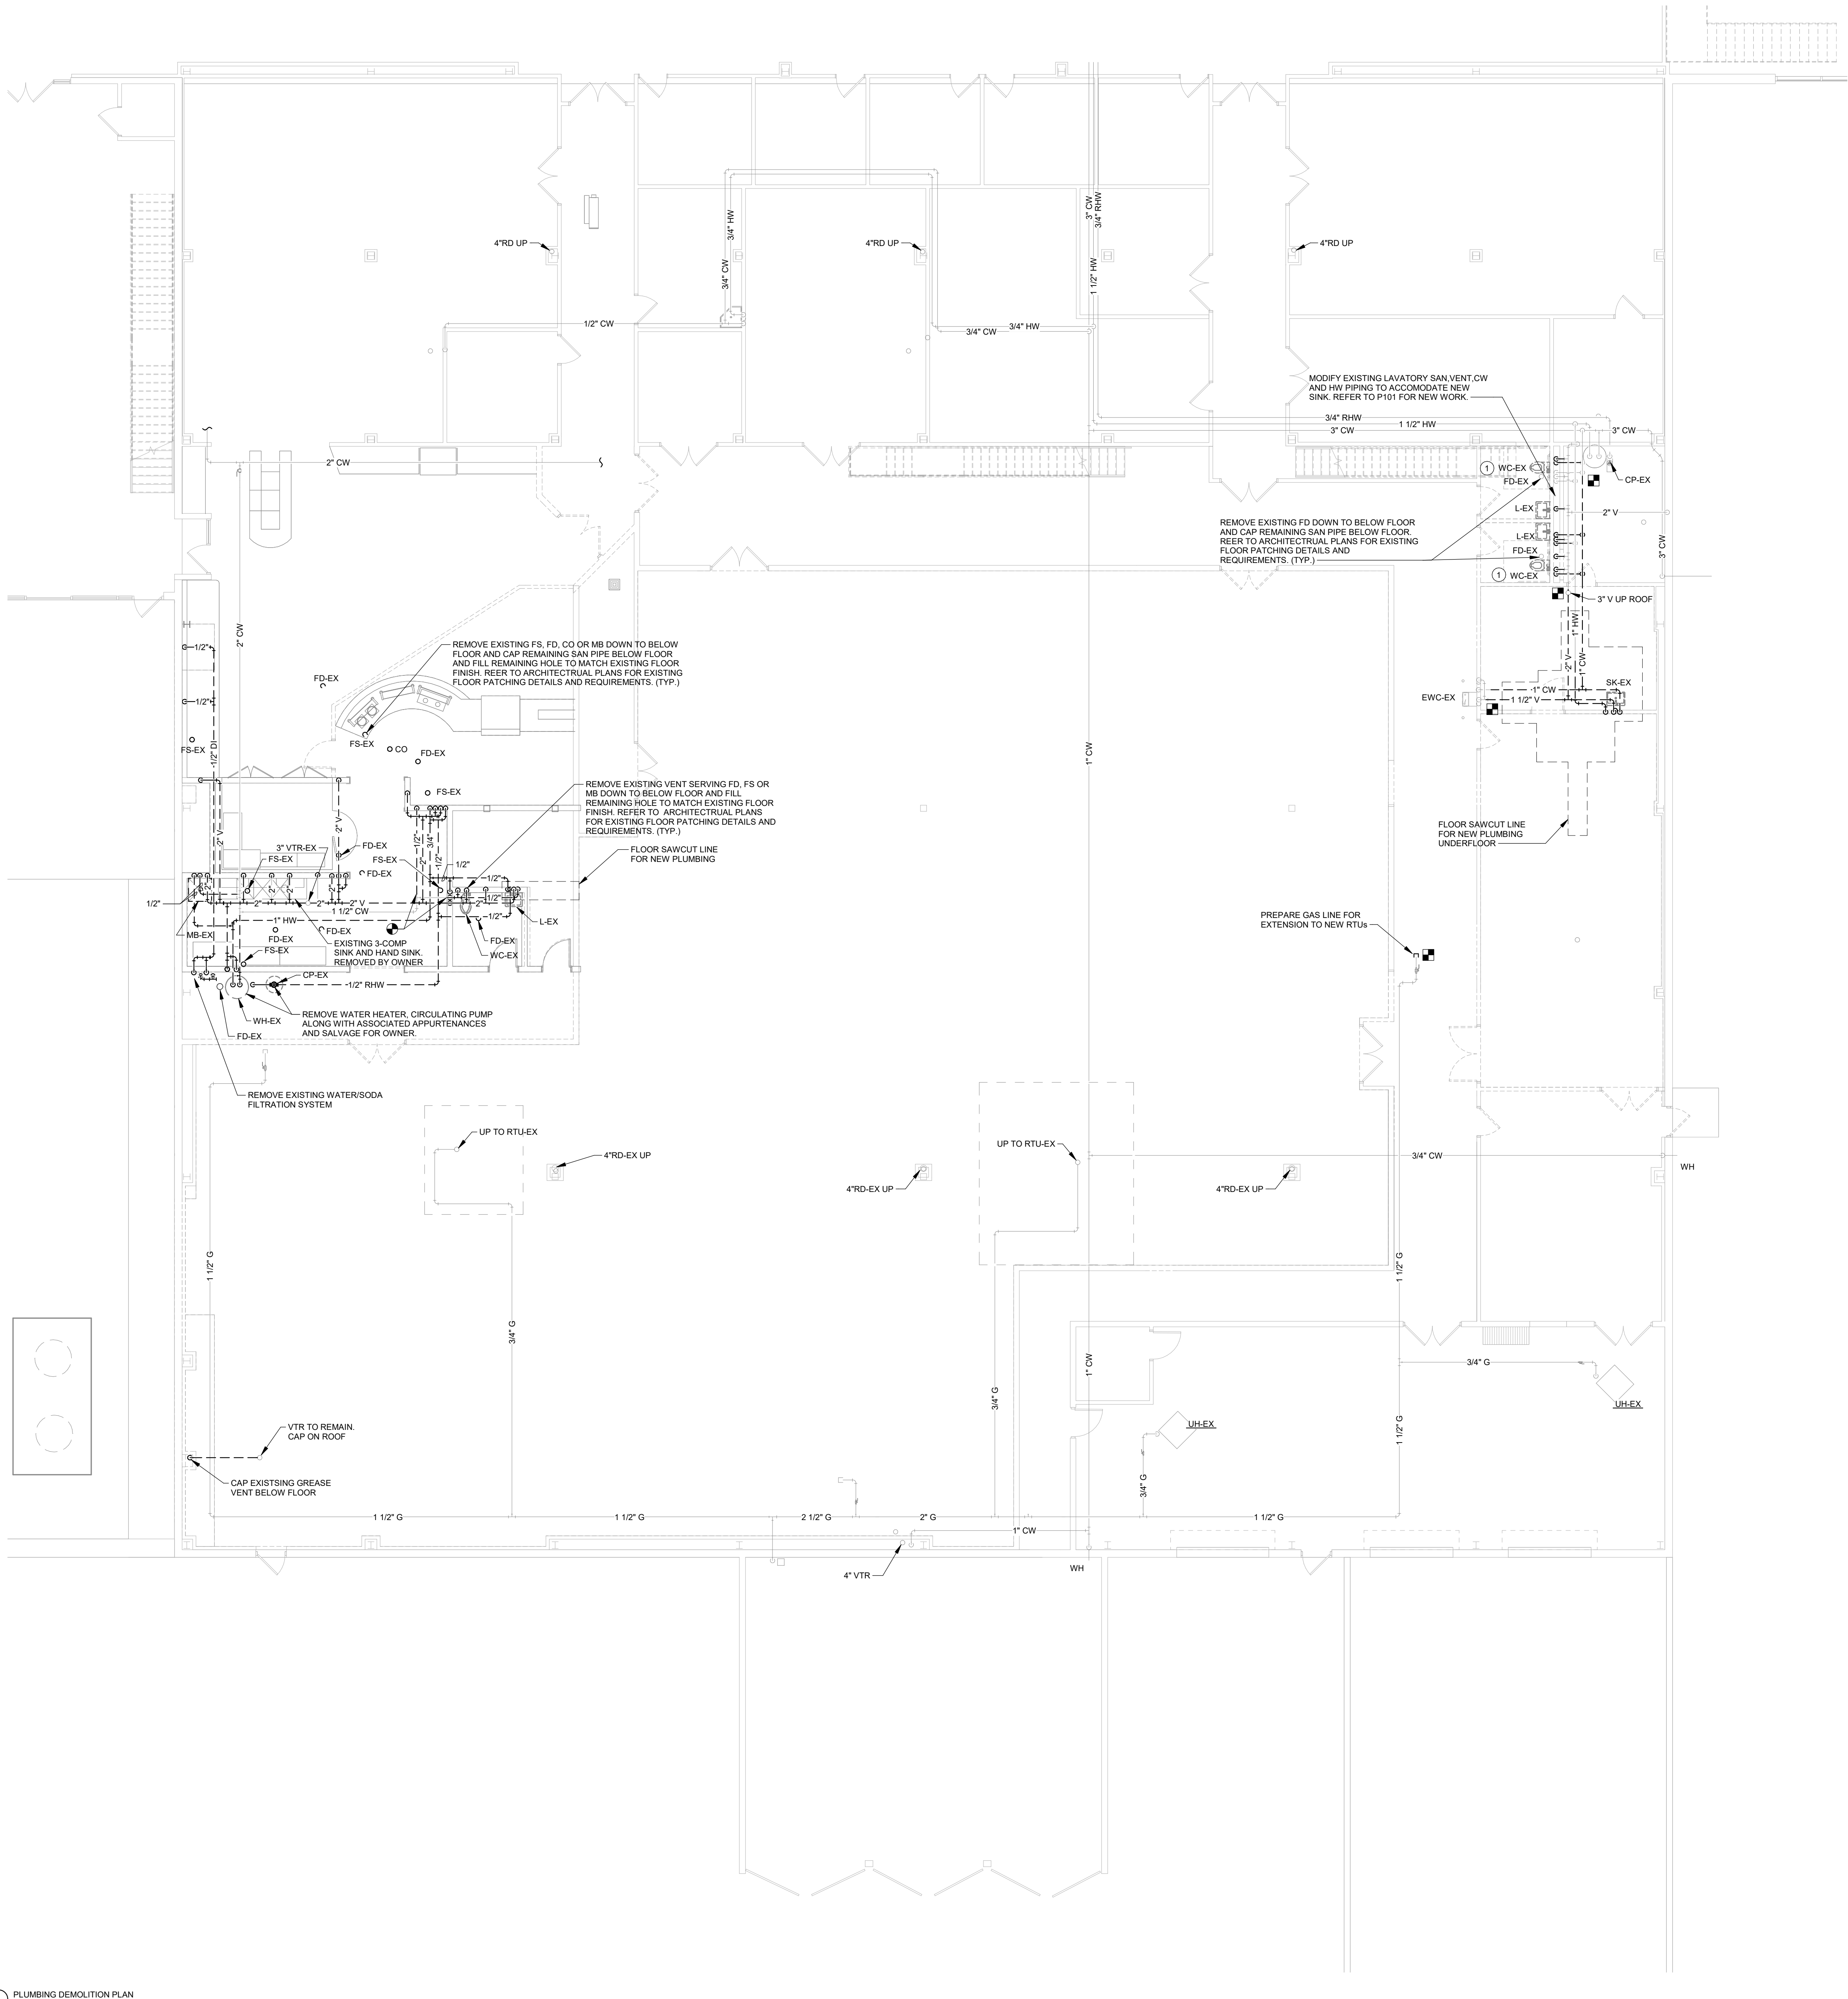- KEYNOTES** #
- 1 REMOVE EXISTING WATER CLOSET, SEAT AND FLUSH VALVE AND REUSE IN NEW LOCATION.




1 ROUTE TRAP PRIMER LINE TO FLOOR DRAIN

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P100


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- GENERAL NOTES:**
- A. REFER TO M000 FOR GENERAL NOTES & SYMBOLS.
 - B. REFER TO P301 FOR PLUMBING DETAILS.
 - C. REFER TO P501 FOR PLUMBING SCHEDULES.
 - D. REFER TO PLUMBING FIXTURE ROUGH-IN SCHEDULE FOR BRANCH PIPE SIZING TO INDIVIDUAL PLUMBING FIXTURES.
 - E. COORDINATE PIPE ROUTING WITH DUCTWORK. DUCTWORK HAS PRIORITY OVER PRESSURE PIPING.
 - F. BRANCH PIPING SHALL BE TAKEN OFF THE TOP OF MAIN PIPING.

KEYNOTES #

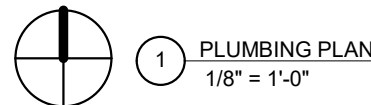- 1. INSTALL USED WATER CLOSET, SEAT AND FLUSH VALVE.
- 2. ROUTE TRAP PRIMER LINE TO FLOOR DRAIN.



2 ENLARGED PLAN - PLUMBING
1/4" = 1'-0"

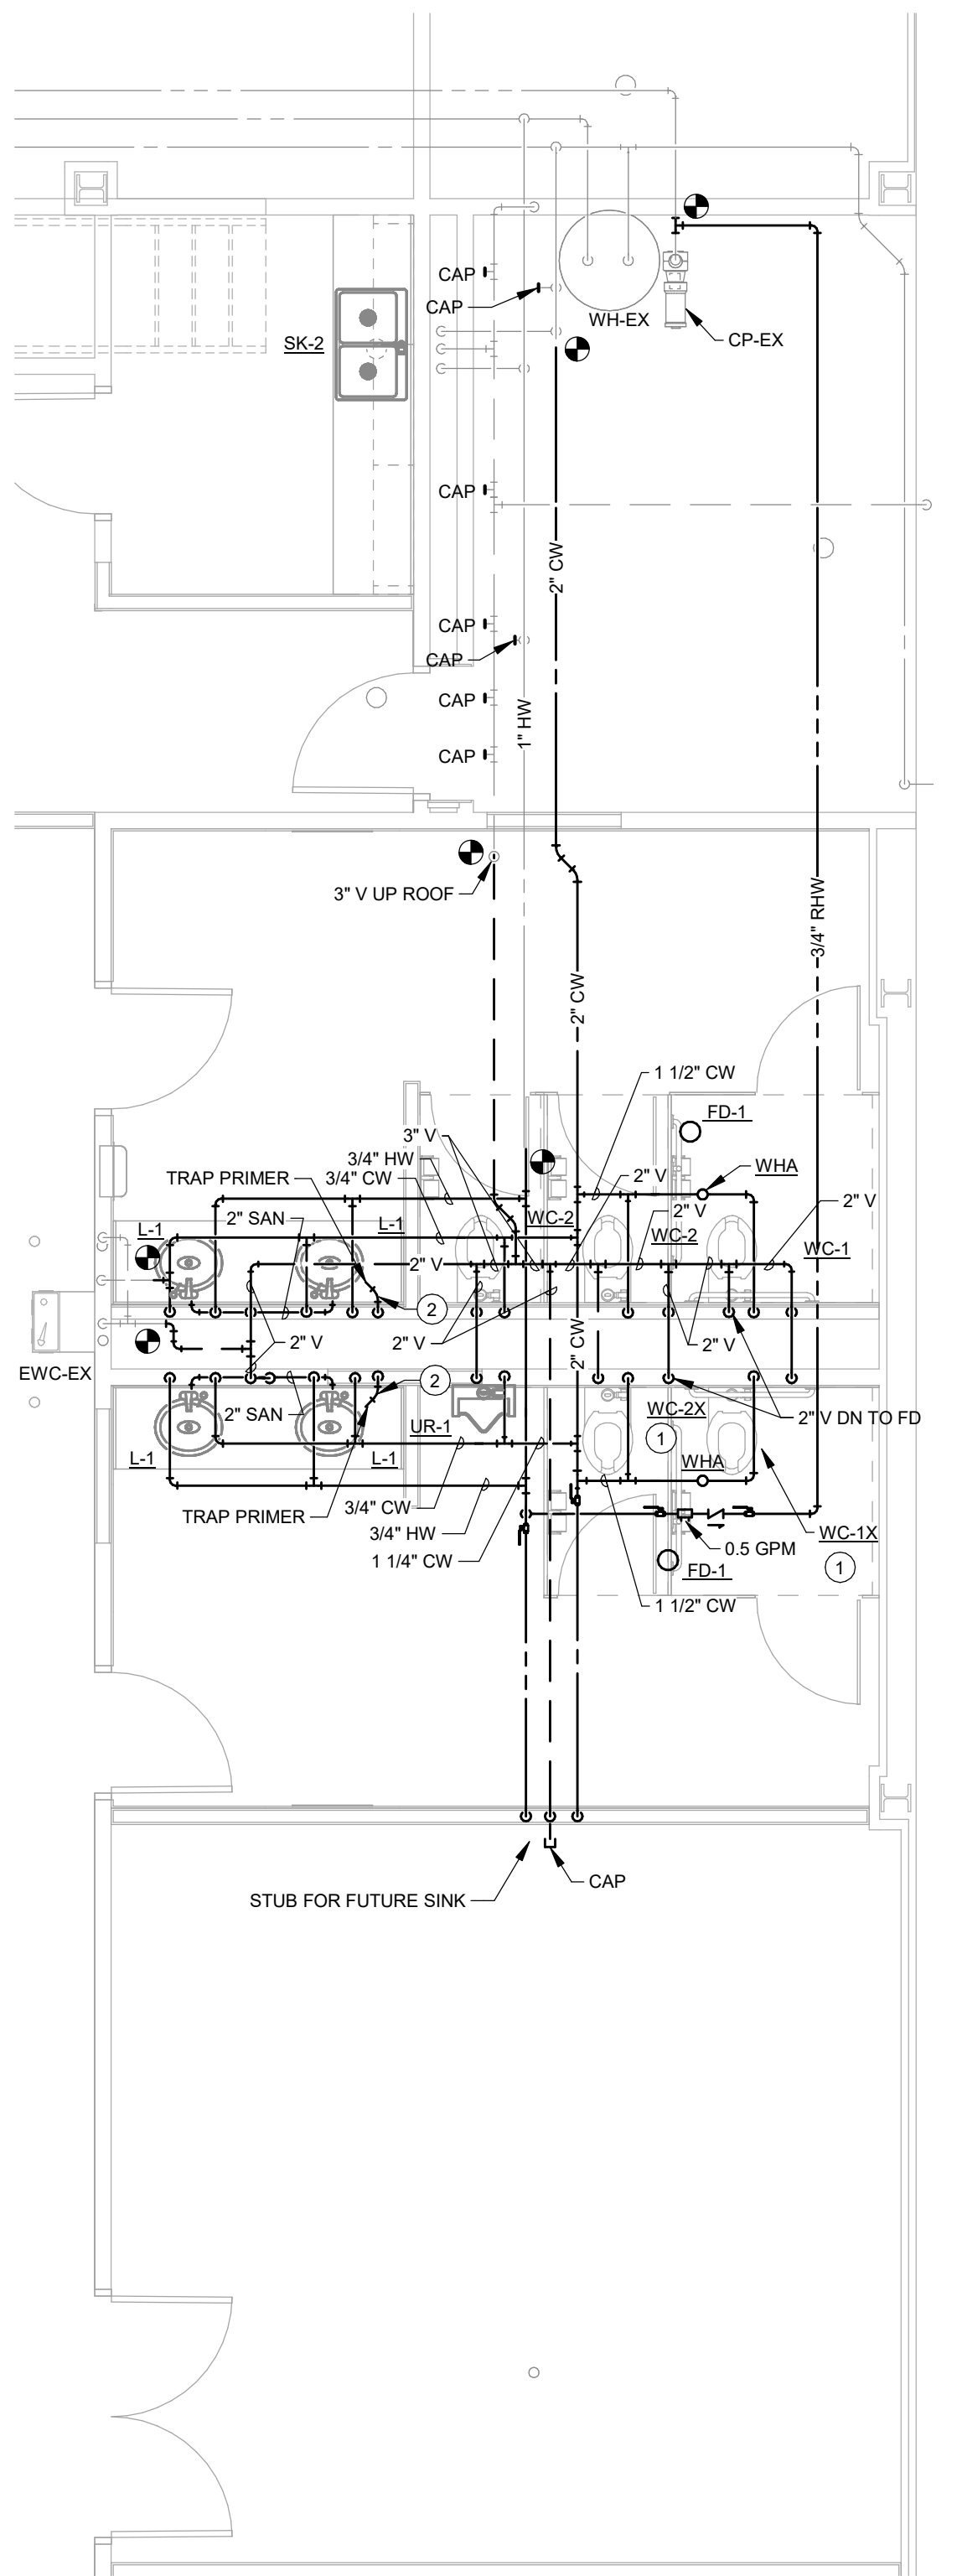

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Des Moines, IA 50309
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Owner
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1305 E WALNUT ST
DES MOINES, IA 50319

Project
9411.00 - 6200 PARK ALI WORKMAN'S CAMP RENOVATION
6200 PARK AVE
DES MOINES, IA 50321

Construction Manager
DCI GROUP
220 SE 6TH ST - SUITE 200
DES MOINES, IA 50309
P. 515-244-5043

Civil Engineer
CIVIL ENGINEERING CONSULTANTS
CONSULTANT UNIT 12
DES MOINES, IA 50322
P. 515-276-7084

Structural Engineer
RAKER RHODES ENGINEERING
4717 GRAND AVE
DES MOINES, IA 50312
P. 515-277-0275

Mechanical Engineer
KCL ENGINEERING
300 4TH ST
WEST DES MOINES, IA 50265
P. 515-724-7938

Electrical Engineer
KCL ENGINEERING
300 4TH ST
WEST DES MOINES, IA 50265
P. 515-724-7938

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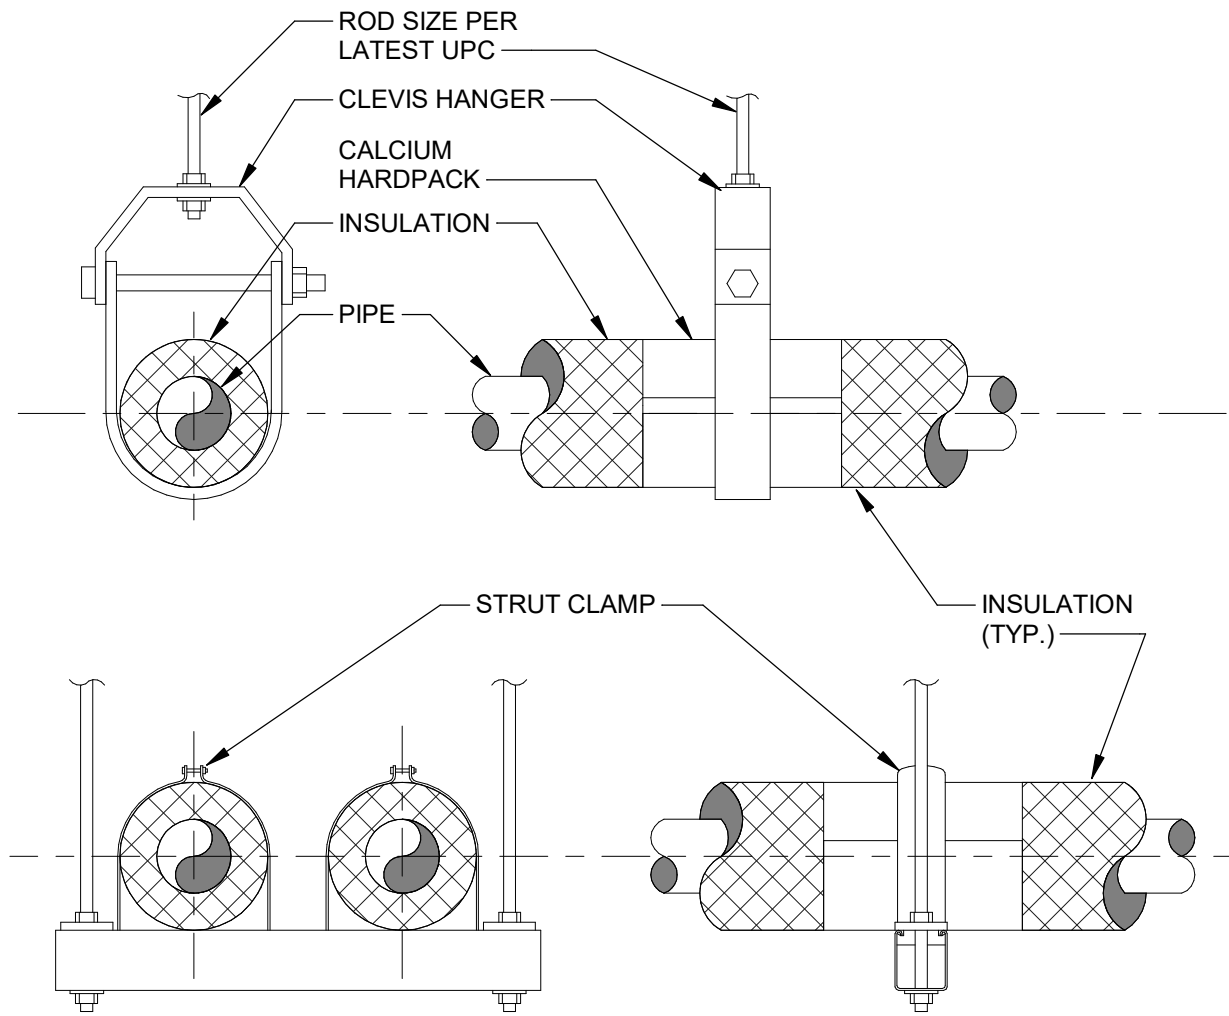
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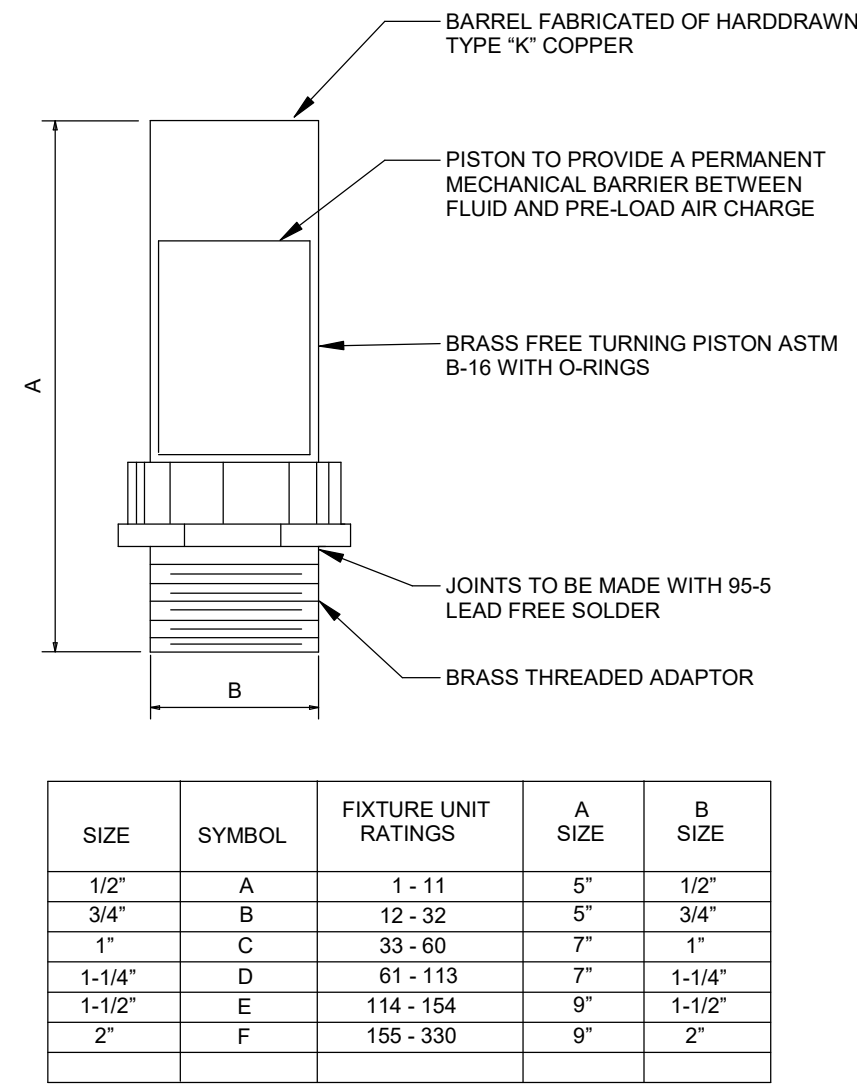
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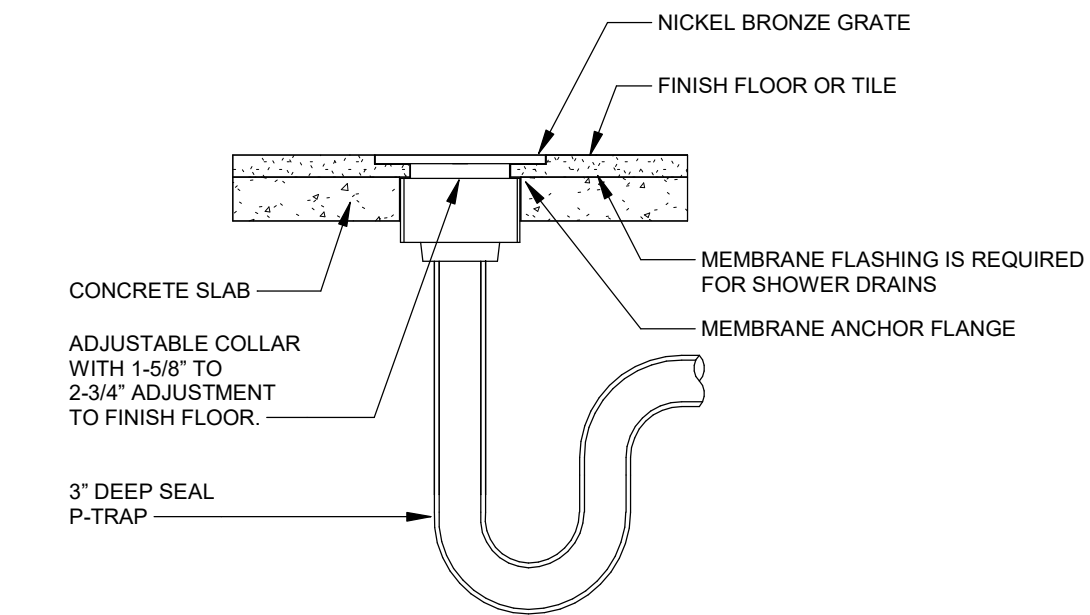
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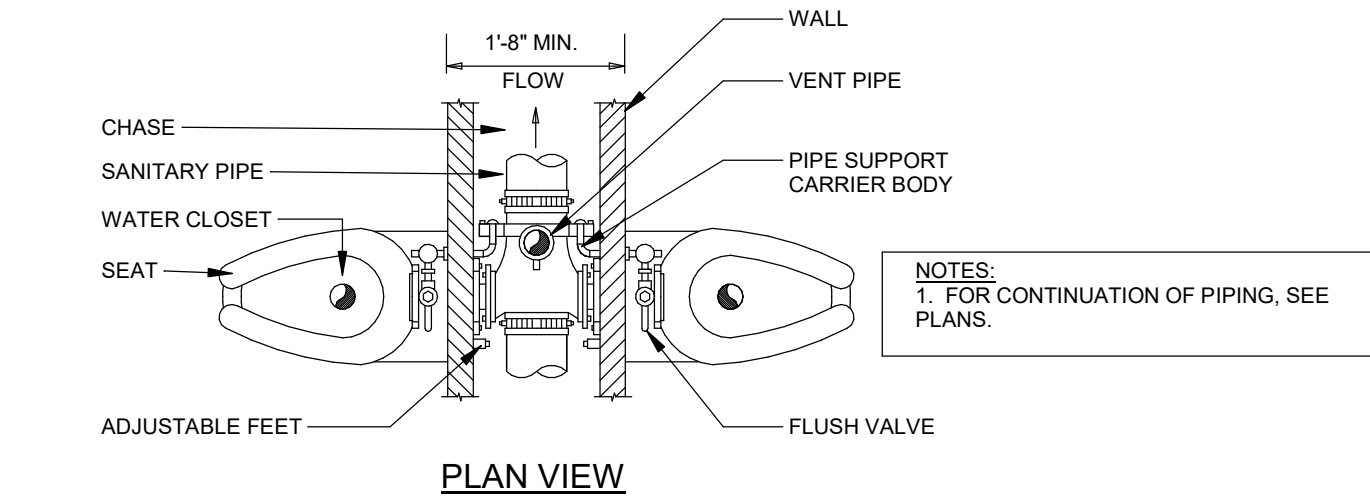
7 PIPE SUPPORT
N.T.S.




8 WATER SHOCK ARRESTOR DETAIL
NTS




3 FLOOR DRAIN DETAIL
NOT TO SCALE




1 BACK-TO-BACK WALL HUNG WATER CLOSET DETAIL
NOT TO SCALE

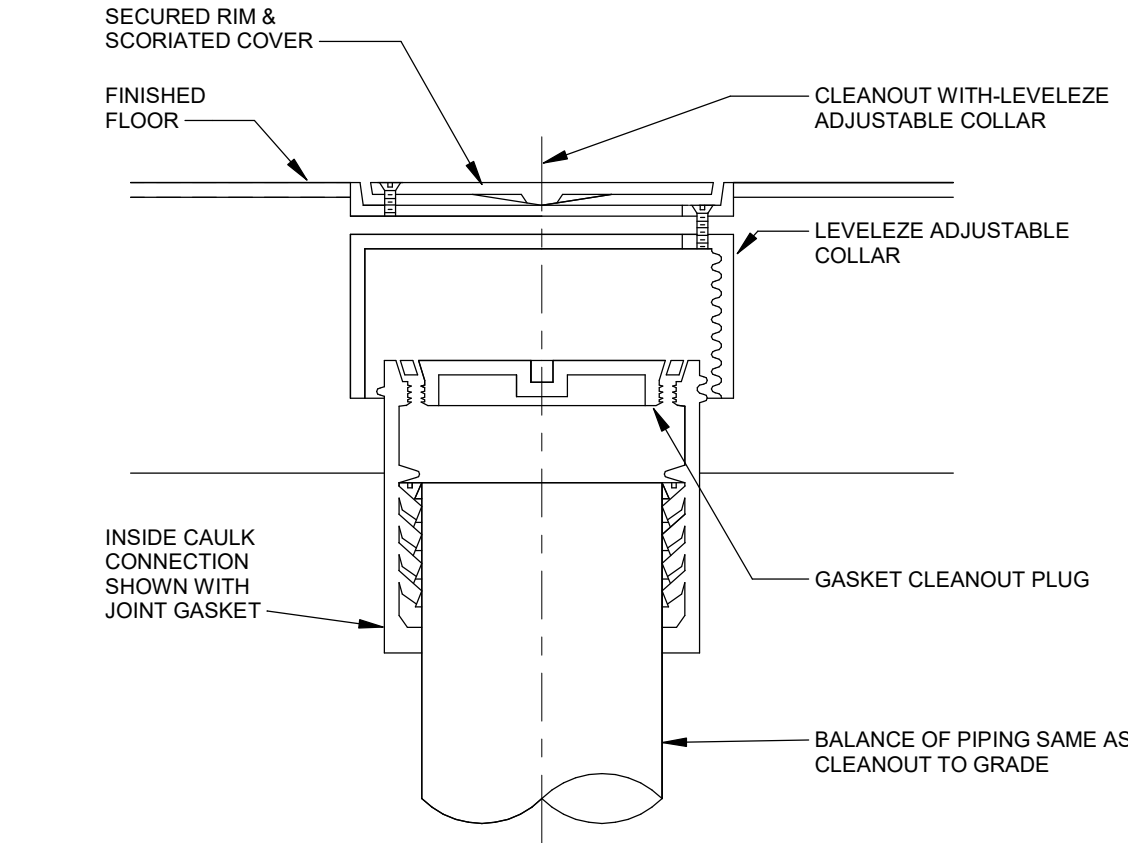

2 FLOOR CLEANOUT DETAIL
NOT TO SCALE

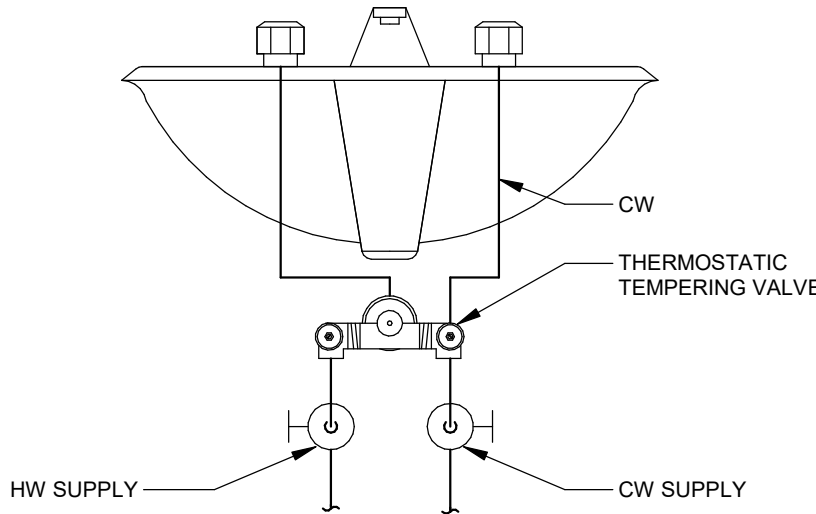

4 POINT-OF-USE MIXING VALVE DETAIL
NOT TO SCALE

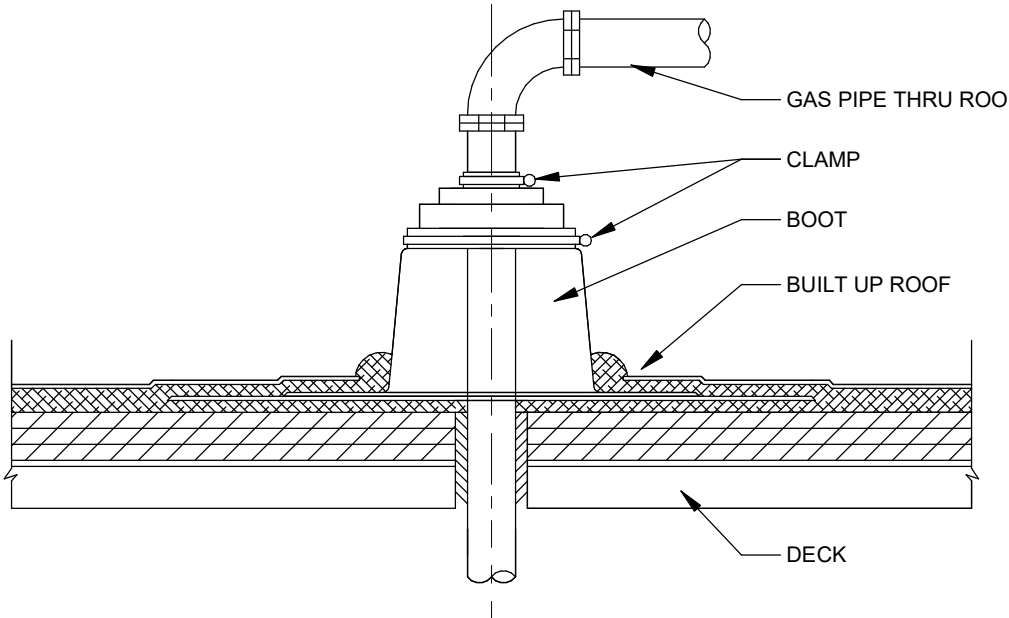

9 GAS PIPE THRU ROOF DETAIL
NOT TO SCALE

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100 Court Ave., Suite 100
Des Moines, IA 50309
P: 515-309-0722
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Owner

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Construction Manager

DCI GROUP
220 SE 6TH ST - SUITE 200
DES MOINES, IA 50309
P. 515-244-5043

Civil Engineer

CIVIL ENGINEERING
CONSULTANTS UNIT 12
DES MOINES, IA 50322
P. 515-276-7084

Structural Engineer

RAKER RHODES ENGINEERING
4717 GRAND AVE
DES MOINES, IA 50312
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Mechanical Engineer

KCL ENGINEERING
300 4TH ST
WEST DES MOINES, IA 50265
P. 515-724-7938

Electrical Engineer

KCL ENGINEERING
300 4TH ST
WEST DES MOINES, IA 50265
P. 515-724-7938

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24816000

Sheet Issue Date

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8/16/24

Sheet Name

PLUMBING DETAILS

Sheet Number

P301

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PLUMBING FIXTURE SCHEDULE				
REFERENCE	MFR	MODEL	DESCRIPTION	TRIM
IMB-1	GUY GRAY	BIM875QTSAB	ICE MAKER OUTLET BOX - 20-GAUGE G90 GALVANIZED ENCLOSURE, 1/2" FIP INLET, 1/4" OD OUTLET QUARTER TURN BRASS BALL VALVE WITH FACEPLATE.	INSTALL BFP-2 DOWNSTREAM OF ICE MAKER OUTLET BOX.
L-1	N/A	N/A	INTEGRAL TO COUNTERTOP BY OTHERS. PROVIDE TRIM AS SHOWN.	DELTA "591-T1250", ADA COMPLIANT, BATTERY POWERED SENSOR TYPE FAUCET, WITH OFFSET GRID STRAINER AND TRAP, TRUEBRO "102W, 105" CW, HW, AND WASTE PIPE GUARDS AND ESCUTCHEONS. MAXIMUM FIXTURE FLOW TO BE 0.5 GPM. PROVIDE POWERS "LFE480" POINT OF USE MIXING VALVE UNDER FIXTURE. MIXING VALVE MUST MEET ASSE 1070 AND UPC 2009 REQUIREMENTS. PROVIDE WITH 1/4 TURN, 3/8" BRASS STOPS.
SK-1	ELKAY	ECTRU	ADA, SINGLE BOWL, UNDERMOUNT, 18-GAUGE STAINLESS STEEL, COMPLETELY UNDERCOATED, 19" SIDE TO SIDE x 18" FRONT TO BACK, 16" x 11-1/2" x 5-1/2" DEEP BOWL, OFF-CENTERED REAR DRAIN OPENING. VERIFY FINAL DIMENSIONS FROM ARCH ELEVATION AND MILWORK DRAWINGS. COORDINATE ALL REQUIRED HOLES FOR TRIM AND INDICATE IN..	SLOAN "EAF-700-P4SM", ADA, HARD WIRED, SINGLE HOLE, DECK MOUNT, RIGID GOOSENECK SENSOR TYPE FAUCET WITH 6" REACH, 1.5 GPM LAMINAR FLOW SPRAY INSERT, AND INTEGRAL SPOUT TEMPERATURE MIXER. PROVIDE POWERS "LFLM489" POINT OF USE MIXING UNDER FIXTURE. MIXING VALVE MUST MEET ASSE 1070 AND UPC 2009 REQUIREMENTS. PROVIDE WITH 1/4 TURN STOPS AND 3/8" RISERS.
SK-2	ELKAY	EFRU	DOUBLE BOWL, UNDERMOUNT, 18-GAUGE STAINLESS STEEL, COMPLETELY UNDERCOATED, 29" SIDE TO SIDE x 22" FRONT TO BACK, EACH BOWL 11 1/2" x 16" x 7 5/8" DEEP. VERIFY FINAL DIMENSIONS FROM ARCH ELEVATION AND MILWORK DRAWINGS. COORDINATE ALL REQUIRED HOLES FOR TRIM AND INDICATE IN SUBMITTAL. REMOVABLE STAINLESS STEEL BASKET...	DELTA "3182", BRASS CONSTRUCTION, CHROME-PLATED FINISH, SINGLE HANDLE GOOSENECK FAUCET, SWIVEL SPOUT, 9 3/8" REACH, 1.8 GPM AERATOR, TWO FUNCTION WAND OPERATION, 20" BRAIDED HOSE, ONE HOLE FAUCET. PROVIDE WITH 1/4 TURN, 3/8" BRASS STOPS.
TP-1	SIOUX CHIEF	695 SERIES	MECHANICAL TRAP PRIMER, BRASS-PLATED CAP AND BODY. UPC/ASSE LISTED. ACTIVATION WITH 10 PSIG PRESSURE DROP WITH FACTORY SET WATER RELEASE. 1/2" FIP INLET AND 1/2" MIP OUTLET.	SIOUX CHIEF 695-Y WYE SPLITTER OR 695-D DISTRIBUTOR WITH BRASS, COPPER, NO-LEAD BODY AND BRASS BRANCH PIPING. CONTRACTOR TO VERIFY REQUIRED MODEL AND NUMBER OF BRANCHES TO PRIME NEARBY TRAPS.
UR- 1 (ADA)	KOHLER	K-4991	WALL-MOUNT, SIPHON JET WITH SHIELDS, WHITE, VITREOUS CHINA, REMOVABLE STAINLESS STEEL STRAINER, 3/4" TOP SPUD, FLOOR MOUNTED CARRIER WITH BEARING PLATE, ADA COMPLIANT MOUNTING HEIGHT.	SLOAN ROYAL "186" OR APPROVED EQUAL, 1.0 GPF MANUAL FLUSH VALVE WITH VANDAL RESISTANT CAP.
WC-1X (WALL/ADA)	EXISTING	EXISTING	REUSE EXISTING WALL HUNG WATER CLOSET, SEAT AND FLUSH VALVE.	PROIVE NEW WATER CLOSET CARRIER. REFER TO SPECIFICATION SECTION 22 40 00.
WC-2X (WALL)	EXISTING	EXISTING	REUSE EXISTING WALL HUNG WATER CLOSET, SEAT AND FLUSH VALVE.	PROIVE NEW WATER CLOSET CARRIER. REFER TO SPECIFICATION SECTION 22 40 00.
WC-1 (WALL/ADA)	KOHLER	K-84325	WALL MOUNTED 1.6 GPF, WHITE VITREOUS CHINA, ELONGATED BOWL, SIPHON JET TOILET, BOLT CAPS, 1 1/2" TOP SPUD. ADA COMPLIANT BOWL HEIGHT.	SLOAN "8111-MC" OR APPROVED EQUAL, BATTERY POWERED, 1.6 GPF EXPOSED SENSOR OPERATED FLUSH VALVE WITH VANDAL RESISTANT CAP AND OVERRIDE BUTTON. CHURCH 295SSCT WHITE OPEN FRONT SELF-SUSTAINING HEAVY SEAT, INJECTION MOLDED PLASTIC, STAINLESS STEEL POSTS, ESCUTCHEON.
WC-2 (WALL)	KOHLER	K-84325	WALL MOUNTED 1.6 GPF, WHITE VITREOUS CHINA, ELONGATED BOWL, SIPHON JET TOILET, BOLT CAPS, 1 1/2" TOP SPUD. STANDARD BOWL HEIGHT.	SLOAN "8111-MC" OR APPROVED EQUAL, BATTERY POWERED, 1.6 GPF EXPOSED SENSOR OPERATED FLUSH VALVE WITH VANDAL RESISTANT CAP AND OVERRIDE BUTTON. CHURCH 295SSCT WHITE OPEN FRONT SELF-SUSTAINING HEAVY SEAT, INJECTION MOLDED PLASTIC, STAINLESS STEEL POSTS, ESCUTCHEON.
WCO-1	ZURN	Z1446	WALL CLEANOUT TEE, GAS AND WATERTIGHT ABS TAPERED THREAD PLUG, AND ROUND, SMOOTH STAINLESS STEEL WALL ACCESS COVER WITH SECURING SCREW.	NA

NOTES:
1. REFER TO PLUMBING FIXTURE ROUGH-IN SCHEDULE FOR MINIMUM CONNECTION SIZES.

PLUMBING FIXTURE ROUGH-IN SCHEDULE

FIXTURE	CW	HW	VENT	WASTE	NOTES
FLOOR DRAIN	-	-	2"	4"	1
LAVATORY	1/2"	1/2"	1 1/4"	1 1/4"	1,2
SINK	1/2"	1/2"	1 1/2"	1 1/2"	1,2
URINAL (FLUSH VALVE)	3/4"	-	1 1/2"	2"	1
WATER CLOSET (FLUSH VALVE)	1"	-	2"	4"	1

NOTES:
1. ALL SIZES SHOWN ARE MINIMUM CONNECTION SIZES, REFER TO DRAWINGS FOR FINAL SIZES.
2. ALL VERTICAL WASTE RISERS TO FIXTURES AND ALL BELOW FLOOR WASTE SIZES SHALL BE A MINIMUM OF 2".

WATER HEATER

REFERENCE	WH-1
MANUFACTURER	EEMAX
MODEL #	EMT2.5
SERVES	SK-1
DIMENSIONS (WxDxH)	11x11x17
GALLONS	2.5
RECOVERY GPH 60°F RISE	19
KW	1.44
DELIVERY WATER TEMP (°F)	110
VOLTAGE/PH	120/1
NOTES	1,2,3,4

NOTES:
1. PROVIDE WITH ASME RATED T&P RELIEF VALVE.
2. UNIT TO MEET REQUIREMENTS OF IECC 2012.
3. PROVIDE WITH PLUG-IN CONNECTION. RECEPTICLE UNDER SINK BY EC.
4. INSTALL PER MANUFACTURERS RECOMMENDATIONS.

PLUMBING PIPING AND INSULATION SCHEDULE

SYSTEM	SIZE RANGE (INCHES)	LOCATION	PIPE MATERIAL (NOTE 1)	JOINT TYPE (NOTE 1)	VALVE TYPES (NOTE 3)	INSULATION TYPE (NOTE 2)	INSULATION THICKNESS (INCHES)	JACKET (NOTE 4)	NOTES
DOMESTIC COLD WATER	3/4 - 1 1/4	ABOVE GROUND	TYPE L COPPER	SOLDER/PRESSURE SEAL	BRONZE BALL W/ SS TRIM	MINERAL FIBER / ELASTOMERIC	1/2	PVC	5
DOMESTIC COLD WATER	3/4 - 1 1/4	IN WALL CAVITY	PEX	METAL INSERT		MINERAL FIBER / ELASTOMERIC	1/2	--	
DOMESTIC COLD WATER	1 1/2 - 2	ABOVE GROUND	TYPE L COPPER	SOLDER/PRESSURE SEAL	BRONZE BALL W/ SS TRIM	MINERAL FIBER / ELASTOMERIC	1	PVC	5
DOMESTIC HOT WATER	3/4 - 1 1/4	ABOVE GROUND	TYPE L COPPER	SOLDER/PRESSURE SEAL	BRONZE BALL W/ SS TRIM	MINERAL FIBER / ELASTOMERIC	1	PVC	5
DOMESTIC HOT WATER	3/4 - 1 1/4	IN WALL CAVITY	PEX	METAL INSERT		MINERAL FIBER / ELASTOMERIC	1	--	
DOMESTIC HOT WATER	1 1/2 - 2	ABOVE GROUND	TYPE L COPPER	SOLDER/PRESSURE SEAL	BRONZE BALL W/ SS TRIM	MINERAL FIBER	1 1/2	--	5
DOMESTIC HOT WATER	2 1/2 - 8	ABOVE GROUND	TYPE L COPPER	GROOVED		MINERAL FIBER	1 1/2	PVC	5
DOMESTIC HOT WATER CIRC	3/4 - 1 1/4	ABOVE GROUND	TYPE L COPPER	SOLDER/PRESSURE SEAL	BRONZE BALL W/ SS TRIM	MINERAL FIBER / ELASTOMERIC	1	PVC	5
DOMESTIC HOT WATER CIRC	3/4 - 1 1/4	IN WALL CAVITY	PEX	METAL INSERT		MINERAL FIBER / ELASTOMERIC	1	--	
SANITARY DRAIN (GRAVITY)	1 1/2 - 8	BELOW GROUND	SCH 40 PVC DWV / CI	SOLVENT / HUB & SPIGOT	N/A	--	--	--	
SANITARY VENT PIPING	1 1/4 - 4	BELOW GROUND	SCH 40 PVC DWV / CI	SOLVENT / HUB & SPIGOT	N/A	--	--	--	
SANITARY DRAIN (GRAVITY)	1 1/2 - 8	ABOVE GROUND	SCH 40 PVC DWV / CI	SOLVENT / NO HUB	N/A	--	--	--	
SANITARY VENT PIPING	1 1/4 - 6	ABOVE GROUND	SCH 40 PVC DWV / CI	SOLVENT / NO HUB	N/A	MINERAL FIBER	1	--	5,6

NOTES:
1. ALL PIPING UTILIZED FOR POTABLE WATER SHALL MEET NSF 14, 61 AND 372. PUSH TO CONNECT / PUSH ON TYPE JOINTS ARE NOT ALLOWED. REFER TO SPECIFICATIONS FOR FURTHER JOINT AND MATERIAL REQUIREMENTS.
2. REFER TO SPECIFICATIONS FOR FURTHER INSULATION REQUIREMENTS. INSULATION R-VALUE SHALL MEET INTERNATIONAL ENERGY CODE 2015 REQUIREMENTS.
3. ALL VALVES UTILIZED IN POTABLE WATER SYSTEMS SHALL MEET NSF 61 AND 372. REFER TO SPECIFICATIONS FOR FURTHER VALVE REQUIREMENTS.
4. EXPOSED PIPING MOUNTED BELOW 10'-0" ABOVE FLOOR SHALL HAVE PVC JACKET.
5. INSULATION APPLIED TO PIPING THAT IS LOCATED IN RETURN AIR PLENUMS SHALL MEET ASTM E 84 25/50 FLAME AND SMOKE SPREAD RATING AND COMPLY WITH NFPA STANDARD 90A.
6. VENT PIPING SHALL BE INSULATED A MINIMUM OF 5'-0" FROM EXTERIOR WALL OR ROOF PENETRATION.

OPNARCHITECTS

100 Court Ave., Suite 100
Des Moines, IA 50309
P: 515-309-0722
www.opnarchitects.com

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Owner

STATE OF IOWA - DEPARTMENT OF ADMINISTRATIVE SERVICES
1305 E WALNUT ST
DES MOINES, IA 50319

Project

9411.00 - 6200 PARK ALI WORKMAN'S COMP RENOVATION
6200 PARK AVE
DES MOINES, IA 50321

Construction Manager

DCI GROUP
220 SE 6TH ST - SUITE 200
DES MOINES, IA 50309
P. 515-244-5043

Civil Engineer

CIVIL ENGINEERING CONSULTANTS UNIT 12
DES MOINES, IA 50322
P. 515-276-7084

Structural Engineer

RAKER RHODES ENGINEERING
4717 GRAND AVE
DES MOINES, IA 50312
P. 515-277-0275

Mechanical Engineer

KCL ENGINEERING
300 4TH ST
WEST DES MOINES, IA 50265
P. 515-724-7938

Electrical Engineer

KCL ENGINEERING
300 4TH ST
WEST DES MOINES, IA 50265
P. 515-724-7938

Key Plan

Revision

Description

Date

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DRAWING SET
Sheet Name
PLUMBING SCHEDULES
Sheet Number

P501

BUILDING EQUIPMENT COORDINATION NOTES - ELECTRICAL

1.

REFER TO EQUIPMENT CONNECTION SCHEDULE FOR COORDINATION DETAILS BETWEEN MECHANICAL AND ELECTRICAL SYSTEMS.
2.

PROVIDE AND INSTALL ELECTRICAL SYSTEMS UNDER THIS CONTRACT MEETING THE REQUIREMENTS OF THE SPECIFIED MECHANICAL, FIRE PROTECTION, AND PLUMBING SYSTEMS. REFERENCE THE ENTIRE PROJECT DOCUMENTS, MANUALS, SCHEDULES, DETAILS, AND NOTES.
3.

PROVIDE ELECTRICAL CONNECTIONS AND ACCESSORIES INCLUDING STARTERS, DISCONNECTS, CONTROL WIRING, ETC. AS REQUIRED FOR THE BUILDING MECHANICAL EQUIPMENT. INFORMATION HEREIN AND ON THE DRAWINGS IS FOR GENERAL DESCRIPTION AND ESTIMATING PURPOSES ONLY. VERIFY VOLTAGE, AMPERAGE, PHASE, INRUSH, ETC. FOR EACH ITEM OF EQUIPMENT BEFORE PROCEEDING WITH INSTALLATION. INSTALL EQUIPMENT PER WIRING DETAILS AND INSTRUCTIONS FURNISHED BY THE SUPPLIERS OF THE EQUIPMENT TO PROVIDE PROPER OPERATION.
4.

REVIEW MECHANICAL, EQUIPMENT SHOP DRAWINGS FOR COMPLIANCE AND COORDINATION WITH ELECTRICAL CONNECTIONS. NOTIFY ENGINEER IF CHANGES TO ELECTRICAL CONNECTIONS, WIRING, AND BREAKER REQUIREMENTS ARE NECESSARY TO ACCOMMODATE EQUIPMENT BEING SUPPLIED.

a.

DO NOT RELEASE ELECTRICAL DISTRIBUTION EQUIPMENT UNTIL ALL MECHANICAL EQUIPMENT REQUIRING ELECTRICAL INFRASTRUCTURE HAS BEEN SUBMITTED AND APPROVED. MAKE COORDINATION ADJUSTMENTS TO BREAKER SIZES AND SIMILAR CHANGES TO ELECTRICAL EQUIPMENT PRIOR TO SUBMITTAL RELEASE. COORDINATE SCHEDULING OF SHOP DRAWINGS WITH ALL TRADES.
5.

PROVIDE DISCONNECTS RATED FOR EQUIPMENT AS REQUIRED AND AS INDICATED WITHIN EQUIPMENT CONNECTION SCHEDULE. COORDINATE DISCONNECT MOUNTING TO ALLOW EQUIPMENT REMOVAL WITHOUT DISCONNECT REMOVAL AND TO MINIMIZE WIRING WORK REQUIRED.
6.

PROVIDE HEAVY DUTY TYPE DISCONNECTS RATED FOR THE INSTALLED ENVIRONMENT. PROVIDE MINIMUM NEMA 3R RATED DISCONNECTS FOR EXTERIOR INSTALLATIONS OR AS NOTED.
7.

VERIFY LOCATIONS OF ALL EQUIPMENT. REFER TO MECHANICAL, PLUMBING, AND ARCHITECTURAL DRAWINGS AND COORDINATE WITH THE ASSOCIATED SUB-CONTRACTOR. ADJUST ELECTRICAL INSTALLATION AS REQUIRED.

CODE NOTES - ELECTRICAL

1.

PROVIDE ELECTRICAL INSTALLATION IN ACCORDANCE WITH ALL STATE CODES.
2.

THE CURRENT ADOPTED EDITION OF THE ELECTRICAL CODE IS THE STANDARD FOR THE ELECTRICAL INSTALLATION. VERIFY WITH LOCAL OFFICIALS WHEN PERMITS ARE OBTAINED. NOTIFY DESIGN TEAM OF ANY DISCREPANCIES BETWEEN THE PROJECT MANUAL OR DRAWINGS AND THE GOVERNING CODE.
3.

INSTALLATION SHALL FOLLOW REQUIREMENTS OF THE ADAAG –AMERICANS WITH DISABILITIES ACT.
4.

REFER TO PROJECT MANUAL AND PROJECT CODE REVIEW SHEET FOR LIST OF APPLICABLE CODES.

DEMOLITION AND RENOVATION NOTES - ELECTRICAL

1.

ELECTRICAL DEMOLITION DRAWINGS SHOWING EXISTING CONDITIONS HAVE BEEN PREPARED BASED ON FIELD OBSERVATION AND ORIGINAL DRAWINGS. FIELD VERIFY EXISTING CONDITIONS BEFORE WORK BEGINS. ADDITIONAL COMPONENTS MAY EXIST WHICH ARE NOT SHOWN. BECOME FAMILIAR WITH EXISTING ELECTRICAL SYSTEM WHICH WILL BE AFFECTED BY THE DEMOLITION WORK.
2.

PROVIDE EQUIPMENT, LABOR, AND MATERIALS TO REMOVE ELECTRICAL FACILITIES AND CLEAR THE AREA TO RECEIVE THE NEW WORK PROVIDED UNDER THIS CONTRACT.
3.

IN OCCUPIED AREAS BEYOND THE DEMOLITION SCOPE, KEEP EXISTING SYSTEMS NOT AFFECTED BY PROJECT SCOPE OPERATIONAL THROUGH THE DURATION OF THE PROJECT. OBTAIN PERMISSION FROM OWNER'S REPRESENTATIVE TO SHUT OFF SERVICES OR SYSTEMS WHICH MAY AFFECT OTHER AREAS BEYOND THE LIMITS OF THE DEMOLITION AREA. INFORM OWNER'S REPRESENTATIVE OF THE REASON FOR AND DURATION OF THE SHUTDOWN AND ENSURE THAT THE SHUTDOWN IS MADE WITH AS LITTLE INCONVENIENCE TO OTHER AREAS AS POSSIBLE.
4.

REMOVE CONDUITS, BOXES, ETC., AS REQUIRED BY WALL, CEILING, AND ADJACENT COMPONENTS DEMOLITION. REMOVE EXISTING WIRE UNLESS OTHERWISE NOTED.
5.

INSTALL NEW CONDUCTORS FOR NEW CIRCUITS IN REMODELED AREAS UNLESS SPECIFICALLY NOTED OTHERWISE. RETAIN EXISTING CONDUITS IN GOOD CONDITION WHERE APPROVED BY ENGINEER OR AS INDICATED.
6.

IDENTIFY DISCONNECTED BRANCH CIRCUIT LOCATION OR ITEM SERVED BEFORE DISCONNECTION. UPDATE PANEL/EQUIPMENT DIRECTORY ACCORDINGLY.
7.

MAINTAIN CIRCUITS SERVING AREAS BEYOND THE DEMOLITION AREA. EXTEND NEW WIRING AND BYPASS DEMOLISHED DEVICES TO MAINTAIN EXISTING CIRCUITS.
8.

KEEP EXISTING SYSTEMS OPERATIONAL DURING ALL PHASES OF CONSTRUCTION. DO NOT CUT EXISTING TELECOMMUNICATION WIRING, CABLES OR CONDUIT. CONTRACTORS WHO CUT IN-SERVICE CABLES ARE RESPONSIBLE FOR ALL DOWNTIME AND COSTS TO REPAIR.
9.

INSTALL BLANK COVER PLATES OVER OPENING AT REMOVED DEVICE LOCATIONS. THIS INCLUDES BUT IS NOT LIMITED TO, CLOCKS, RECEPTACLES, SWITCHES, JUNCTION BOXES, ETC.
10.

PROVIDE CUTTING AND PATCHING OF EXISTING MATERIALS AS REQUIRED FOR THE PROPER COMPLETION OF THE DEMOLITION WORK AND THE INSTALLATION OF THE NEW WORK.
11.

MAINTAIN FULL FUNCTIONAL AND AESTHETIC INTEGRITY OF DEVICES IDENTIFIED TO BE REMOVED AND RELOCATED, AND HANDLE WITH APPROPRIATE CARE TO ALLOW FOR REINSTALLATION. REPLACE DEVICES DAMAGED DURING DEMOLITION WITH NEW AT CONTRACTOR'S EXPENSE.
12.

EQUIPMENT AND SYSTEM THAT ARE REMOVED REMAIN THE PROPERTY OF THE OWNER UNLESS OTHERWISE NOTED. DISPOSE OF ALL MATERIALS NOT SALVAGED BY THE OWNER.
13.

REMOVE AND REINSTALL CEILING TILES REQUIRED FOR THE WORK BEING DONE UNDER THIS CONTRACT. REPLACE CEILING TILES DAMAGED DURING CONSTRUCTION TO MATCH EXISTING.

DEVICE INSTALLATION AND MATERIALS - ELECTRICAL

1.

PROVIDE NORMAL WIRING DEVICES AS GRAY UNLESS OTHERWISE NOTED.
2.

PROVIDE DEVICES COVER PLATES AS STAINLESS STEEL. MATCH WIRING DEVICES COLOR.
3.

PROVIDE GFCI TYPE RECEPTACLES AT ALL LOCATIONS REQUIRED BY THE NEC.
4.

INSTALL WALL MOUNTED RECEPTACLES AT +18" ABOVE FINISHED FLOOR UNLESS OTHERWISE NOTED.
5.

INSTALL WALL MOUNTED LIGHT SWITCHES AT +48" ABOVE FINISHED FLOOR UNLESS OTHERWISE NOTED. EXCEPTION: INSTALL DEVICES ABOVE AN OBSTRUCTED HIGH FORWARD REACH OBSTACLE GREATER THEN 20 INCHES IN DEPTH AT +42".
6.

INSTALL ABOVE COUNTERTOP RECEPTACLES +8" ABOVE COUNTERTOP OR AS OTHERWISE INDICATED.
7.

AT A COMMON COUNTERTOP, INSTALL ALL RECEPTACLES AND SWITCHES AT THE SAME HEIGHT UNLESS OTHERWISE SPECIFICALLY INDICATED.

INSTALLATION NOTES - ELECTRICAL

1.

BECOME FAMILIAR WITH EXISTING CONDITIONS PRIOR TO BID.
2.

INCREASE CONDUCTOR SIZES ON 20A 120V-1 PHASE CIRCUITS EXCEEDING 100 FEET TO CENTER OF LOAD TO ACCOUNT FOR VOLTAGE DROP.
3.

RACEWAYS AND BOXES ARE SHOWN DIAGRAMMATICALLY ONLY AND INDICATE GENERAL AND APPROXIMATE LOCATIONS. LAYOUTS DO NOT ALWAYS SHOW THE TOTAL NUMBER OF RACEWAYS OR BOXES FOR THE CIRCUITS REQUIRED, NOR ARE THE LOCATIONS OF INDICATED RUNS INTENDED TO SHOW THE ACTUAL ROUTING OF THE RACEWAYS.
4.

LIGHT FIXTURES, SWITCHES, DEVICES, ETC. ARE SHOWN IN PREFERRED LOCATION. MODIFY CONDUIT, HANGERS, CIRCUITING, ETC. TO PROVIDE A COMPLETE AND OPERATIONAL SYSTEM.
5.

PROVIDE A DEDICATED GREEN INSULATED GROUND CONDUCTOR TO ALL DEVICES. DO NOT USE CONDUIT SYSTEM AS THE ONLY EQUIPMENT GROUNDING METHOD.
6.

DO NOT INSTALL BOXES BACK-TO-BACK ON OPPOSITE SIDES OF THE SAME WALL. MAINTAIN MINIMUM OF 8" DISTANCE BETWEEN BOXES WHEREVER APPLICABLE.
7.

BALANCE PANEL LOADS DURING INSTALLATION. CIRCUIT NUMBERING SHOWN ON PLANS MAY BE ADJUSTED TO ACCOMMODATE.
8.

PROVIDE TYPED PANEL DIRECTORY AT PROJECT COMPLETION FOR NEW PANELS AND EXISTING PANELS WITH CIRCUITS MODIFIED AS A RESULT OF THIS PROJECT. USE OWNER'S CURRENT ROOM NUMBERS AND EQUIPMENT NAMES.
9.

CONTRACTOR IS RESPONSIBLE FOR OPENINGS IN WALLS, FLOORS, CEILINGS, AND ROOFS THAT ARE REQUIRED TO COMPLETE THEIR SCOPE OF WORK. SEAL PENETRATIONS IN ACCORDANCE WITH THE RATING OF THE AFFECTED ASSEMBLY. REFER TO ARCHITECTURAL CODE PLAN FOR RATED WALLS, FLOORS, AND CEILINGS.

INSTALLATION NOTES - LIGHTING

1.

UNLESS NOTED OTHERWISE, CONNECT ALL EMERGENCY BATTERY FIXTURES WITH AN UN-SWITCHED LEG OF THE LIGHTING CIRCUIT THAT SERVES THE FIXTURES SPACE. MAINTAIN NORMAL SWITCHING SCHEME OF EMERGENCY FIXTURES UNDER NORMAL OPERATION. INSTALL PER EMERGENCY FIXTURE OR TRANSFER DEVICE INSTRUCTIONS.
2.

VERIFY CEILING TYPE (IE: GRID, GYP) WITH ARCHITECTURAL REFLECTED CEILING PLANS PRIOR TO RELEASE OF LIGHTING FIXTURE EQUIPMENT PACKAGE. ADJUST FIXTURE TYPE, CONSTRUCTION, FLANGE, OR OTHER COORDINATION DETAILS AS REQUIRED FOR CEILING TYPE.
3.

LIGHTING CONTROLS SENSORS ARE SHOWN ON PLANS AT SUGGESTED LOCATIONS ONLY. VERIFY LOCATIONS WITH MANUFACTURER GUIDELINES AND INSTALLATION RECOMMENDATIONS. ADJUST LOCATIONS AS REQUIRED TO MEET MANUFACTURER GUIDELINES.
4.

PROVIDE LIGHTING CONTROLS AS A COMPLETE SYSTEM AND INCLUDE MATERIAL AND INSTALLATION FOR ALL POWER PACKS, ACCESSORIES, CONTROLLERS, AND WIRING REQUIRED FOR OPERATION.

ELECTRICAL ABBREVIATIONS

A	DEVICE MOUNTED +8" ABOVE COUNTER TOP (VERIFY LOCATION) ABOVE FINISHED FLOOR	NIC	NOT IN CONTRACT
AFS	AUTOMATIC TRANSFER SWITCH	NM	NONMETALLIC
ATS	CEILING CIRCUIT BREAKER	NTS	NOT TO SCALE
C	CIRCUIT BREAKER	OC	ON CENTER
CB	CIRCUIT BREAKER	OF	OWNER FURNISHED
CT	CURRENT TRANSFORMER	OFOI	OWNER FURNISHED, CONTRACTOR INSTALLED
E	EXISTING ITEM TO REMAIN	OWNER INSTALLED	
EC	ELECTRICAL CONTRACTOR	R	RELOCATED
EM	EMERGENCY LIGHT FIXTURE	RR	EXISTING ITEM TO BE REMOVED AND RELOCATED
ER	ROUGH-IN FOR FUTURE DEVICE	RN	EXISTING ITEM TO BE REMOVED AND REPLACED WITH NEW
FAAP	FIRE ALARM ANNUNCIATOR PANEL	SCCR	SHORT CIRCUIT CURRENT RATING
FACP	FIRE ALARM CONTROL PANEL	T	TAMPER PROOF DEVICE
FSD	FIRE SMOKE DAMPER	TCC	TEMPERATURE CONTROL CONTRACTOR
G	GROUND FAULT CIRCUIT INTERRUPTER	TV	TELEVISION
KVA	KILO-VOLT-AMPERES	TYP	TYPICAL
KW	KILOWATTS	UPS	UNINTERRUPTIBLE POWER SUPPLY
MC	MECHANICAL CONTRACTOR	V	VOLTS
MCB	MAIN CIRCUIT BREAKER	VA	VOLT-AMPERES
MDP	MAIN DISTRIBUTION PANEL	WG	WIREGUARD COVER
NLO	NEW LOCUS ONLY	WP	WEATHERPROOF DEVICE
N	NEW DEVICE IN EXISTING LOCATION	WR	WEATHER RESISTANT DEVICE
		+24"	INDICATES MOUNTING HEIGHT CENTER LINE OF DEVICE TO FINISHED FLOOR

GENERAL NOTES - ELECTRICAL

1.

COORDINATE LOCATION/INSTALLATION OF MECHANICAL AND ELECTRICAL WORK WITH ALL OTHER TRADES. BEGIN INSTALLATION AND ROUGH-IN ONLY AFTER PROPER AND TIMELY COORDINATION WITH ALL TRADES ASSOCIATED WITH THE INSTALLATION IS COMPLETE. COORDINATE WITH BUILDING STRUCTURE, ARCHITECTURE, MECHANICAL, SHEET METAL, ALL PIPING SYSTEMS, LIGHT FIXTURES, CONDUITS, CABLE TRAYS, EQUIPMENT ACCESS/CLEARANCE, ETC. REFER TO ALL GENERAL, MECHANICAL, AND ELECTRICAL DRAWINGS AND SPECIFICATIONS FOR THIS PROJECT. CONTRACTOR IS RESPONSIBLE FOR REWORK OF INSTALLED EQUIPMENT RESULTING FROM INSUFFICIENT COORDINATION.
2.

ELECTRICAL DRAWINGS ARE ONLY A PORTION OF THE COMPLETE SET OF PLANS AND CONTRACT DOCUMENTS. THE ELECTRICAL SCOPE OF WORK IS DEFINED BY THE COMPLETE SET OF CONTRACT DOCUMENTS. THIS INCLUDES BUT IS NOT LIMITED TO REFERENCING, ARCHITECTURAL PLANS FOR DIMENSIONS AND DETAILS, EQUIPMENT PLANS FOR ROUGH-IN REQUIREMENTS, MECHANICAL PLANS FOR EQUIPMENT SIZES AND LOCATIONS.

TECHNOLOGY RESPONSIBILITY MATRIX

PROVISION RESPONSIBILITIES DEFINED					
	OFOI	OFCI	OCFI	OCFO	OCFOI
COMMUNICATIONS - TELECOM SYSTEMS:					
ROUGH-IN, PATHWAYS AND SLEEVES					●
RACKS, FRAMES AND ENCLOSURES		●			
CABLE MANAGEMENT		●			
UNINTERRUPTIBLE POWER SUPPLIES (RACK MOUNT)		●			
PLYWOOD BACKBOARDS		●			
COPPER BACKBONE CABLING				●	
OPTICAL FIBER BACKBONE CABLING				●	
COAXIAL BACKBONE CABLING	N/A	N/A	N/A	N/A	
COPPER HORIZONTAL CABLING				●	
OPTICAL FIBER HORIZONTAL CABLING				●	
COAXIAL HORIZONTAL CABLING	N/A	N/A	N/A	N/A	
DATA COMMUNICATIONS SWITCHES AND HUBS		●			
DATA COMMUNICATIONS WIRELESS ACCESS POINTS		●			
VOICE COMMUNICATIONS SWITCHING AND ROUTING EQUIPMENT		●			
COMMUNICATIONS - AUDIO-VISUAL SYSTEMS:					
ROUGH-IN, PATHWAYS AND SLEEVES					●
PROJECTOR(S)		●			
FLAT PANEL DISPLAY(S)		●			
MULTI-TOUCH DISPLAY(S)		●			
DISPLAY TECHNOLOGY MOUNTING HARDWARE		●			
MEDIA PLAYER(S)		●			
HEAD-END EQUIPMENT		●			
COMMUNICATIONS - DISTRIBUTED SYSTEMS:					
ROUGH-IN, PATHWAYS AND SLEEVES					●
MASTER ANTENNA / COMMUNITY ANTENNA TELEVISION DISTRIBUTION	N/A	N/A	N/A	N/A	
PUBLIC ADDRESS SYSTEM	N/A	N/A	N/A	N/A	
SOUND MASKING / SPEECH PRIVACY SYSTEM		●			
INTERCOMMUNICATIONS SYSTEM		●			
WIRED / WIRELESS CLOCK SYSTEM		●			
NURSE CALL / CODE BLUE SYSTEM	N/A	N/A	N/A	N/A	
DISTRIBUTED ANTENNA SYSTEM	N/A	N/A	N/A	N/A	
SECURITY - ACCESS CONTROL:					
ROUGH-IN, PATHWAYS AND SLEEVES					●
SECURITY MANAGEMENT SYSTEM - HEAD END COMPONENTS		●			
SECURITY MANAGEMENT SYSTEM - FIELD DEVICES		●			
SECURITY MANAGEMENT SYSTEM - ELECTRIFIED DOOR HARDWARE				●	
SECURITY MANAGEMENT SYSTEM - ALL CABLING		●			
SECURITY - VIDEO INTERCOM:					
ROUGH-IN, PATHWAYS AND SLEEVES					●
DOOR STATION(S)		●			
HEAD END EQUIPMENT AND COMPONENTS		●			
SECURITY - VIDEO SURVEILLANCE:					
ROUGH-IN, PATHWAYS AND SLEEVES					●
CAMERA(S)		●			
HEAD END EQUIPMENT AND COMPONENTS		●			
SECURITY - INTRUSION DETECTION:					
ROUGH-IN, PATHWAYS AND SLEEVES	N/A	N/A	N/A	N/A	
FIELD DEVICES (MOTION DETECTORS, GLASS BREAKS, DOOR SWITCHES)	N/A	N/A	N/A	N/A	
HEAD END EQUIPMENT AND COMPONENTS	N/A	N/A	N/A	N/A	
SAFETY - FIRE DETECTION AND ALARM:					
ROUGH-IN, PATHWAYS AND SLEEVES					●
INITIATING FIELD DEVICES (SMOKE, MANUAL PULL, MONITOR MODULES)					●
NOTIFICATION APPLIANCES (HORNS, STROBES, SPEAKERS)					●
MISCELLANEOUS DEVICES (RELAYS, TEST STATION, ANNUNCIATOR)					●

●	OFOI	OWNER FURNISHED & OWNER INSTALLED
●	OFCI	OWNER FURNISHED & CONTRACTOR INSTALLED
●	OCFI	CONTRACTOR FURNISHED & CONTRACTOR INSTALLED
●	OCFO	CONTRACTOR FURNISHED & OWNER INSTALLED

GENERAL NOTE:
A. MATRIX IS NOT INTENDED TO BE EXHAUSTIVE TO COVER ALL MATERIALS NECESSARY FOR SCOPE AND SHOULD ONLY BE USED TO QUICKLY IDENTIFY SYSTEMS AND RELATED INFRASTRUCTURE INSIDE AND OUTSIDE THE BID OF THIS PROJECT. ANY ITEMS FURNISHED OR INSTALLED BY THE BIDDING CONTRACTOR SHALL COVER ALL REQUIRED APPURTENANCES NECESSARY FOR A COMPLETE SYSTEM. THIS SHALL INCLUDE BUT NOT BE LIMITED TO, EQUIPMENT, ACCESSORIES, TERMINATIONS, TERMINATION COMPONENTS, ALL FINAL CORDAGE CONNECTIVITY, SOFTWARE, PROGRAMMING, AND THE LABOR TO INSTALL.

LIGHTING SYMBOLS

	RECESSED LIGHT FIXTURE, LETTER INDICATES SWITCH LEG (TYPICAL). SHADING INDICATES EMERGENCY LIGHT (TYPICAL.)
	ROUND LIGHT FIXTURE - SURFACE MOUNTED
	PENDANT MOUNTED LIGHT FIXTURE
	ROUND APERTURE RECESSED DOWNLIGHT FIXTURE, ARROW INDICATES WALLWASH
	SURFACE MOUNTED STRIP FIXTURE
	LINEAR PENDANT MOUNTED FIXTURE
	INDUSTRIAL STRIP LIGHT FIXTURE
	EMERGENCY LIGHT FIXTURE, WALL MOUNT, +96" OR AS NOTED
	EXIT SIGN, WALL MOUNT +96", SHADED AREAS INDICATE NUMBER OF FACES, ARROWS INDICATE SIGN ARROWS
	EXIT SIGN, CEILING MOUNT, SHADED AREAS INDICATE NUMBER OF FACES, ARROWS INDICATE SIGN ARROWS
	COMBINATION EXIT SIGN & EMERGENCY LIGHT, WALL MOUNT +96", SHADED AREAS INDICATE NUMBER OF FACES, ARROWS INDICATE SIGN ARROWS
	COMBINATION EXIT SIGN & EMERGENCY LIGHT, CEILING MOUNT, SHADED AREAS INDICATE NUMBER OF FACES, ARROWS INDICATE SIGN ARROWS
	EXTERIOR LIGHT FIXTURE, WALL MOUNT +10", OR AS NOTED
	INTERIOR LIGHT FIXTURE, WALL MOUNT
	EXTERIOR POLE MOUNTED LIGHT FIXTURE, REFER TO LIGHT FIXTURE SCHEDULE
	BOLLARD LIGHT FIXTURE
	EXTERIOR FLOOD LIGHT FIXTURE, REFER TO LIGHT FIXTURE SCHEDULE
	EMERGENCY REMOTE HEAD LIGHT FIXTURE, REFER TO LIGHT FIXTURE SCHEDULE
	SINGLE POLE SWITCH, WALL MOUNT +48", OR AS NOTED, LETTER INDICATES SWITCH LEG
	THREE WAY SWITCH, WALL MOUNT +48", OR AS NOTED, LETTER INDICATES SWITCH LEG
	LIGHTING CONTROLS LOW VOLTAGE SWITCH, WALL MOUNT +48", OR AS NOTED, LETTER INDICATES SWITCH LEG, REFER TO LIGHTING CONTROLS SCHEDULE
	OCCUPANCY SENSOR, WALL MOUNT +48" OR AS NOTED, NUMBER INDICATES TYPE, LETTER INDICATES SWITCH LEG, REFER TO LIGHTING CONTROLS SCHEDULE
	OCCUPANCY SENSOR, CEILING MOUNT, NUMBER INDICATES TYPE, LETTER INDICATES SWITCH LEG, REFER TO LIGHTING CONTROLS SCHEDULE
	DAYLIGHTING SENSOR, CEILING MOUNT, NUMBER INDICATES TYPE, LETTER INDICATES SWITCH LEG, REFER TO LIGHTING CONTROLS SCHEDULE
	LIGHTING CONNECTION, REFER TO LIGHTING FIXTURE SCHEDULE FOR FIXTURE DESCRIPTION

TELECOMMUNICATION SYMBOLS

	DATA CABLING, RUN BACK TO IDF. INSTALL LOOPS PER DRAWINGS. INSTALL AT +18" AFF, UNLESS OTHERWISE NOTED.
	WIRELESS ACCESS POINT - TWO (2) CATEGORY 6A CABLES
	FLOOR MOUNTED OUTLET IN A MULTI-GANG FLOORBOX WITH SINGLE GANG OPENING, PROVIDED BY OTHERS
	CEILING MOUNTED OUTLET (FOR CEILING MOUNTED SECURITY CAMERA)
	DATA CABLING, RUN BACK TO AV RACK. INSTALL LOOPS PER DRAWINGS. COORDINATE LOCATIONS WITH AV CONTRACTOR AND OWNER.
	EMERGENCY ANNOUNCEMENT SPEAKER. MATCH EXISTING SYSTEM TYPE AND INSTALL.

ACCESS CONTROL SYMBOLS

	PROXIMITY CARD READER, +44" OR AS NOTED, 1" CONDUIT WITH PULL STRING TO ABOVE ACCESSIBLE CEILING. COORDINATE LOCATION AND INSTALL WITH OWNER.
	DOOR POSITION SWITCH - FLUSH MOUNTED, DOUBLE POLE DOUBLE THROW (DPDT)
	ELECTRIC STRIKE - FLUSH MOUNTED
	ELECTRIFIED EXIT DEVICE (PANIC HARDWARE)
	AUTOMATIC DOOR OPERATOR - WALL MOUNTED +46", OR AS NOTED
DEVICES TO BE RECESSED IN WALL AT ALL LOCATIONS WHERE POSSIBLE	

GENERAL SYMBOLS

	CONDUIT SLEEVE
	CONDUIT UP, REFER TO TAG ON DRAWING FOR SIZE
	CONDUIT DOWN, REFER TO TAG ON DRAWING FOR SIZE
	JUNCTION BOX, CEILING OR FLOOR MOUNTED.
	JUNCTION BOX, WALL MOUNTED, ELEVATION AS NOTED.
	KEYNOTE
	EQUIPMENT IDENTIFICATION TAG. REFER TO EQUIPMENT CONNECTION SCHEDULE
	DETAIL DRAWING REFERENCE TAG, SIM-SIMILAR, TYP-TYPICAL, OPP-OPPOSITE SHEET REFERENCE
	SECTION CUT REFERENCE TAG, SIM-SIMILAR, TYP-TYPICAL, OPP-OPPOSITE SHEET REFERENCE
	INTERIOR ELEVATION DRAWING REFERENCE TAG

POWER SYMBOLS

	DUPLEX RECEPTACLE, CEILING MOUNT
	DUPLEX RECEPTACLE, TAMPER-RESISTANT, WALL MOUNT +18", OR AS NOTED
	DUPLEX GFCI RECEPTACLE, TAMPER-RESISTANT, WALL MOUNT +18", OR AS NOTED "G" INDICATES PROTECTION INCLUDED IN DEVICE. SHADING INDICATES DEVICE PROTECTED BY EITHER UPSTREAM GFCI DEVICE OR CIRCUIT BREAKER
	DUPLEX RECEPTACLE, MOUNTED WITHIN WATER COOLER HOUSING, VERIFY HEIGHT. CONNECT TO GFCI, CIRCUIT BREAKER OR REMOTE WALL DEVICE. SHADING INDICATES GFCI PROTECTED DEVICE
	DUPLEX GFCI WEATHER RESISTANT RECEPTACLE WITH WEATHER-PROOF IN-USE COVER, TAMPER-RESISTANT, WALL MOUNT +24", OR AS NOTED
	QUADRAPLEX RECEPTACLE, TAMPER-RESISTANT, WALL MOUNT +18", OR AS NOTED
	QUADRAPLEX GFCI RECEPTACLE, TAMPER-RESISTANT, WALL MOUNT +18", OR AS NOTED "G" INDICATES PROTECTION INCLUDED IN DEVICE. SHADING INDICATES DEVICE PROTECTED BY EITHER UPSTREAM GFCI DEVICE OR CIRCUIT BREAKER
	DUPLEX RECEPTACLE IN FLOORBOX, TAMPER-RESISTANT. REFER TO SCHEDULE.
	QUADRUPLEX RECEPTACLE IN FLOORBOX, TAMPER-RESISTANT. REFER TO SCHEDULE.
	FLOOR BOX, COMBINATION POWER AND DATA ENCLOSURE. QUANTITY OF CABLES AS NOTED. DEVICES AS NOTED. REFER TO SCHEDULE.
	SPECIAL RECEPTACLE, WALL MOUNT +18", OR AS NOTED. FURNITURE WHIP CONNECTION FOR OFFICE FURNITURE. VERIFY EXACT CONNECTION WITH OWNER.
	EQUIPMENT CONNECTION, REFER TO ELECTRICAL EQUIPMENT CONNECTION SCHEDULE FOR CONNECTION TYPE. REFER TO PANEL SCHEDULES FOR GFCI PROTECTION WHERE REQUIRED
	EQUIPMENT CONNECTION, WALL MOUNT +18", OR AS NOTED, REFER TO ELECTRICAL EQUIPMENT CONNECTION SCHEDULE FOR CONNECTION TYPE. REFER TO PANEL SCHEDULES FOR GFCI PROTECTION WHERE REQUIRED
	JUNCTION BOX, WITH PULL STRING, WALL MOUNT, REFER TO PLAN OR DETAIL FOR MOUNTING HEIGHT
	HAND DRYER, WALL MOUNT, REFER TO ARCHITECTURAL ELEVATIONS FOR MOUNTING HEIGHT.
	GROUND BAR
	POWER POLE RACEWAY, WHIP INSTALLATION FOR OFFICE FURNITURE. VERIFY EXACT CONNECTION WITH OWNER.
	SAFETY DISCONNECT SWITCH
	PANELBOARD - SURFACE MOUNTED
	PANELBOARD - RECESSED IN WALL
	DISTRIBUTION PANELBOARD/SWITCHBOARD - SURFACE MOUNTED AS NOTED.
	CORD REEL, CEILING MOUNTED - REFER TO DETAIL

FIRE DETECTION AND ALARM SYMBOLS

	MANUAL FIRE ALARM PULL STATION
	FIRE ALARM ANNUNCIATOR PANEL
	FIRE ALARM CONTROL PANEL + EMERGENCY COMMUNICATIONS PANEL
	HORN
	COMBINATION HORN WITH STROBE
	COMBINATION SPEAKER WITH STROBE
	STROBE




ELECTRICAL DEMO POWER & SYSTEMS
PLAN
1/8" = 1'-0"

ELECTRICAL DEMOLITION NOTES

- A. DEMOLITION DRAWINGS PRESENT LAYOUT OF EXISTING CONDITIONS AND MAJOR MECHANICAL/ELECTRICAL ITEMS. THEY ARE NOT TO BE CONSTRUED AS COMPLETE IN REPRESENTATION OF ACCESSORIES AND INCIDENTALS TO BE REMOVED, REPLACED, OR REWORKED. NOR SHOULD ACCESSIBILITY BE INFERRED. THE CONTRACTOR IS RESPONSIBLE TO FAMILIARIZE THEMSELVES WITH THE BUILDING AND EXISTING CONDITIONS, PRIOR TO THE SUBMITTING OF A BID FOR THIS PROJECT.
- B. REMOVE ELECTRICAL FACILITIES AND CLEAR THE AREA TO RECEIVE THE NEW WORK TO BE PROVIDED UNDER THIS CONTRACT.
- C. THIS ELECTRICAL DEMOLITION DRAWING SHOWING EXISTING CONDITIONS HAS BEEN PREPARED BASED ON FIELD OBSERVATION AND ORIGINAL DRAWINGS. ADDITIONAL COMPONENTS MAY EXIST WHICH DO NOT SHOW, AND SUCH ITEMS SHALL BE DEALT WITH IN A MANNER SIMILAR TO THOSE ITEMS WHICH DO SHOW. CONTRACTOR SHALL VISIT THE SITE AND BECOME FAMILIAR WITH EXISTING CONDITIONS.
- D. CONDUITS, BOXES, ETC., SHALL BE REMOVED AS REQUIRED BY WALL AND CEILING DEMOLITION AND REMOVALS. WIRING SHALL BE REMOVED. ALL WIRING FOR THE REMODELED AREAS SHALL BE NEW UNLESS SPECIFICALLY NOTED OTHERWISE. ALL BRANCH CIRCUITS TO BE DISCONNECTED SHALL BE IDENTIFIED AS TO LOCATION OR ITEM SERVED BEFORE DISCONNECTING. CIRCUITS SERVING AREAS BEYOND THE IMMEDIATE DEMOLITION AREA SHALL BE MAINTAINED.
- E. CONTRACTOR SHALL THOROUGHLY FAMILIARIZE HIMSELF WITH EXISTING ELECTRICAL SYSTEM WHICH WILL BE AFFECTED BY THE DEMOLITION WORK. CONTRACTOR SHALL OBTAIN PERMISSION FROM OWNER'S REPRESENTATIVE TO SHUT OFF SERVICES OR SYSTEMS WHICH MAY AFFECT OTHER AREAS BEYOND THE LIMITS OF THE IMMEDIATE DEMOLITION AREA. SUCH PERMISSION WILL BE GRANTED ONLY AFTER OWNER'S REPRESENTATIVE IS INFORMED OF THE REASON FOR AND DURATION OF THE SHUTDOWN AND IS SATISFIED THAT THE SHUTDOWN CAN BE MADE WITH AS LITTLE INCONVENIENCE TO OTHER AREAS AS POSSIBLE.
- F. PANELBOARDS, DISCONNECTS, FIXTURES, WIRING DEVICES, SIGNAL DEVICES, ETC., SHOWN ON PLANS SHALL BE REMOVED UNLESS NOTED OTHERWISE. REMOVAL SHALL BE DONE IN A TIMELY MANNER IN ACCORDANCE WITH THE GENERAL DEMOLITION WORK. COORDINATE WITH THE OWNER AND OTHER CONTRACTORS.
- G. ABBREVIATIONS:
E - EXISTING ITEM TO REMAIN
ER - NEW LOCATION OF EXISTING ITEM
N - NEW ITEM IN EXISTING LOCATION
R - EXISTING ITEM TO BE REMOVED, PATCH AND/OR COVER
RN - REPLACE EXISTING WITH NEW
RR - EXISTING ITEM TO BE REMOVED AND RELOCATED

KEYNOTES

- 1 REUSE FIXTURES IN THIS AREA FOR OPEN STORAGE B148.
2 REUSE FIXTURES IN THIS AREA FOR OPEN STORAGE B164 & B162.

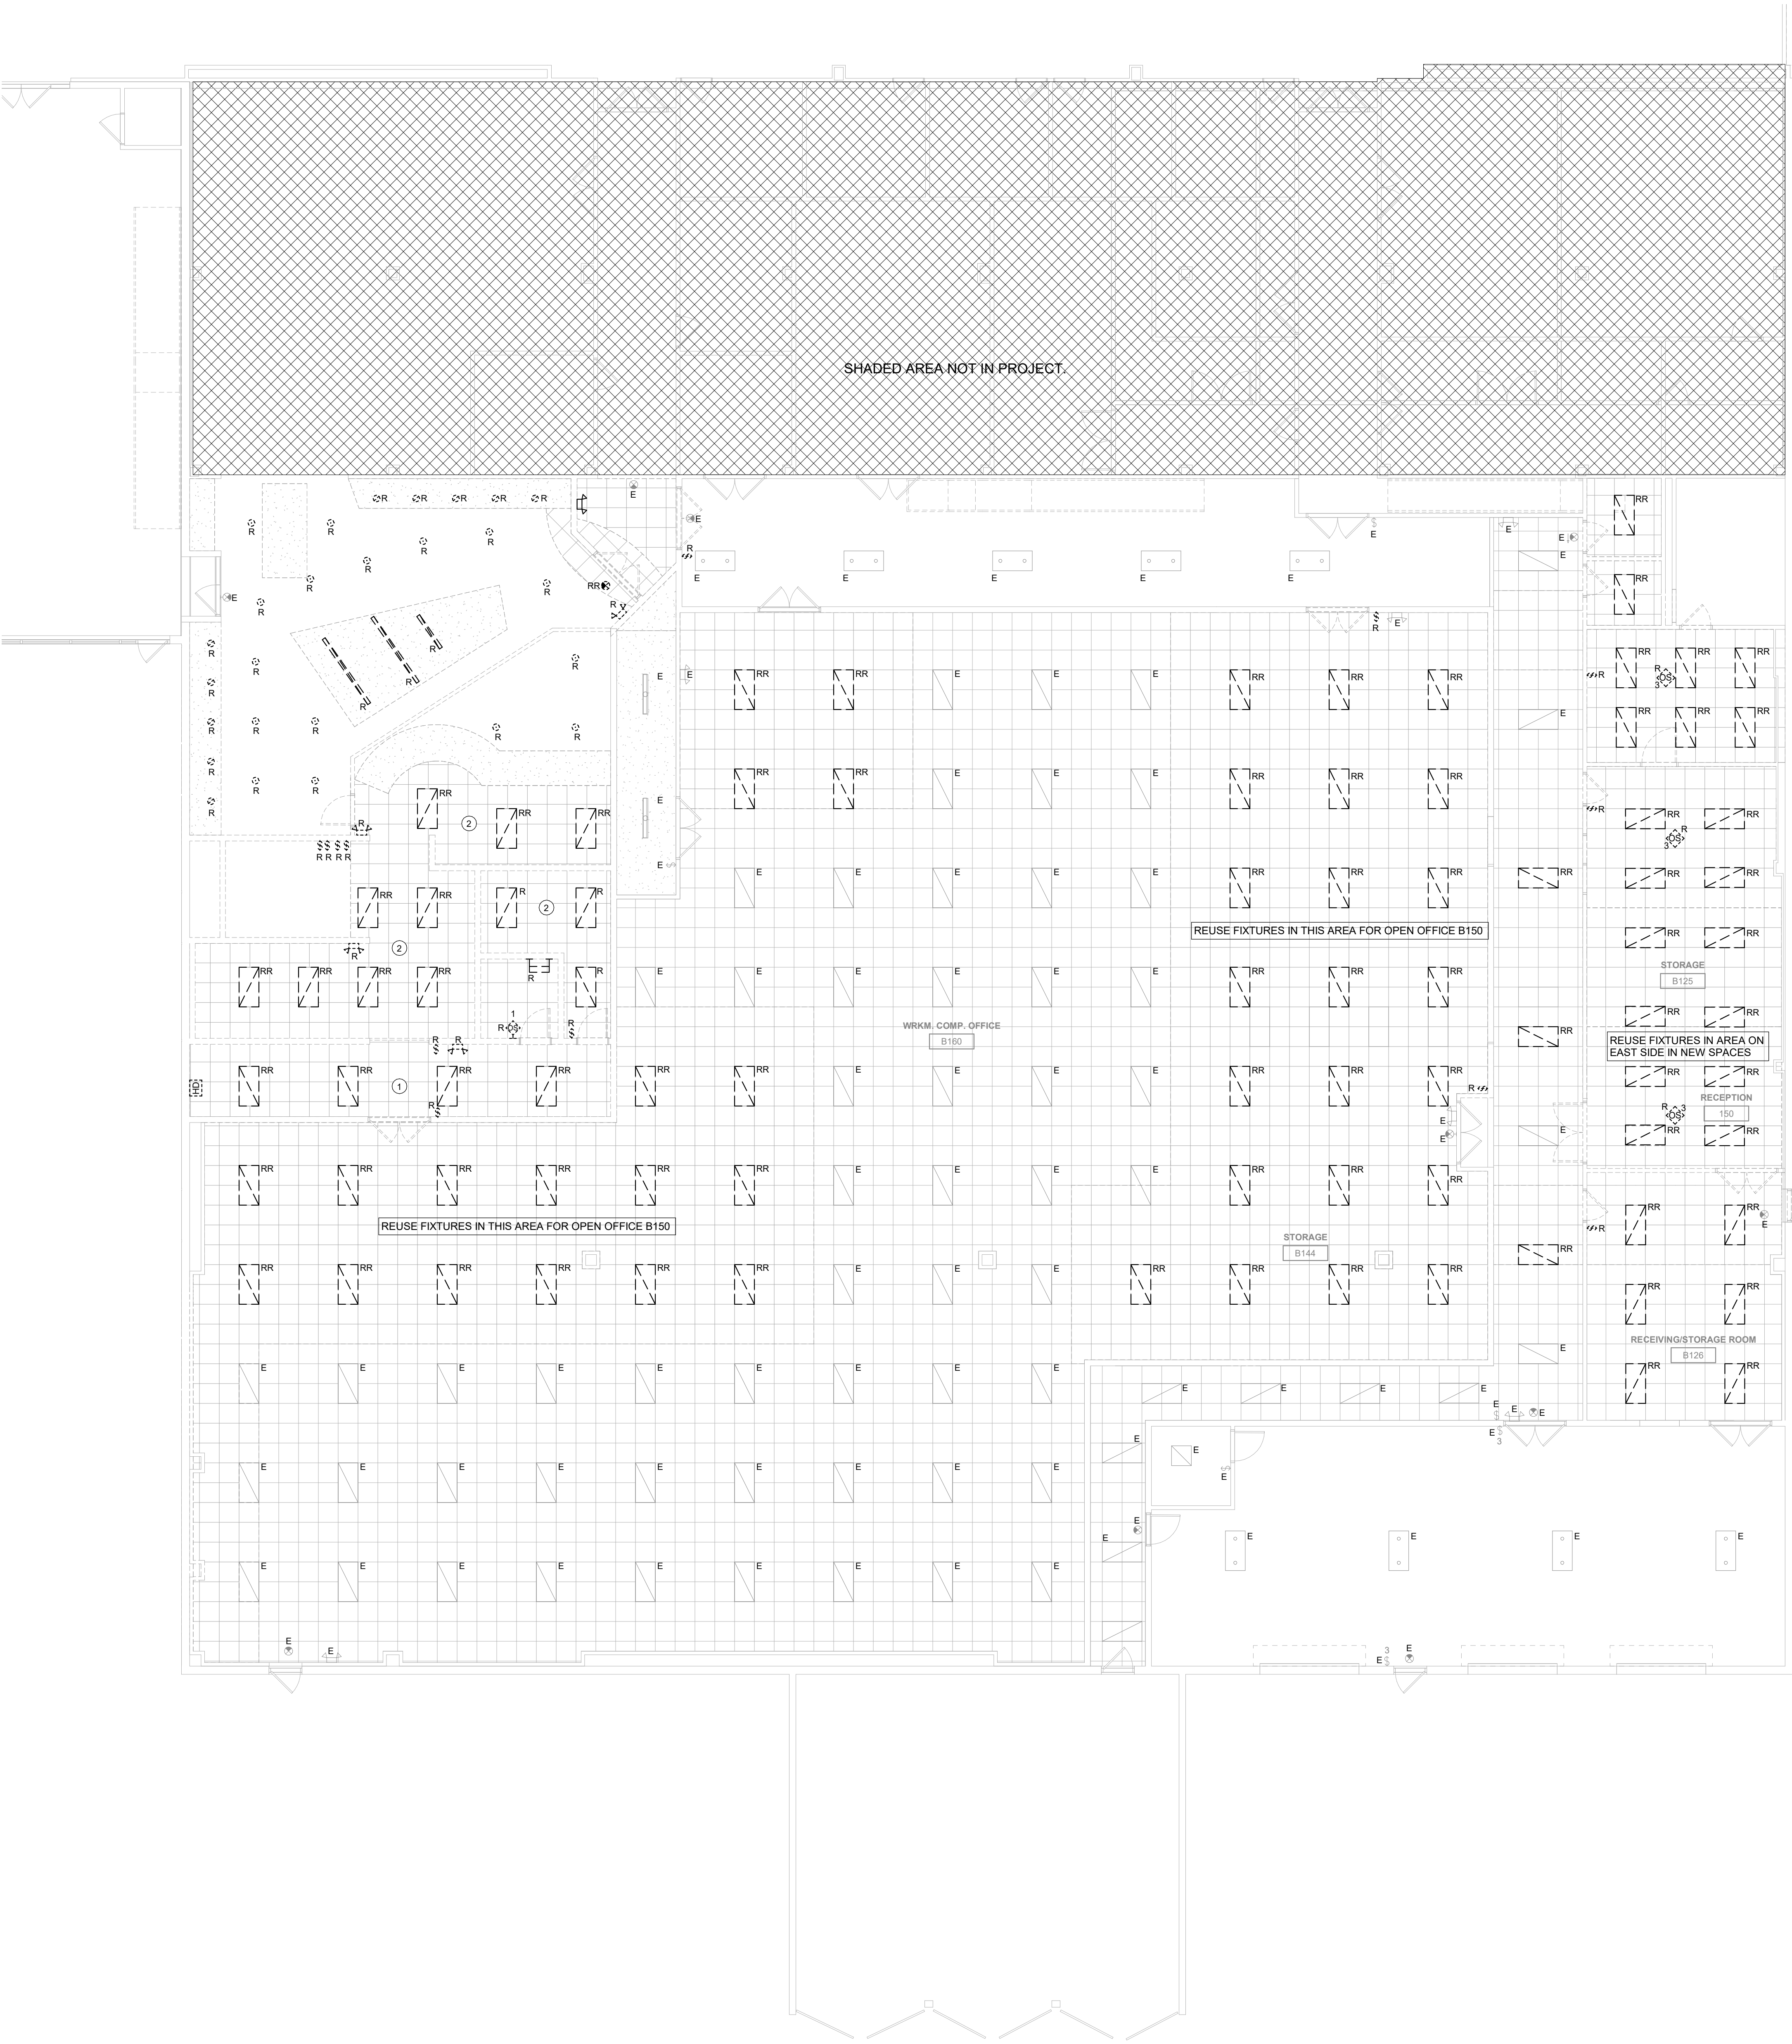

1 ELECTRICAL DEMO LIGHTING PLAN
1/8" = 1'-0"

Key Plan:


Revision Description Date

OPN Project No.
24816000


Sheet Issue Date
100% CONSTRUCTION 8/16/24
DRAWING SET

Sheet Name
ELECTRICAL LIGHTING
DEMO
Sheet Number

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1 ELECTRICAL POWER & SYSTEMS PLAN
1/8" = 1'-0"

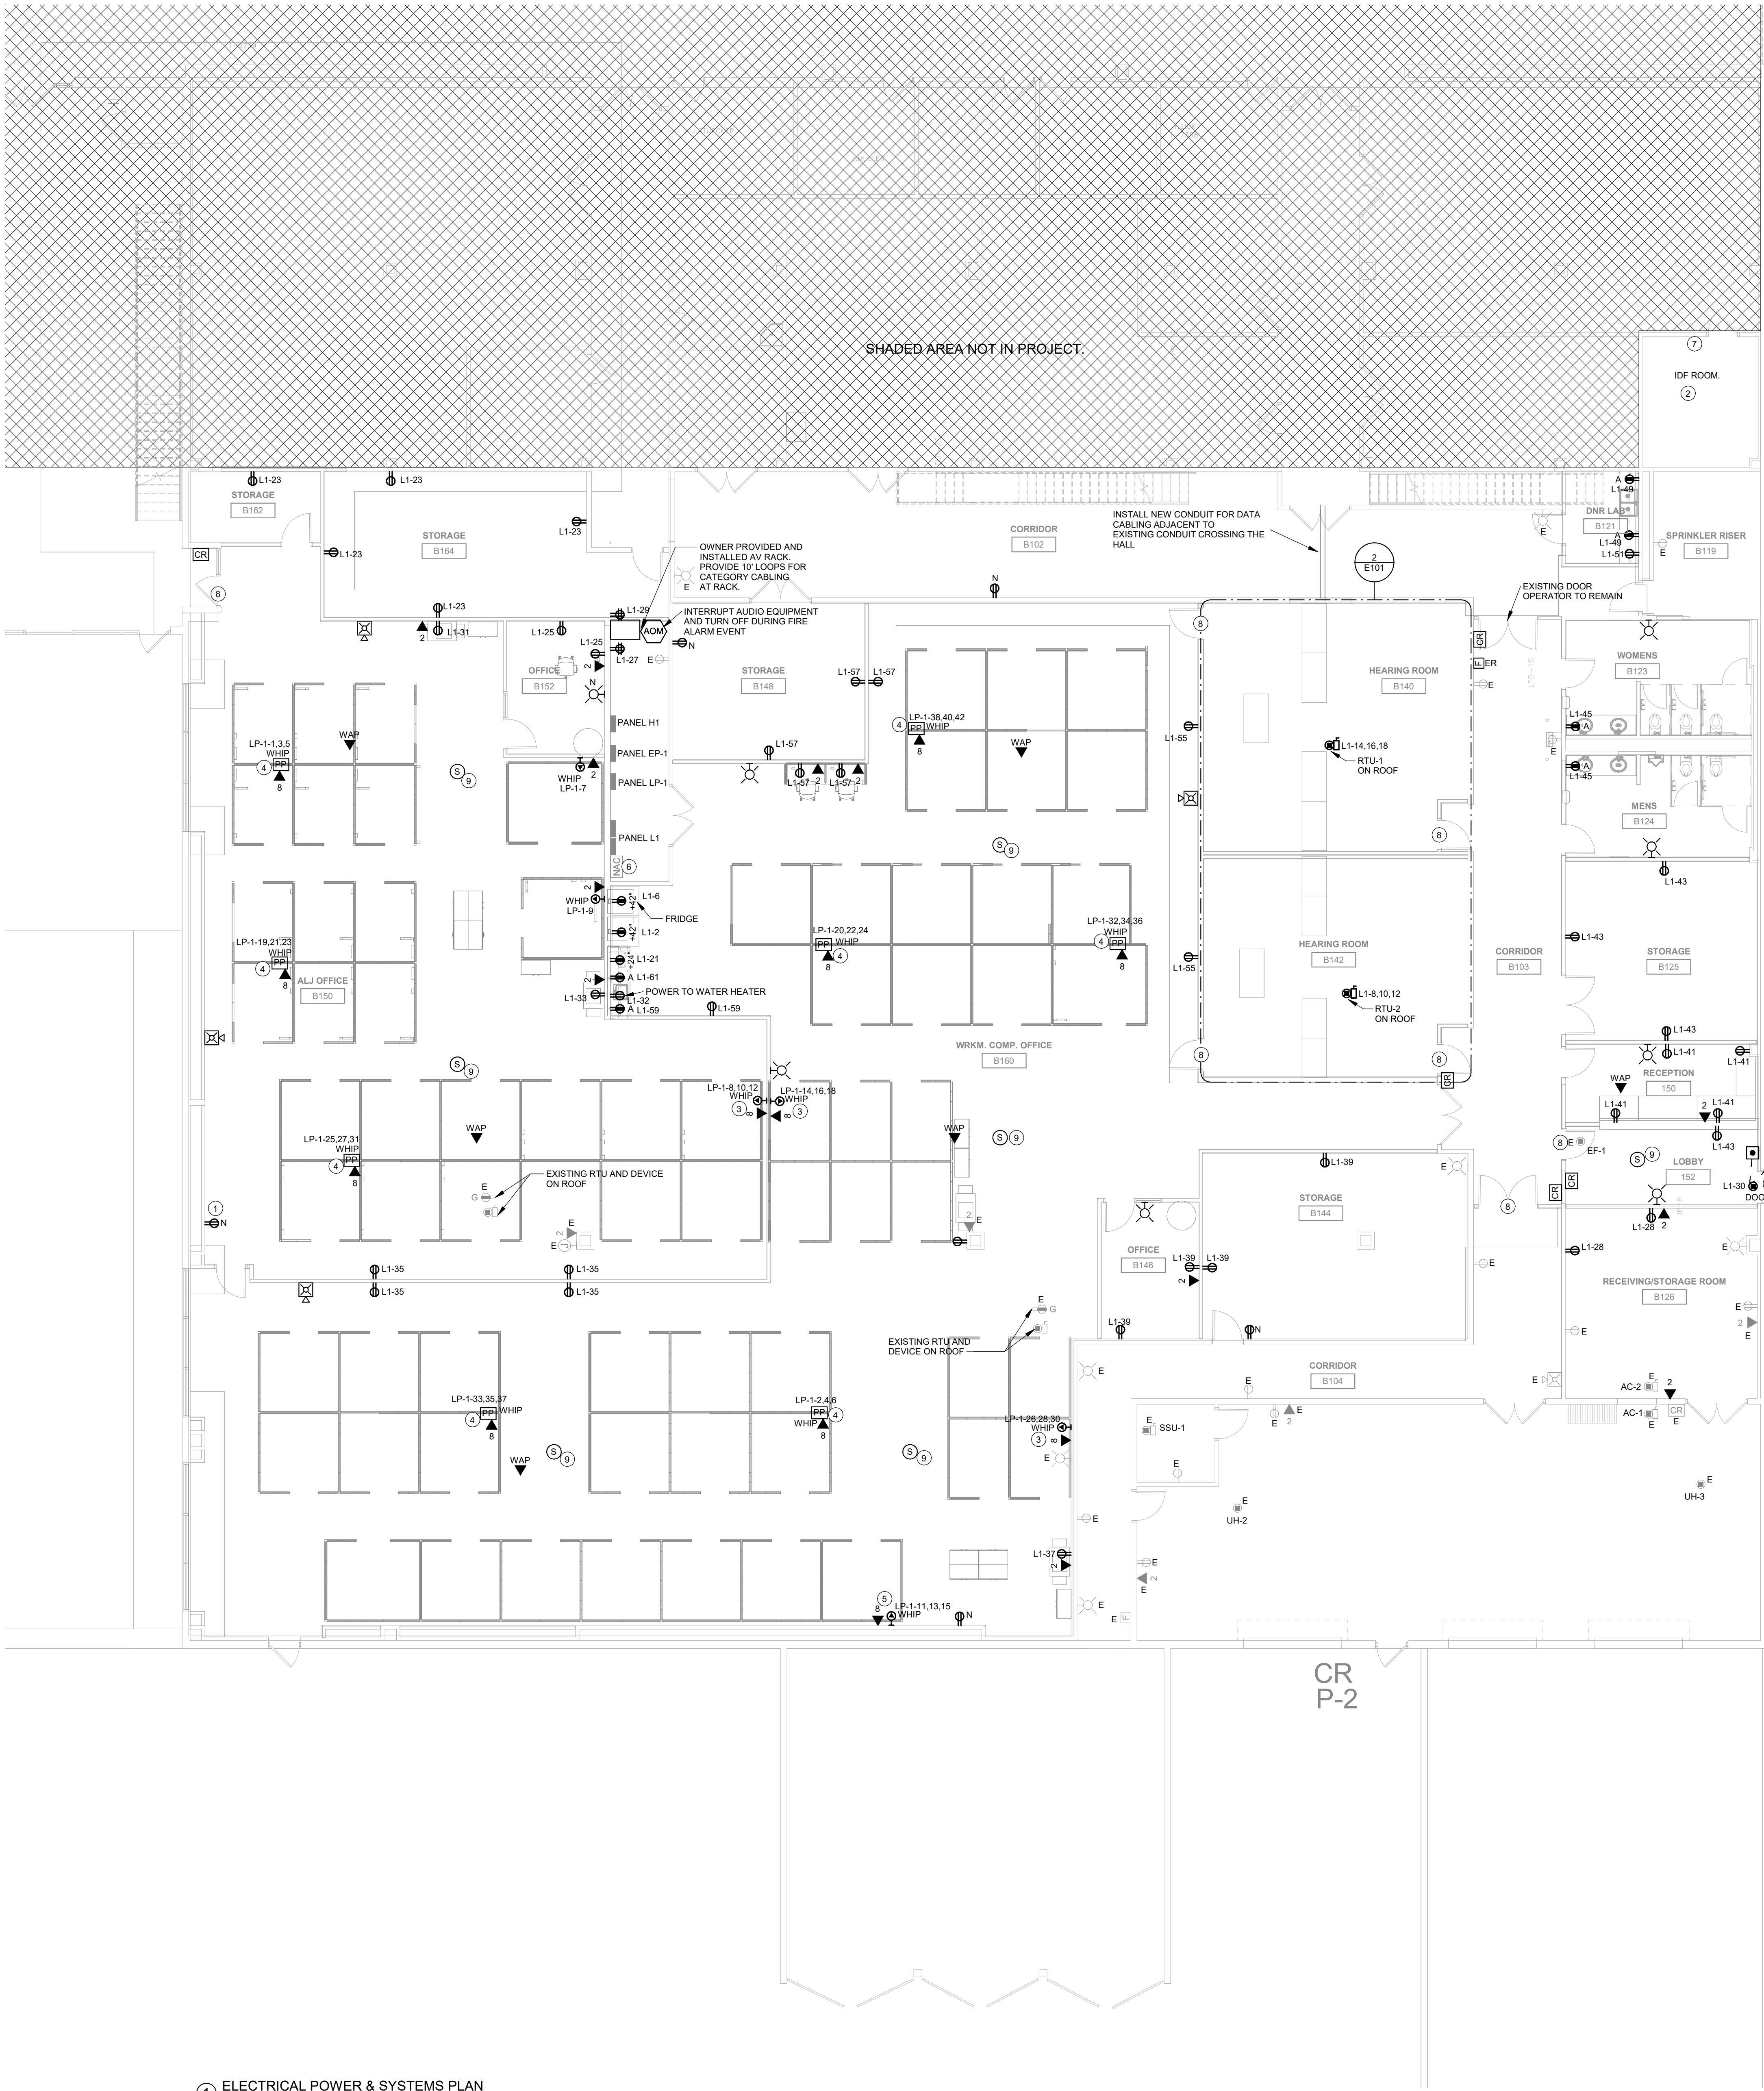

2 ELECTRICAL ENLARGED HEARING ROOM
1/4" = 1'-0"

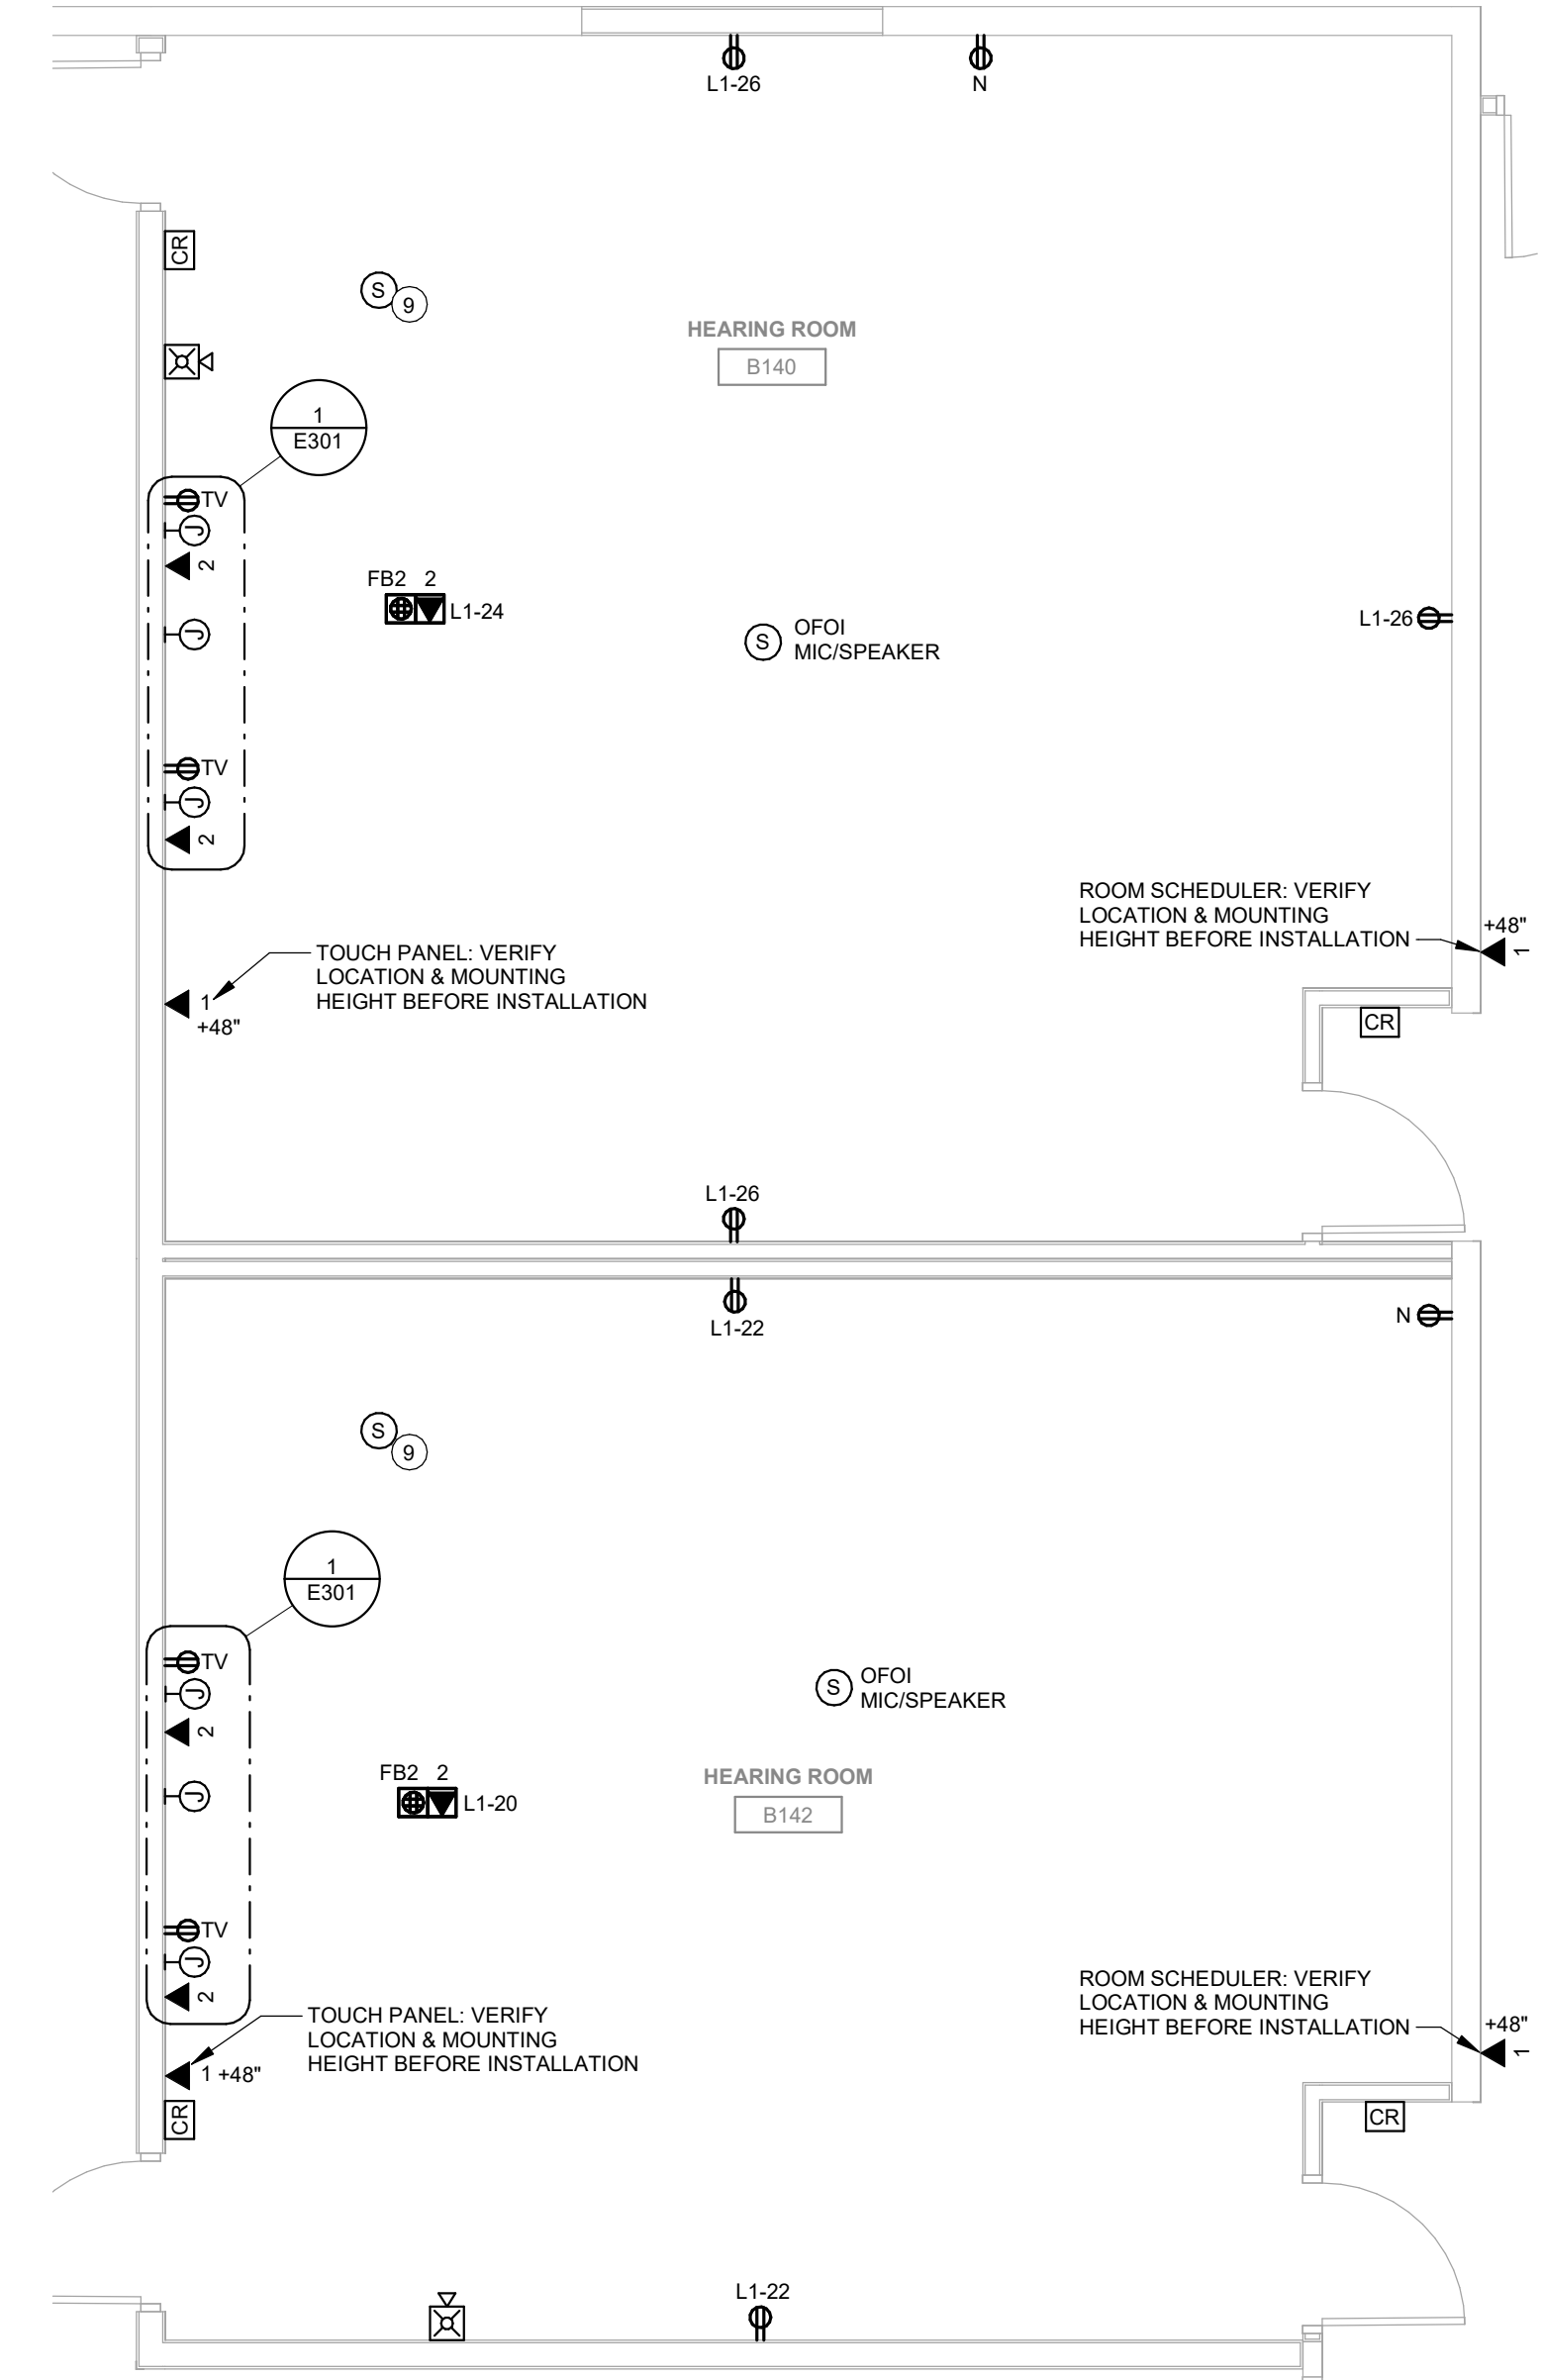POWER GENERAL NOTES


- A. COORDINATE LOCATION/INSTALLATION OF MECHANICAL AND ELECTRICAL WORK WITH ALL OTHER TRADES. NO ASPECT OF A SYSTEM INSTALLATION OR ITS ROUGH-IN SHALL COMMENCE UNTIL PROPER AND TIMELY COORDINATION WITH ALL TRADES ASSOCIATED WITH THE INSTALLATION HAS TRANSPIRED. ITEMS TO BE COORDINATED SHALL INCLUDE BUT NOT BE LIMITED TO: BUILDING STRUCTURE, SHEET METAL, PIPING SYSTEMS, LIGHT FIXTURES, CONDUITS, CABLE TRAYS, ETC. REFER TO ALL GENERAL MECHANICAL AND ELECTRICAL DRAWINGS AND SPECIFICATIONS FOR THIS PROJECT.
- B. COORDINATE ELECTRICAL REQUIREMENTS FOR MECHANICAL UNITS WITH MECHANICAL CONTRACTOR AND FINAL MECHANICAL SHOP DRAWINGS.
- C. PROVIDE PENETRATIONS REQUIRED FOR ROUTING RACEWAYS THROUGH THE BUILDING. COORDINATE FIRE RATED WALL PENETRATIONS AND PROVIDE CONDUIT SLEEVES AND FIRE STOPPING TO MAINTAIN RATING.

TECH GENERAL NOTES

- A. COORDINATE LOCATION/INSTALLATION OF MECHANICAL AND ELECTRICAL WORK WITH ALL OTHER TRADES. NO ASPECT OF A SYSTEM INSTALLATION OR ITS ROUGH-IN SHALL COMMENCE UNTIL PROPER AND TIMELY COORDINATION WITH ALL TRADES ASSOCIATED WITH THE INSTALLATION HAS TRANSPIRED. ITEMS TO BE COORDINATED SHALL INCLUDE BUT NOT BE LIMITED TO: BUILDING STRUCTURE, SHEET METAL, PIPING SYSTEMS, LIGHT FIXTURES, CONDUITS, CABLE TRAYS, ETC. REFER TO ALL GENERAL MECHANICAL AND ELECTRICAL DRAWINGS AND SPECIFICATIONS FOR THIS PROJECT.
- B. PROVIDE PENETRATIONS REQUIRED FOR ROUTING CABLEING AND RACEWAYS THROUGH THE BUILDING. COORDINATE FIRE RATED WALL PENETRATIONS AND PROVIDE CONDUIT SLEEVES AND FIRE STOPPING TO MAINTAIN RATING.
- C. PROVIDE J-HOOKS, BRIDLE RINGS AND OTHER ACCESSORIES REQUIRED TO SUPPORT ALL TELECOMMUNICATIONS AND SECURITY MANAGEMENT SYSTEM CABLEING.

KEYNOTES

- 1 CONNECT NEW DEVICE TO EXISTING CIRCUITED LOCATED IN EXISTING LOCATION.
- 2 PROVIDE 15' LOOPS OF DATA CABLEING ABOVE THE CEILING IN DATA CLOSET. BUNDLE AND LABEL EACH LOOP. COORDINATE INSTALL WITH OWNER. TERMINATION AND FINAL INSTALL WILL BE COMPLETED BY OWNER.
- 3 FURNITURE SYSTEM WHIP CONNECTION POINT VIA WALL MOUNTED CONNECTION JUNCTION BOX. COORDINATE LOCATION WITH FURNITURE PROVIDER. INSTALL (3) 120V 20A-1P CIRCUITS, (3) #12 HOT, (3) #12 NEUTRAL, (1) #12 EGC, AND (1) #12 ISOLATED EGC. INSTALL (8) DATA LOOPS ABOVE CEILING. LOOPS TO INCLUDE THE FOLLOWING (4) 25' LOOPS, (2) 35' LOOPS, AND (2) 45' LOOPS. BUNDLE AND TAG SEPERATELY FOR EACH LOOP.
- 4 FURNITURE SYSTEM WHIP CONNECTION POINT VIA CEILING MOUNTED CONNECTION. POWER POLES PROVIDED WITH FURNITURE UNIT. PROVIDE CONDUCTORS DOWN POWER POLE TO FURNITURE CONNECTION POINT. COORDINATE LOCATION WITH FURNITURE PROVIDER. INSTALL (3) 120V 20A-1P CIRCUITS, (3) #12 HOT, (3) #12 NEUTRAL, (1) #12 EGC, AND (1) #12 ISOLATED EGC. INSTALL (8) DATA LOOPS ABOVE CEILING. LOOPS TO INCLUDE THE FOLLOWING (4) 25' LOOPS, (2) 35' LOOPS, AND (2) 45' LOOPS. BUNDLE AND TAG SEPERATELY FOR EACH LOOP.
- 5 FURNITURE SYSTEM WHIP CONNECTION POINT VIA WALL MOUNTED CONNECTION JUNCTION BOX. COORDINATE LOCATION WITH FURNITURE PROVIDER. INSTALL (3) 120V 20A-1P CIRCUITS, (3) #12 HOT, (3) #12 NEUTRAL, (1) #12 EGC, AND (1) #12 ISOLATED EGC. INSTALL (8) DATA LOOPS ABOVE CEILING. LOOPS TO INCLUDE THE FOLLOWING (4) 25' LOOPS, (2) 35' LOOPS, AND (2) 45' LOOPS. BUNDLE AND TAG SEPERATELY FOR EACH LOOP.
- 6 EXISTING NOTIFIER FIRE ALARM SYSTEM. FIRE ALARM PANEL IS NFS2-640IE INSTALLED NEAR THE FRONT ENTRANCE IN THE BUILDING. INSTALL NEW DEVICES ON EXISTING SYSTEM.
- 7 EXTEND EXISTING 120V CIRCUIT FOR ACCESS CONTROL PANEL TO NEW PANEL. COORDINATE LOCATION AND INSTALLATION WITH OWNER.
- 8 INSTALL (2) 1/2" FLEXIBLE CONDUITS TO THE DOOR FRAME ON BOTH SIDES OF THE DOOR FOR PATHWAYS TO THE STRIKE AND HINGE FOR OWNER PROVIDED ACCESS CONTROL INTEGRATION.
- 9 INSTALL EMERGENCY ANNOUNCEMENT SYSTEM IN RENOVATED AREA. INSTALL SPEAKERS AND EXTEND EXISTING SYSTEM. VERIFY LOCATION AND VOLUME LEVELS WITH OWNER.

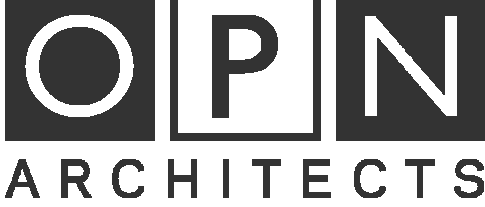

100 Court Ave., Suite 100
Des Moines, IA 50309
P: 515-309-0722
www.opnarchitects.com

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Owner:

STATE OF IOWA - DEPARTMENT OF
ADMINISTRATIVE SERVICES
1305 E WALNUT ST
DES MOINES, IA 50319

Project:

9411.00 - 6200 PARK ALI
WORKMAN'S CAMP RENOVATION
6200 PARK AVE
DES MOINES, IA 50321

Construction Manager:

DCI GROUP
220 SE 6TH ST - SUITE 200
DES MOINES, IA 50309
P: 515-244-5043

Civil Engineer:

CIVIL ENGINEERING
CONSULTANTS
2400 86TH ST - UNIT 12
DES MOINES, IA 50322
P: 515-276-7084

Structural Engineer:

RAKER RHODES ENGINEERING
4717 GRAND AVE
DES MOINES, IA 50312
P: 515-277-0275

Mechanical Engineer:

KCL ENGINEERING
300 4TH ST
WEST DES MOINES, IA 50265
P: 515-724-7938

Electrical Engineer:

KCL ENGINEERING
300 4TH ST
WEST DES MOINES, IA 50265
P: 515-724-7938

Key Plan:

Revision Description Date


OPN Project No.
24816000

Sheet Issue Date
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DRAWING SET
Sheet Name
ELECTRICAL POWER & SYSTEMS

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1 ELECTRICAL LIGHTING PLAN
1/8" = 1'-0"



LIGHTING GENERAL NOTES

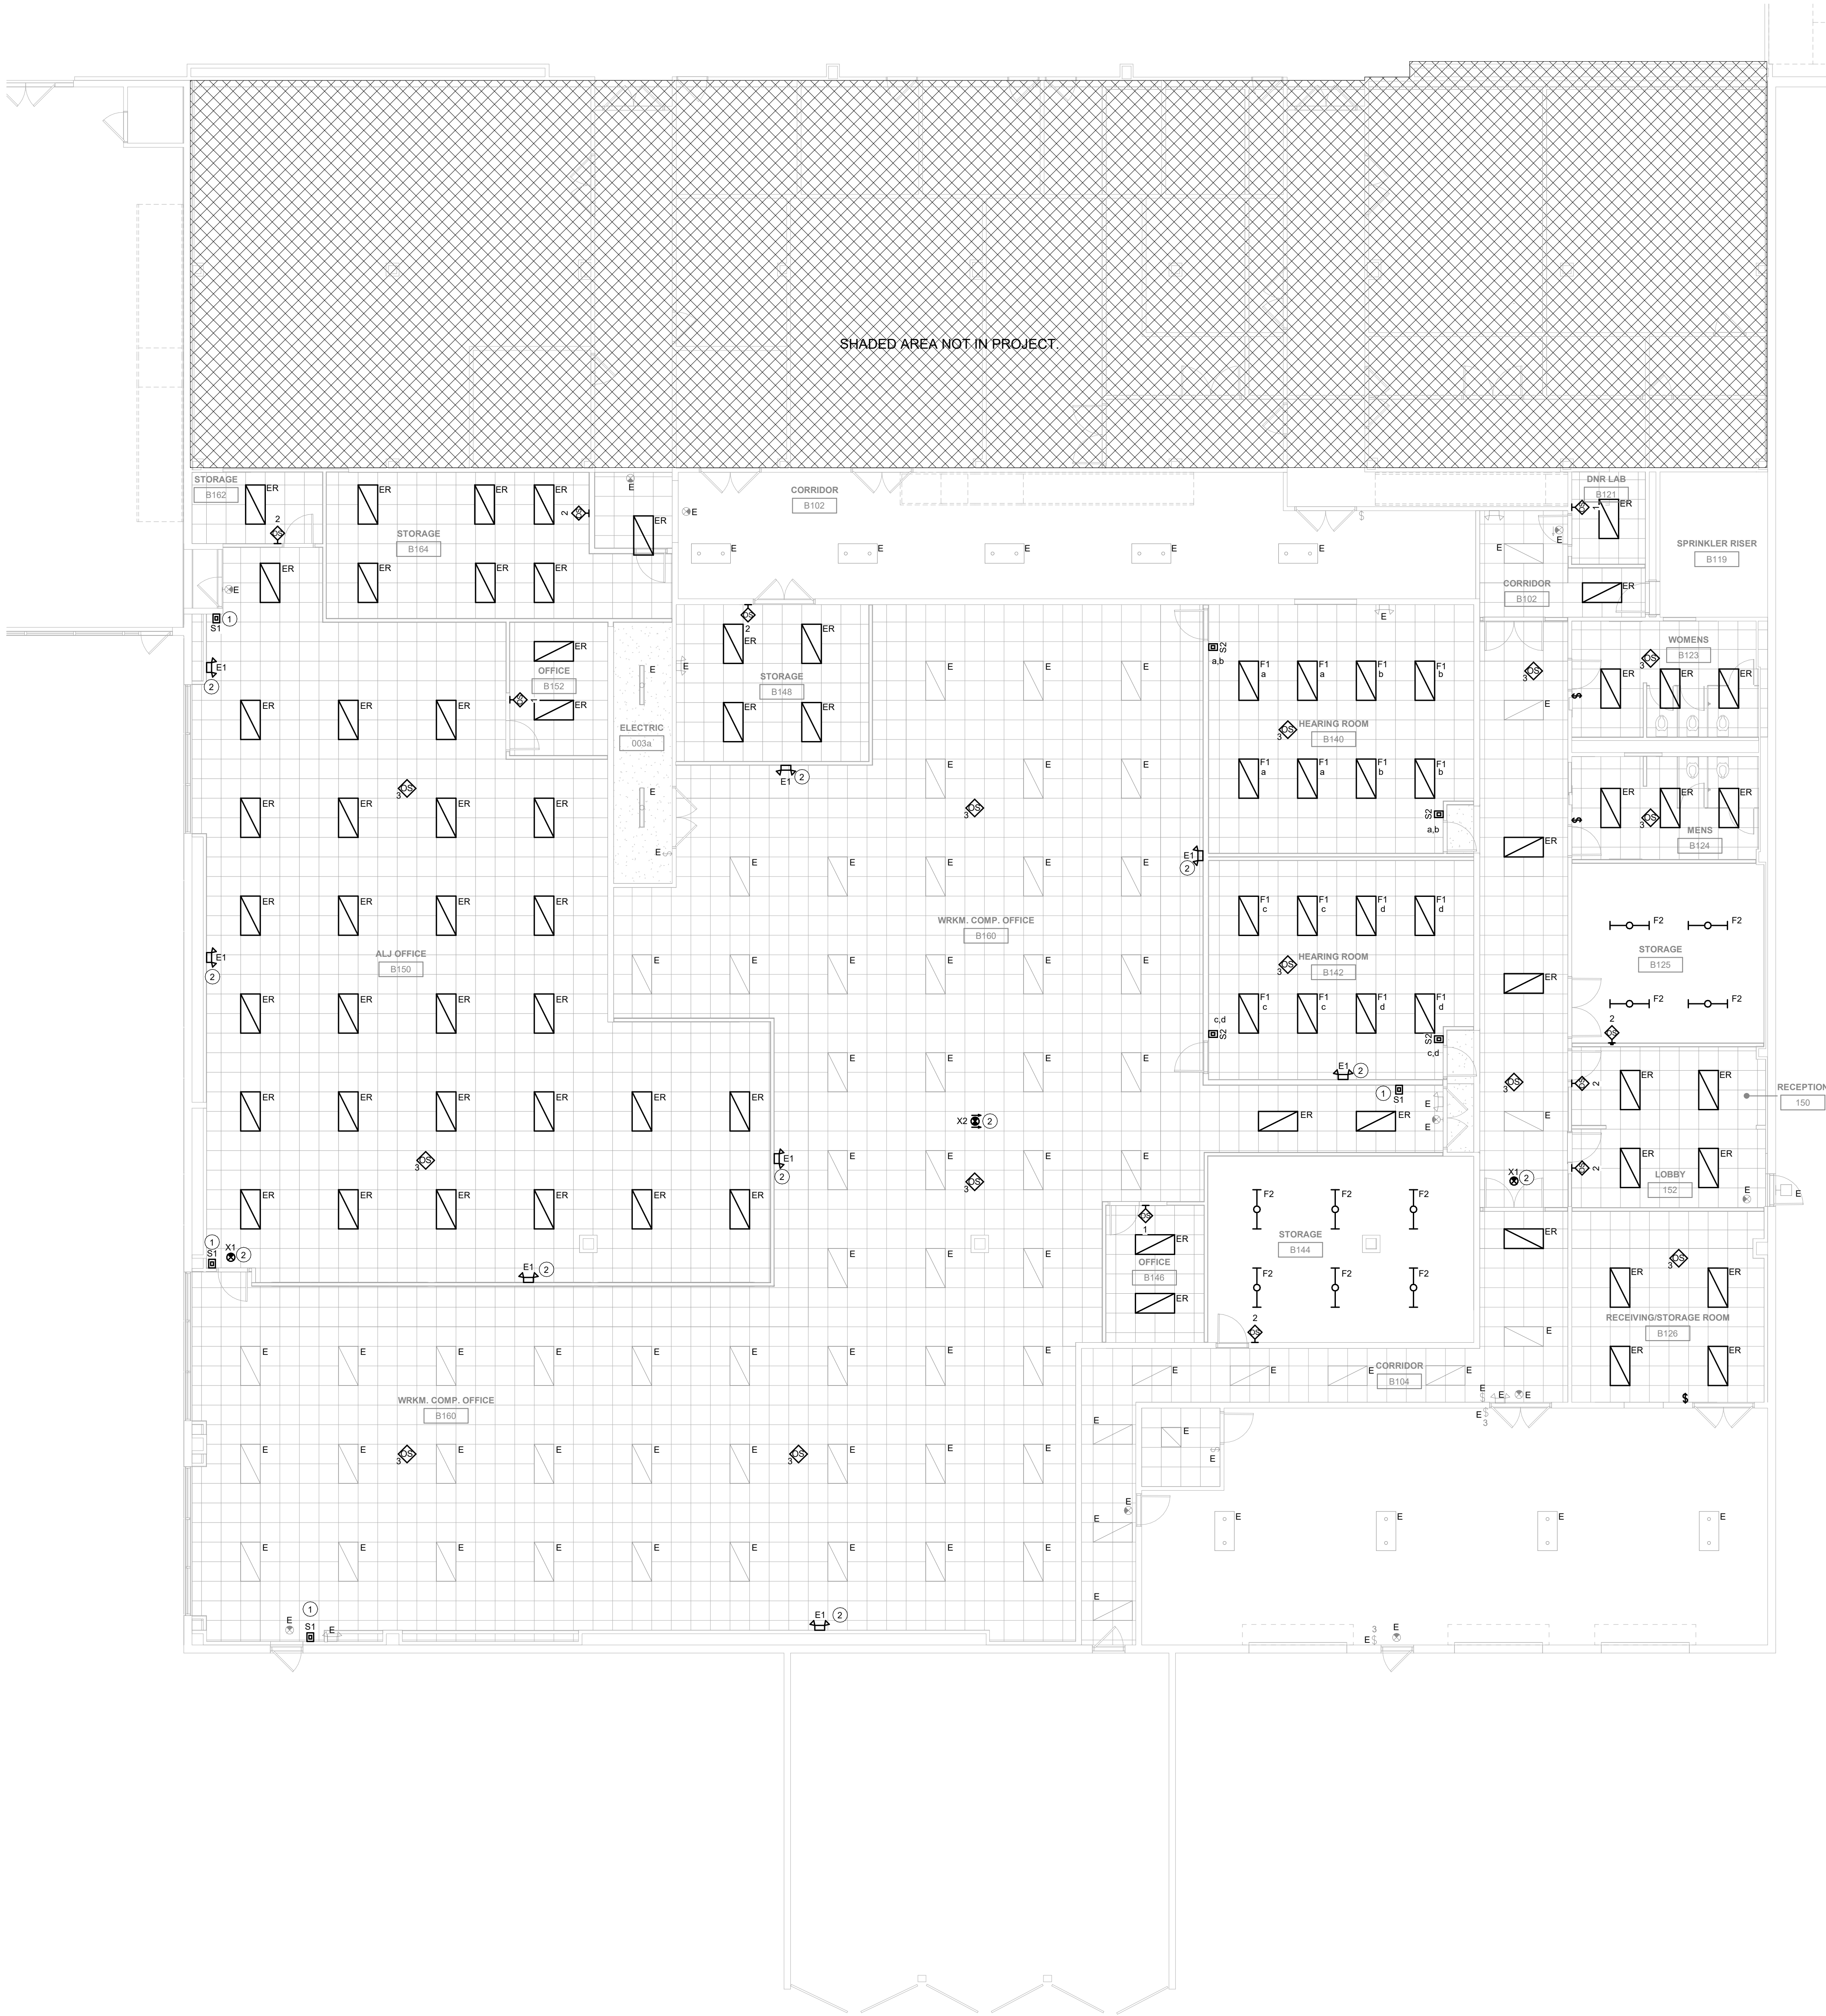- A. COORDINATE LOCATION/INSTALLATION OF MECHANICAL AND ELECTRICAL WORK WITH ALL OTHER TRADES. NO ASPECT OF A SYSTEM INSTALLATION OR ITS ROUGH-IN SHALL COMMENCE UNTIL PROPER AND TIMELY COORDINATION WITH ALL TRADES ASSOCIATED WITH THE INSTALLATION HAS TRANSPIRED. ITEMS TO BE COORDINATED SHALL INCLUDE BUT NOT BE LIMITED TO: BUILDING STRUCTURE, SHEET METAL, ALL PIPING SYSTEMS, LIGHT FIXTURES, CONDUITS, CABLE TRAYS, ETC. REFER TO ALL GENERAL, MECHANICAL, AND ELECTRICAL DRAWINGS AND SPECIFICATIONS FOR THIS PROJECT.

KEYNOTES

- 1 REWIRE FIXTURES IN SPACES AS NECESSARY FOR THE NEW SWITCH LOCATIONS SO THE ENTIRE SPACE SWITCHES ON/OFF WITH NEW SWITCHES.
2 PROVIDE POWER TO EMERGENCY FIXTURES FROM CONSTANT HOT LIGHTING CIRCUIT IN SPACE.

Key Plan

Revision Description Date

ALL PANELS ARE EXISTING. REUSE EXISTING BREAKERS AS APPLICABLE FOR NEW BRANCH CIRCUITS

BRANCH PANEL: EP-1														
LOCATION: ELECTRIC 003a					VOLTAGE: 120/208 WYE					SCCR RATING: EXISTING				
SUPPLY FROM:					PHASES: 3					MAINS TYPE: MCB				
MOUNTING: SURFACE					WIRES: 4					MAINS RATING: 225 A				
ENCLOSURE: TYPE 1										MCB RATING: 225 A				
NOTES:														

BRANCH PANEL: H1															
LOCATION: ELECTRIC 003a					VOLTAGE: 480/277 WYE					SCCR RATING: EXISTING					
SUPPLY FROM:					PHASES: 3					MAINS TYPE: MCB					
MOUNTING: SURFACE					WIRES: 4					MAINS RATING: 200 A					
ENCLOSURE: TYPE 1					MCB RATING: 200 A										
NOTES:															
CIRCUIT DESCRIPTION			P	AMP	CKT NO	A		B		C		CKT NO	AMP	P	CIRCUIT DESCRIPTION
(E) EWH-1			3	-- 20 A	1	0	0					2		20 A -- 3	(E) XFMR T1
					3			0	0			4			
					5					0	0	6			
(E) RTU-1			3	-- 20 A	7	0	--					8	-- -- 1		SPACE
					9			0	--			10	-- -- 1		SPACE
					11					0	--	12	-- -- 1		SPACE
					13	0	--					14	-- -- 1		SPACE
(E) RTU-2			3	-- 20 A	15			0	--			16	-- -- 1		SPACE
					17					0	-- 18	-- -- 1		SPACE	
(E) LIGHTING			1	-- 20 A	19	0	--					20	-- -- 1		SPACE
(E) LIGHTING			1	-- 20 A	21			0	--			22	-- -- 1		SPACE
SPACE			1	-- --	23					-- --	24	-- -- 1			SPACE
SPACE			1	-- --	25	--	--					26	-- -- 1		SPACE
SPACE			1	-- --	27			--	--			28	-- -- 1		SPACE
SPACE			1	-- --	29					-- --	30	-- -- 1			SPACE
SPACE			1	-- --	31	--	--					32	-- -- 1		SPACE
SPACE			1	-- --	33			--	--			34	-- -- 1		SPACE
SPACE			1	-- --	35					-- --	36	-- -- 1			SPACE
SPACE			1	-- --	37	--	--					38	-- -- 1		SPACE
SPACE			1	-- --	39			--	--			40	-- -- 1		SPACE
SPACE			1	-- --	41					-- --	42	-- -- 1			SPACE
						0 VA		0 VA		0 VA					
						0 A		0 A		0 A					
LEGEND:															
"G" INDICATES GFCI TYPE BREAKER, "L" INDICATES PROVIDE LOCKABLE HASP															
"F" INDICATES RED LOCK-ON HASP, "E" INDICATES EXISTING CIRCUIT															
LOAD CLASSIFICATION		CONNECTED LOAD			DEMAND FACTOR			ESTIMATED DEMAND			PANEL TOTALS				
											TOTAL CONN. LOAD: 0 VA				
											TOTAL EST. DEMAND: 0 VA				
											TOTAL CONN.: 0 A				
											TOTAL EST. DEMAND: 0 A				
NOTES:															

BRANCH PANEL: L1				LOCATION: ELECTRIC 003a				VOLTAGE: 120/208 WYE				SCCR RATING: EXISTING			
SUPPLY FROM:				PHASES: 3				MAINS TYPE: MLO				MAINS RATING: 225 A			
MOUNTING: SURFACE				WIRES: 4				MCB RATING: 225 A							
ENCLOSURE: TYPE 1															
NOTES:															
CIRCUIT DESCRIPTION		P	AMP	CKT NO	A	B	C	CKT NO	AMP	P	CIRCUIT DESCRIPTION				
(E) RECEPTACLE		1	--	20 A	1	0	1200		2	20 A	G	1	FRIDGE (GFCI BREAKER)		
(E) RECEPTACLE		1	--	20 A	3		0	0	4	20 A	--	1	(E) LIGHTING		
(E) RECEPTACLE		1	--	20 A	5				6	20 A	G	1	FRIDGE (GFCI BREAKER)		
(E) RECEPTACLE		1	--	20 A	7	0	2306		8						
(E) RECEPTACLE		1	--	20 A	9			0	2306			30 A	3	RTU-2	
(E) RECEPTACLE		1	--	20 A	11			0	2306						
(E) RECEPTACLE		1	--	20 A	13	0	2306		14						
(E) RECEPTACLE		1	--	20 A	15		0	2306	16			30 A	3	RTU-1	
(E) RECEPTACLE		1	--	20 A	17			0	2306	18					
(E) RECEPTACLE		1	--	20 A	19	0	360		20	20 A	1			RECEPTACLE	
MICROWAVE (GFCI BREAKER)		1	G	20 A	21		1600	360	22	20 A	1			RECEPTACLE	
RECEPTACLE		1		20 A	23			900	360	24	20 A	1		RECEPTACLE	
RECEPTACLE		1		20 A	25	360	540			26	20 A	1		RECEPTACLE	
RECEPTACLE		1		20 A	27		360	360		28	20 A	1		RECEPTACLE	
RECEPTACLE		1		20 A	29			360	192	30	20 A	1		DOOR OPERATOR	
RECEPTACLE		1		20 A	31	180	180			32	20 A	G	1	WATER HEATER	
RECEPTACLE		1		20 A	33			180		34					
RECEPTACLE		1		20 A	35				720	36					
RECEPTACLE		1		20 A	37	180				38					
RECEPTACLE		1		20 A	39			720		40					
RECEPTACLE		1		20 A	41				720	42					
RECEPTACLE		1		20 A	43	720				44					
RECEPTACLE		1		20 A	45			360		46					
				47						48					
RECEPTACLE		1		20 A	49	360				50					
RECEPTACLE		1		20 A	51			180		52					
(E) LIGHTING		1	--	20 A	53				0	54					
RECEPTACLE		1		20 A	55	360				56					
RECEPTACLE		1		20 A	57			900		58					
RECEPTACLE		1		20 A	59				360	60					
RECEPTACLE		1		20 A	61	180				62					
(E) COOLER & HEATER		1	--	20 A	63			0		64					
SPACE		1	--	--	65				--	66					
SPACE		1	--	--	67	--				68					
SPACE		1	--	--	69		--			70					
SPACE		1	--	--	71				--	72					
SPACE		1	--	--	73	--	--			74	--	--	1	SPACE	
SPACE		1	--	--	75		--	--		76	--	--	1	SPACE	
SPACE		1	--	--	77				--	78	--	--	1	SPACE	
SPACE		1	--	--	79	--	--			80	--	--	1	SPACE	
SPACE		1	--	--	81		--	--		82	--	--	1	SPACE	
SPACE		1	--	--	83				--	84	--	--	1	SPACE	
					9,231 VA		9,631 VA		9,423 VA						
					77 A		81 A		79 A						
LEGEND:															
"G" INDICATES GFCI TYPE BREAKER, "L" INDICATES PROVIDE LOCKABLE HASP															
"F" INDICATES RED LOCK-ON HASP, "E" INDICATES EXISTING CIRCUIT															
LOAD CLASSIFICATION		CONNECTED LOAD		DEMAND FACTOR		ESTIMATED DEMAND		PANEL TOTALS							
POWER		14,026 VA		100.00%		14,026 VA									
RECEPTACLE		14,260 VA		85.06%		12,130 VA		TOTAL CONN. LOAD: 28,286 VA							
								TOTAL EST. DEMAND: 26,156 VA							
								TOTAL CONN.: 79 A							
								TOTAL EST. DEMAND: 73 A							
NOTES:															