


# 9375.00 - DOC 5JD FT DES MOINES BLDG 65-66 ROOF REPLACEMENT

68 THAYER ST, DES MOINES, IA 50315

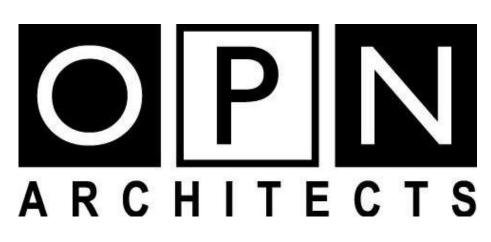


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ARCHITECT

OPN ARCHITECTS **100 COURT AVENUE** DES MOINES, IA 50309 CONSTRUCTION MANAGER

SAMUELS GROUP 2929 WESTOWN PARKWAY, SUITE 200 WEST DES MOINES, IA 50266



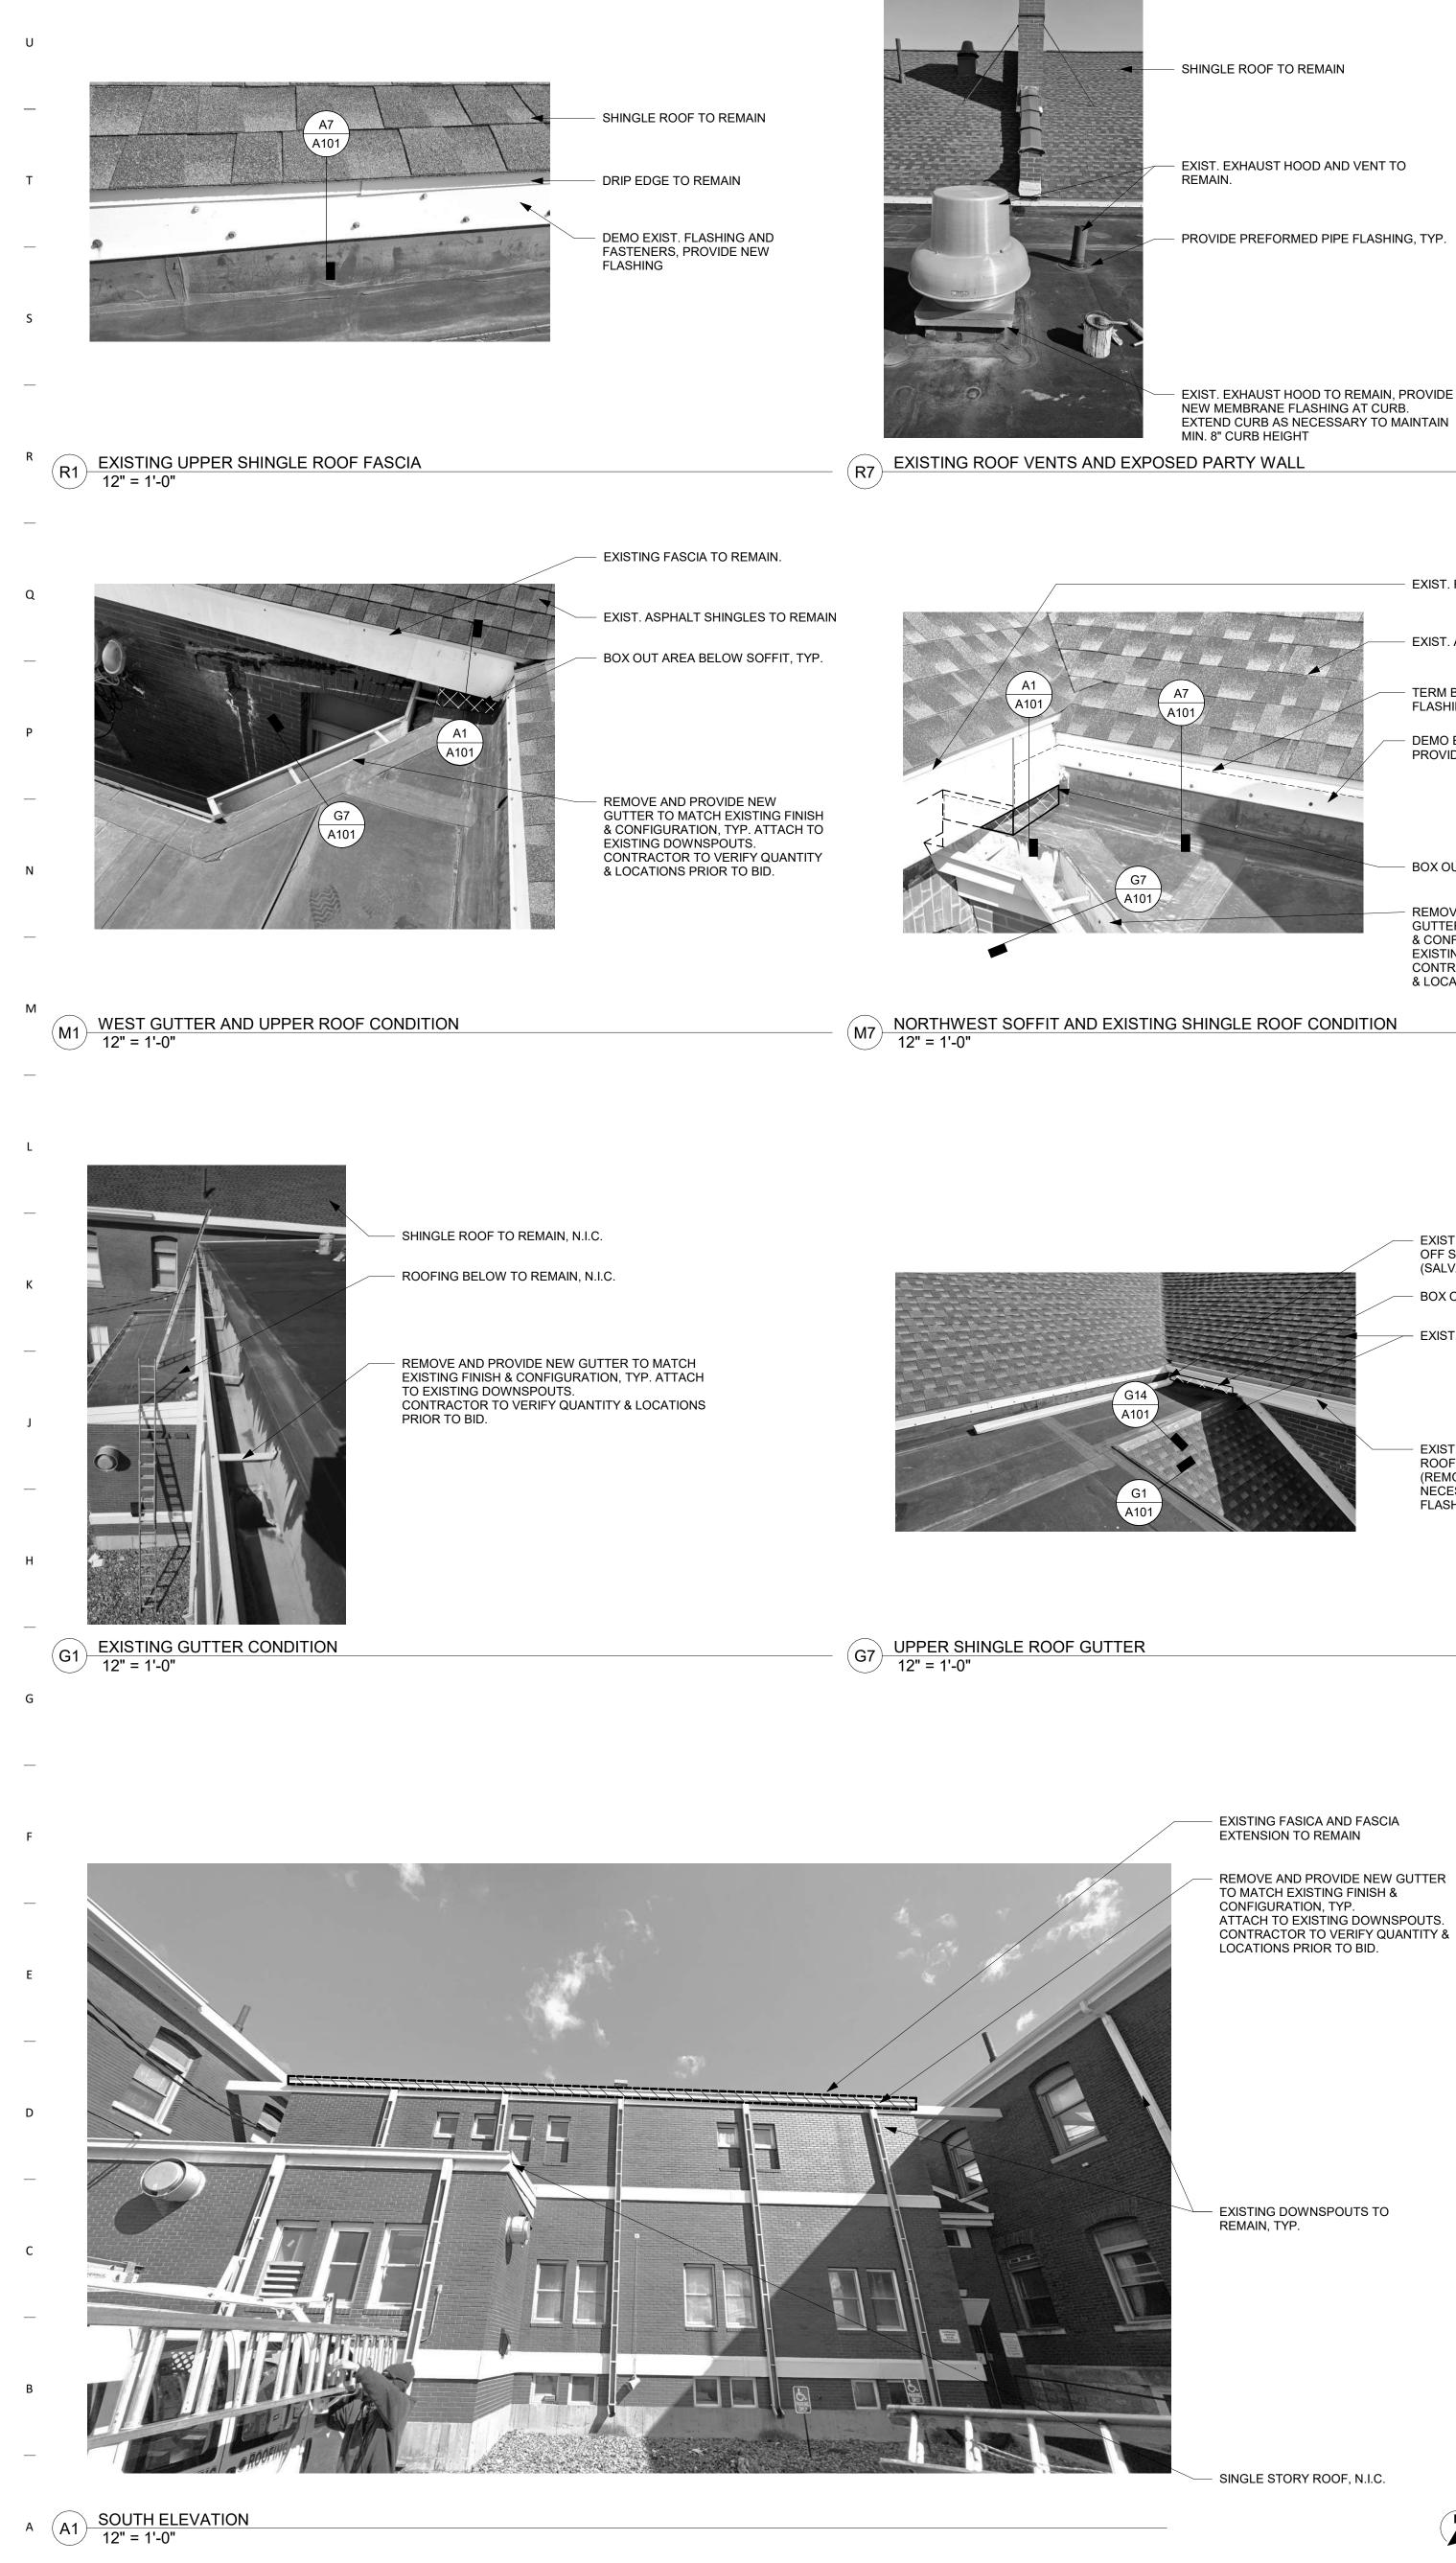

6

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8

1 2 3 4 5


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13

14

15


11

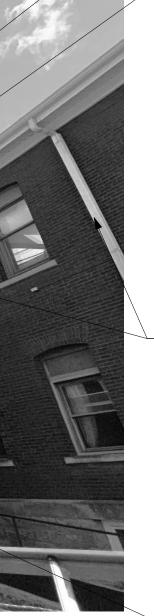

9

EXISTING DOWNSPOUTS TO

10

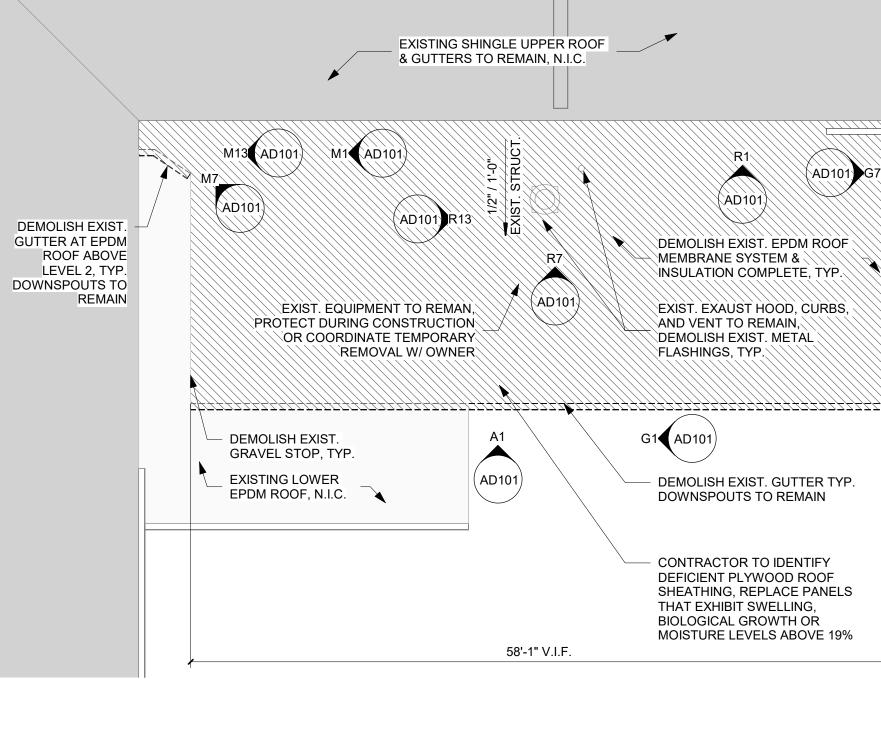

G13 LOWER SHINGLE ROOF


12" = 1'-0"

EXIST. GUTTER ON SHINGLE ROOF TO REMAIN, N.I.C. (REMOVE AND REINSTALL AS NECESSARY TO INSTALL NEW

FLASHING)

BOX OUT UNDER SOFFIT - EXIST. SHINGLE ROOF TO REMAIN

EXIST. DOWNSPOUT EXTENSION OFF SHINGLE ROOF TO REMAIN. (SALVAGE AND REINSTALL)

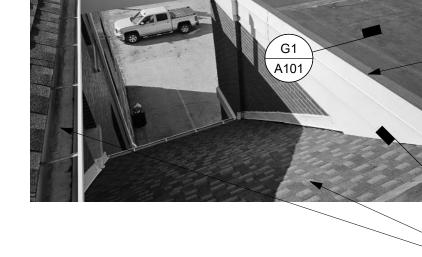

(G14)

\A101

16

- BOX OUT AREA BELOW SOFFIT, TYP. REMOVE AND PROVIDE NEW

GUTTER TO MATCH EXISTING FINISH

& CONFIGURATION, TYP. ATTACH TO

CONTRACTOR TO VERIFY QUANTITY

EXISTING DOWNSPOUTS.

& LOCATIONS PRIOR TO BID.

FLASHING DEMO EXIST. FLASHING AND FASTENERS, PROVIDE NEW FLASHING

- EXIST. ASPHALT SHINGLES TO REMAIN

TERM BAR & SEALANT BEHIND COUNTER


- EXIST. FASCIA TO REMAIN

EXIST. EXHAUST HOOD TO REMAIN, PROVIDE

PROVIDE PREFORMED PIPE FLASHING, TYP.


- EXIST. EXHAUST HOOD AND VENT TO

#### SOFFIT CONDITION (M13)-12" = 1'-0"

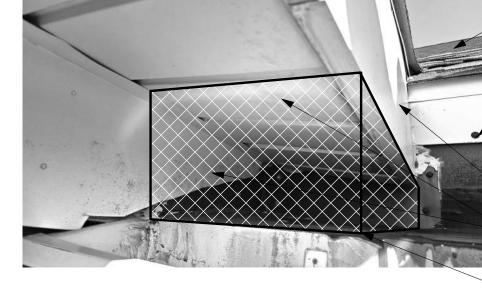

R13 EXISTING ROOF VENTS 12" = 1'-0"



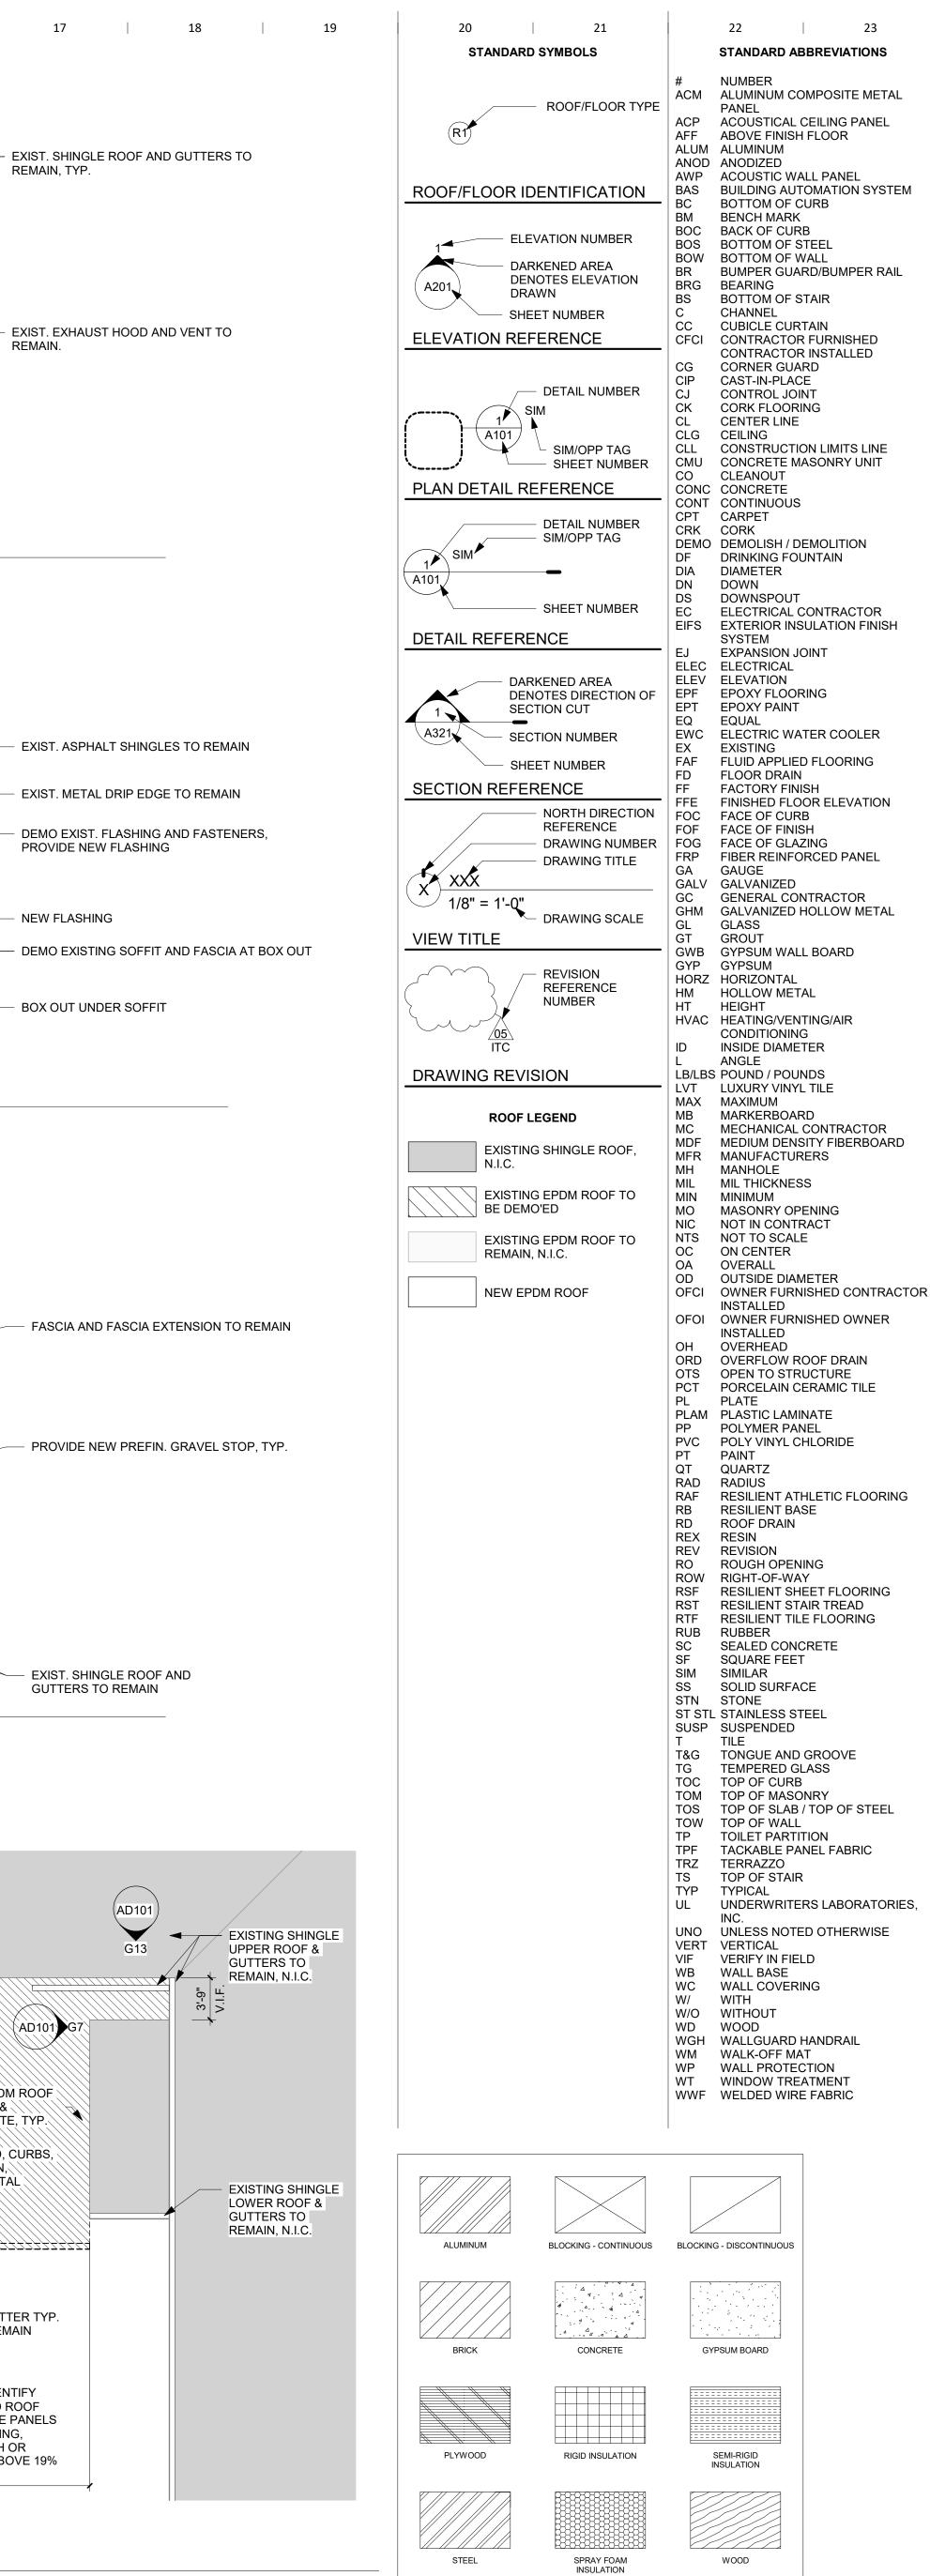

17 18 19 20 21 22 

STEEL

23

WOOD

24

25

**GENERAL NOTES** 

24

DRAWINGS.

ALL DRAWINGS.

ALL DRAWINGS.

OPERATIONS.

INSTALLATION.

DIMENSIONS ARE MEASURED FACE OF-FINISH TO FACE-OF-FINISH OR ROUGH MASONRY OPENING UNLESS NOTED OTHERWISE - TYPICAL FOR ALI FIELD VERIFY ALL DIMENSIONS AND **EXISTING CONDITIONS - TYPICAL FOR** 

IN THE EVENT OF A DISCREPANCY BETWEEN ARCHITECTURAL AND CONSULTANT DRAWINGS, NOTIFY ARCHITECT IMMEDIATELY PRIOR TO **COMMENCING WORK - TYPICAL FOR** 

THIS FACILITY WILL REMAIN IN **OPERATION THROUGHOUT THE** DURATION OF THE PROJECT. COORDINATE ALL ROOFING ACTIVITIES WITH THE OWNER TO MINIMIZE INTERFERENCE OF DAILY

CONTRACTOR TO IDENTIFY AND REPLACE DEFICIENT PLYWOOD ROOF SHEATHING, REPLACE PANELS THAT EXHIBIT SWELLING, BIOLOGICAL GROWTH OR MOISTURE LEVELS

ABOVE 19%. CONFIRM LOCATIONS W/ ARCHITECT PRIOR TO REPLACING. VERIFY LOCATIONS OF ALL ROOF PENETRATIONS. PROVIDE BOOTS, FLASHING AND OTHER ACCESSORIES REQUIRED TO PROVIDE A COMPLETE, WATERTIGHT WARRANTED SYSTEM. REPLACE ONLY THE AMOUNT OF ROOFING THAT CAN BE COMPLETED AND MADE WEATHER TIGHT IN A

SINGLE WORK DAY. BUILDING INTERIOR MUST BE PROTECTED FROM INCLEMENT WEATHER AT THE END OF EACH WORK DAY. PROTECT SECTIONS OF THE ROOF THAT HAVE ALREADY BEEN INSTALLED.

ARE EXISTING TO REMAIN OR ARE NOT IN CONTRACT FROM DAMAGE. DO NOT USE THE ROOF FOR A STAGING AREA UNLESS ADEQUATE FACTORY MUTUAL APPROVED PROTECTION MEASURES ARE USED TO PROTECT THE ROOF

COORDINATE INSTALLATION OF ROOFING MEMBRANE WITH EXISTING MECHANICAL EQUIPMENT. 0. REMOVE EXISTING ROOFTOP VENTS AND OTHER ITEMS ONLY AS NECESSARY TO INSTALL NEW FLASHINGS AND ROOF MEMBRANE.

1. VERIFY ALL EXISTING ROOF DIMENSIONS, WIDTHS & HEIGHTS OF METAL EDGING CONDITIONS PRIOR TO 12. PROVIDE NEW METAL FLASHINGS AT

ALL PENETRATIONS AND PERIMETERS. 13. INSTALL NEW GUTTERS TO ACCOMMODATE EXISTING DOWNSPOUT LOCATIONS



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Owner

**STATE OF IOWA - DOC FIFTH JUDICIAL** DISTRICT 1305 E WALNUT ST

DES MOINES, IA 50319 Project


9375.00 - DOC 5JD FT DES MOINES **BLDG 65-66 ROOF REPLACEMENT** 68 THAYER ST DES MOINES, IA 50315

Construction Manager SAMUELS GROUP

2929 WESTOWN PARKWAY, SUITE 200 WEST DES MOINES, IA 50266 P. 515-288-0467

Key Plan

Revision Description

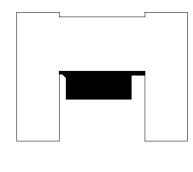


OPN Project No. 24805001


Sheet Issue Date BID SET

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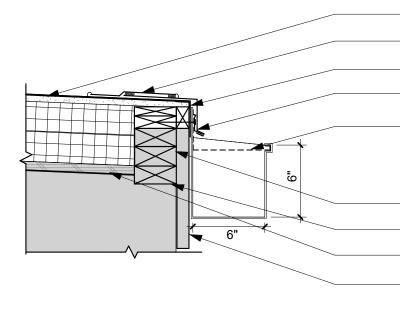
Sheet Name **DEMO ROOF PLAN AND EXISTING CONDITIONS** Sheet Number





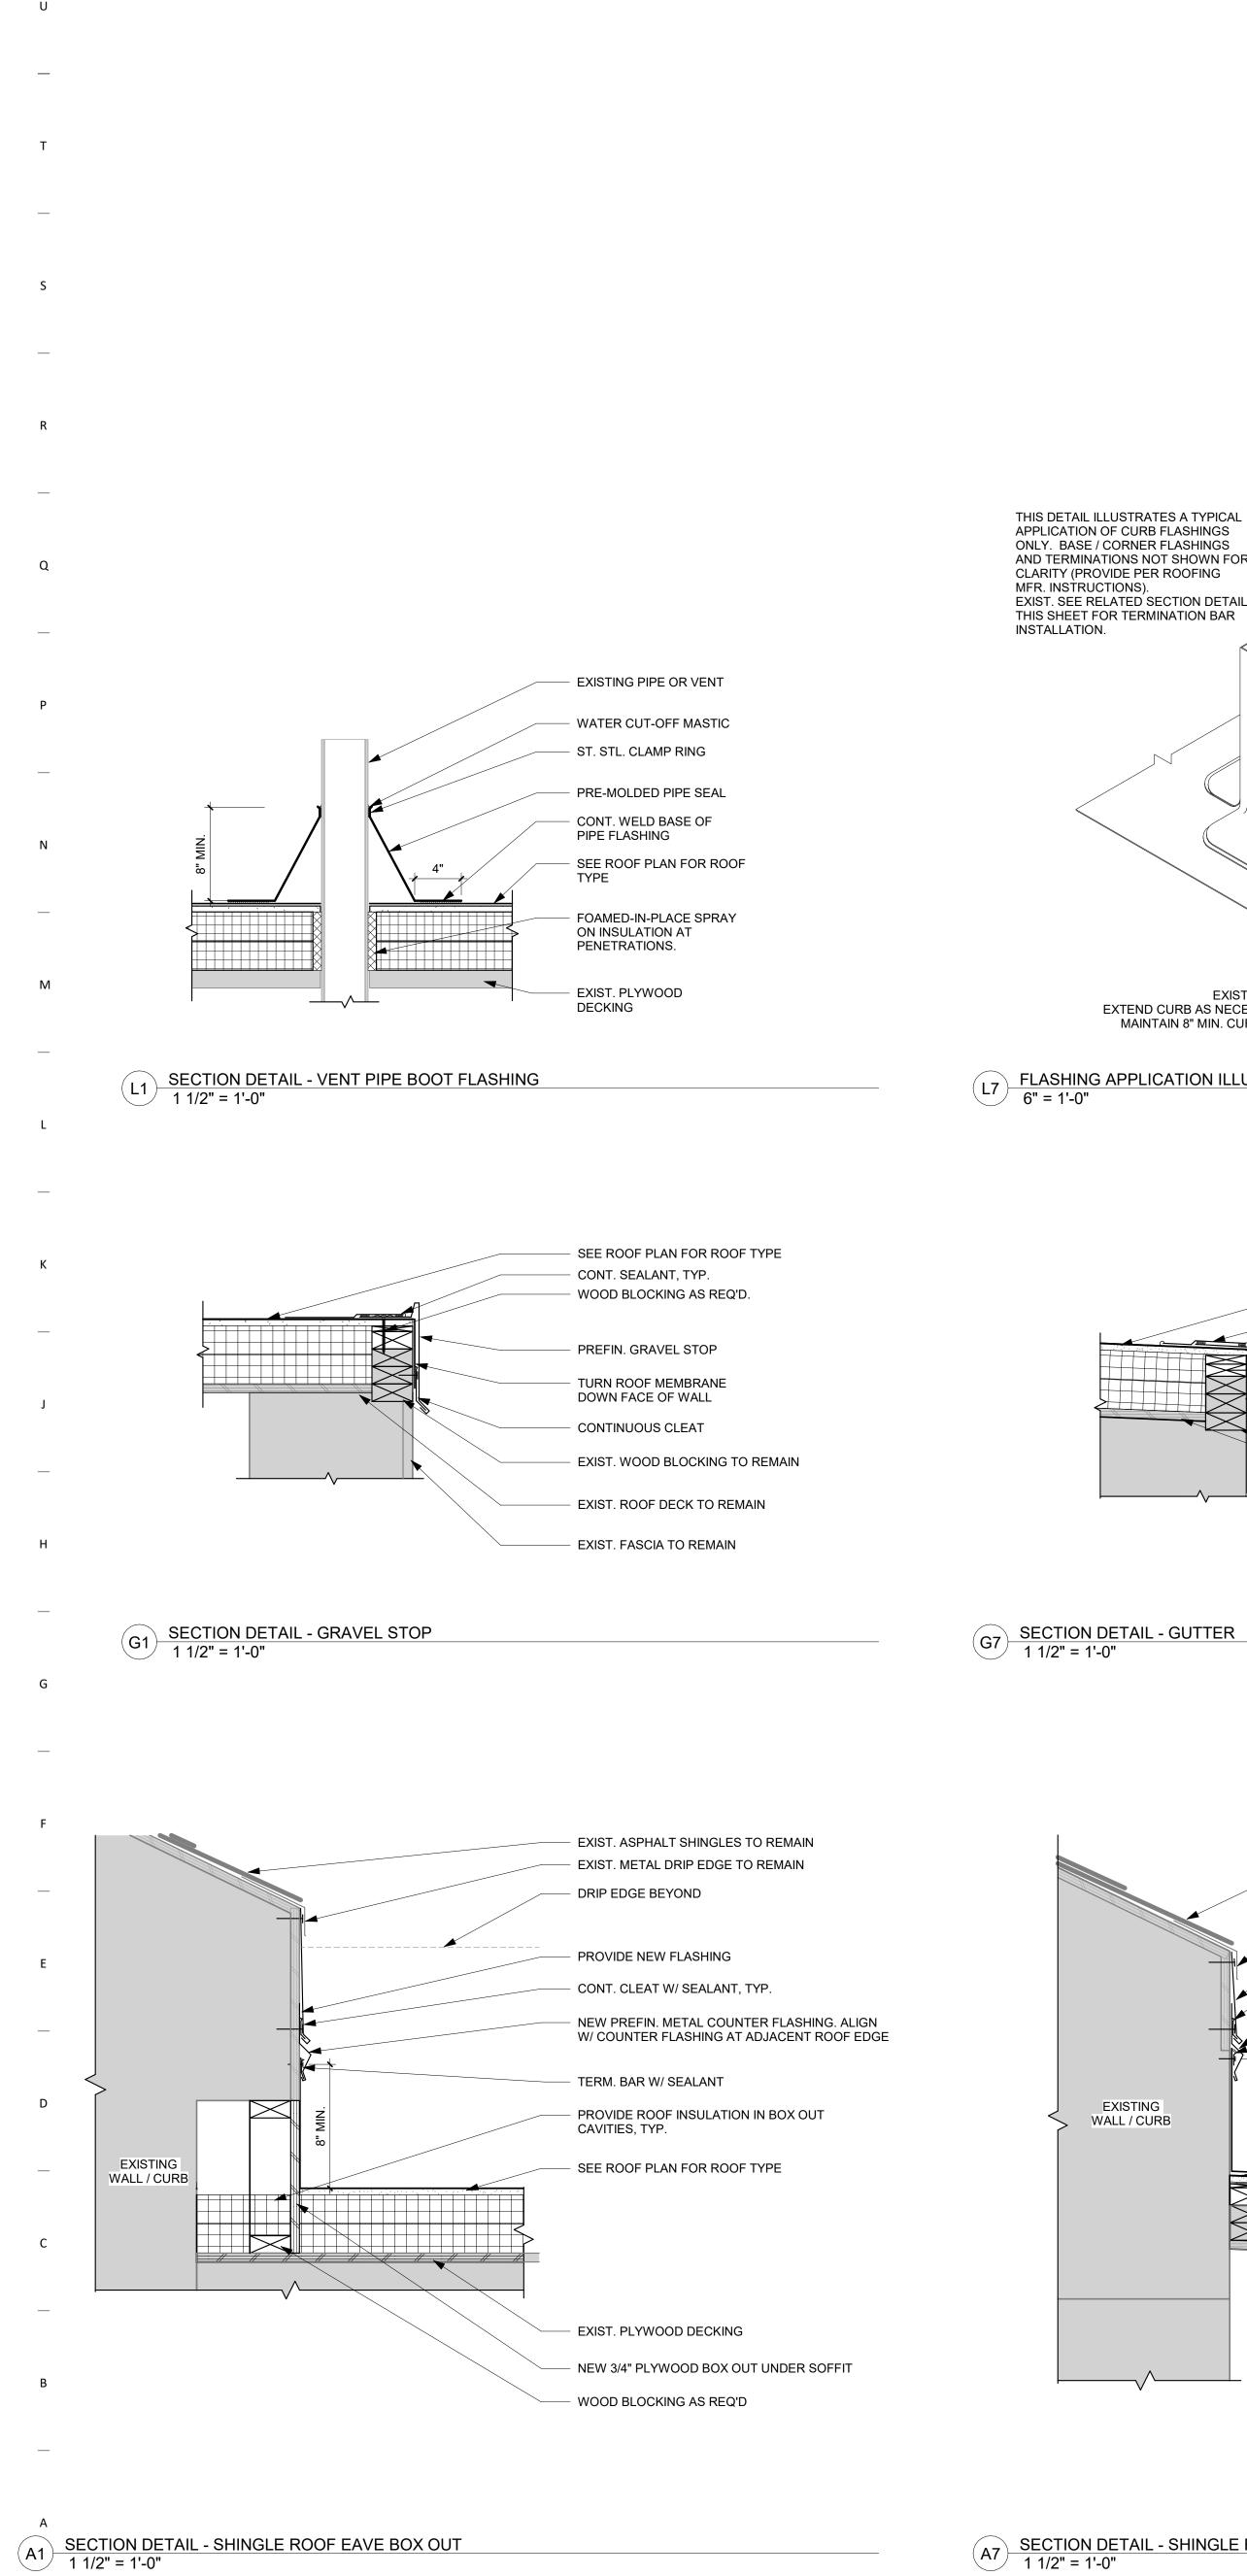

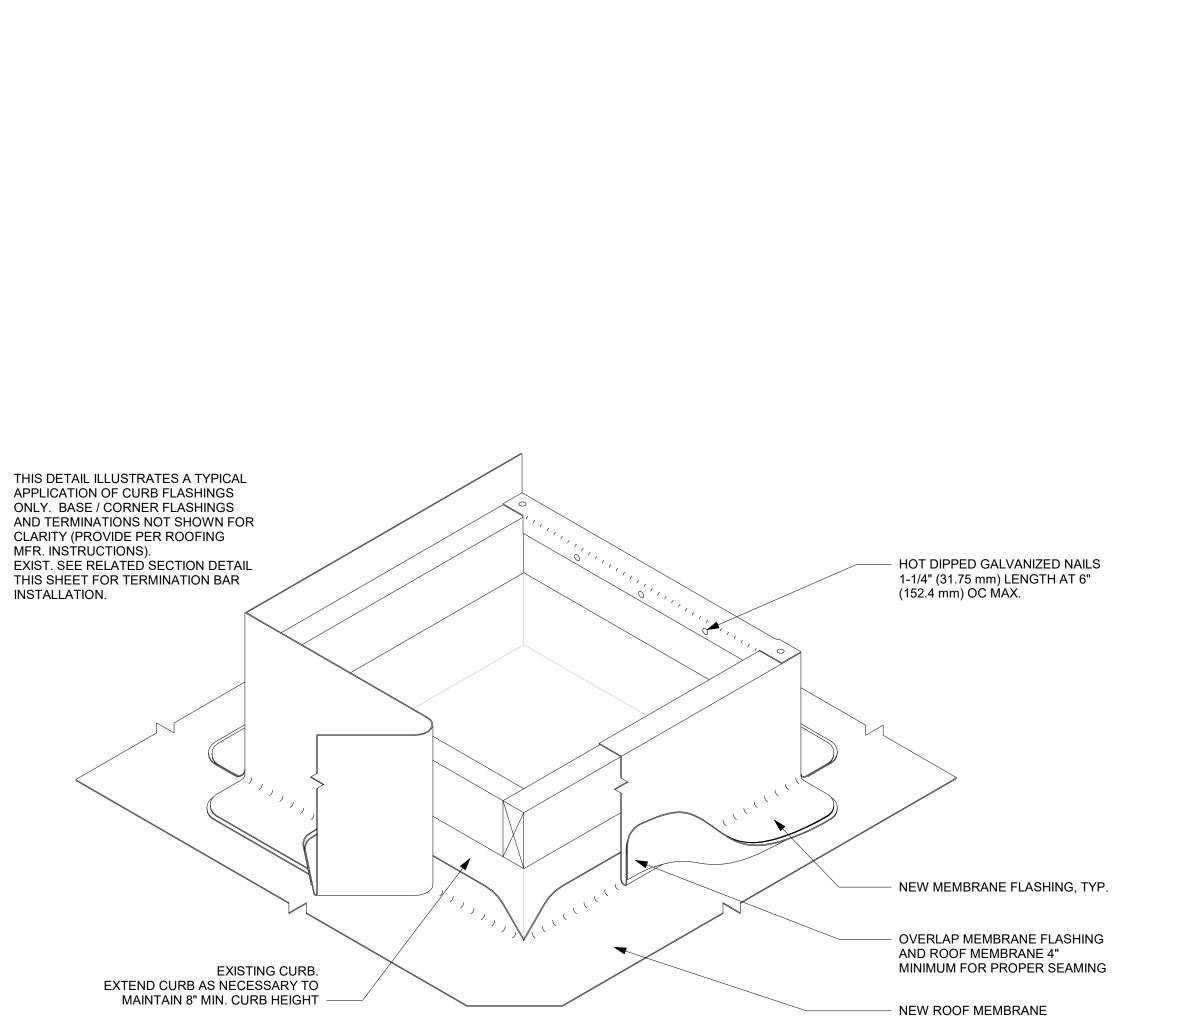L7 FLASHING APPLICATION ILLUSTRATION 6" = 1'-0"




SEE ROOF PLAN FOR ROOF TYPE ROOF MEMBRANE FLASHING TURN ROOF MEMBRANE DOWN FACE OF WALL PREFIN. METAL DRIP EDGE W/ CONT. CLEAT

REMOVE AND PROVIDE NEW GUTTER TO MATCH


## ATTACH TO EXISTING DOWNSPOUTS. WOOD BLOCKING AS REQ'D. - EXIST. WOOD BLOCKING TO REMAIN

EXISTING FINISH & CONFIGURATION, TYP.

EXIST. ROOF DECK TO REMAIN EXIST. FASCIA TO REMAIN

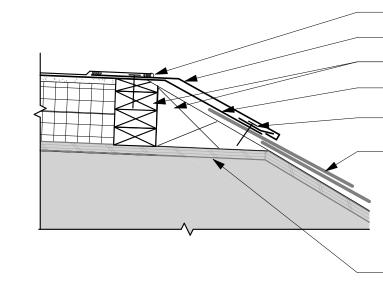


G14 SECTION DETAIL - MEMBRANE TO SHINGLE 1 1/2" = 1'-0"

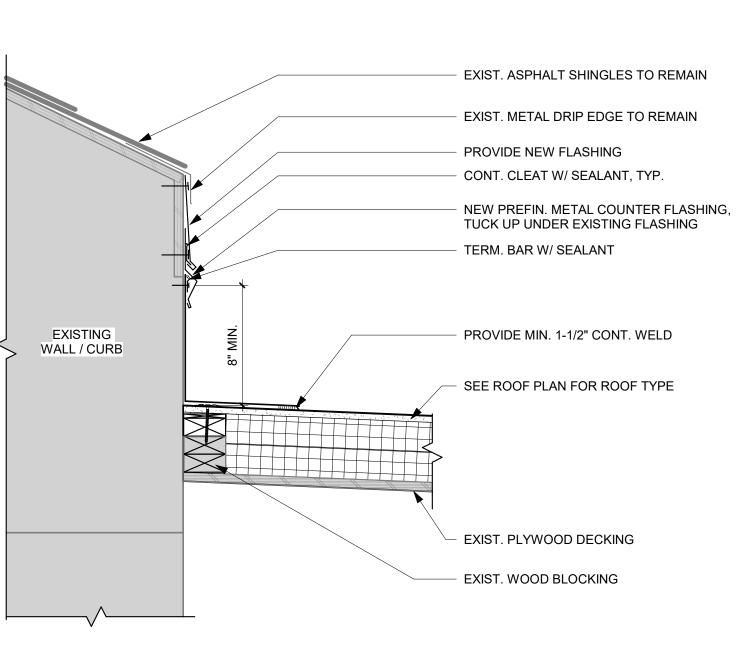

## A7 SECTION DETAIL - SHINGLE ROOF / WALL / CURB FLASHING 1 1/2" = 1'-0"

1 2 3 4 5 6 7 8 9 10 11 12 13 14 15 16 17 18 19 20 21

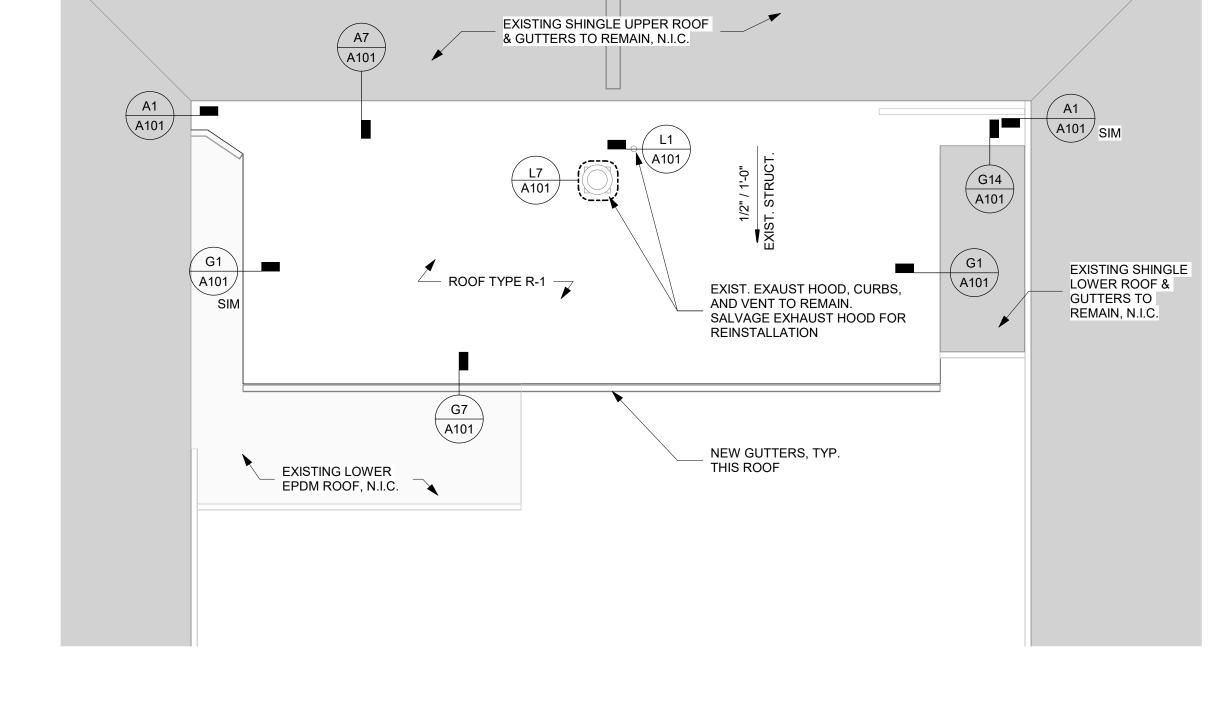

22

23 24

- EXIST. PLYWOOD DECKING TO REMAIN

WOOD BLOCKING AS REQ'D TURN ROOF MEMBRANE DOWN SLOPE - CONT. CLEAT - EXIST. ASPHALT SHINGLES TO REMAIN

PREFIN. METAL FLASHING (NO JOINTS)

ROOF MEMBRANE FLASHING

 1
 2
 3
 4
 5
 6
 7
 18
 19
 20
 21
 22
 23
 24
 25

ROOF TYPES LEGEND R-1 SINGLE-PLY MEMBRANE - 60 MIL EPDM ROOF MEMBRANE FULLY ADHERED TO COVERBOARD - 1/2" HIGH DENSITY POLYISOCYANURATE COVERBOARD - (2) LAYERS 2.5" POLYISOCYANURATE Des Moines, IA 50309 RÍGID ROOF INSULATION - MIN R30 - VAPOR BARRIER P: 515-309-0722 - EXISTING PLYWOOD ROOF DECK NOTE: CONTRACTOR TO VERIFY CONDITION OF EXISTING ROOF

DECKING. REPLACE PANELS EXHIBITING SWELLING, BIOLOGICAL GROWTH, OR HIGH MOISTURE CONTENT (ABOVE 19%)



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Project 9375.00 - DOC 5JD FT DES MOINES BLDG 65-66 ROOF REPLACEMENT 68 THAYER ST


DES MOINES, IA 50315

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Revision Description



OPN Project No. 24805001

Sheet Issue Date **BID SET** 

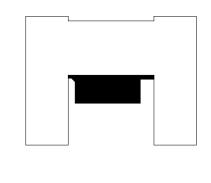05/22/24

Sheet Name **ROOF PLAN AND DETAILS** 

Sheet Number

| 25

A101